ABBREVIATIONS

A/C AIR CONDITIONING ACOUSTICAL CEILING TILE ADJUSTABLE AFF ABOVE FINISHED FLOOR

AMP AMPERE ARCH ARCHITECT

BOH BACK OF HOUSE

CAB CABINET CENTER LINE CEILING STARBUCKS CM CONSTRUCTION MANAGER

CENTER CX COMMISSIONING

CXA COMMISSIONING AGENT

DEG DEGREE DET DETAIL DIA DIAMETER

DIMENSION STARBUCKS DESIGN MANAGER

DOWN EACH EΑ ELEVATION EQ EQUAL

EXIST EXISTING

EXT EXTERIOR

FF&E FURNITURE. FIXTURE, AND EQUIPMENT

FLR FLOOR FOH FRONT OF HOUSE FOIC FURNISHED BY OWNER **INSTALLED BY CONTRACTOR**

FOIO FURNISHED BY OWNER INSTALLED BY OWNER FT FOOT/FEET

GROUND GENERAL CONTRACTOR GWB GYPSUM WALLBOARD

HC HOLLOW CORE HDW HARDWARE HOLLOW METAL HORIZ HORIZONTAL

HR HOUR HT HEIGHT HVAC HEATING, VENTILATING AND AIR CONDITIONING

I.D. INSIDE DIAMETER

LEED LEADERSHIP IN ENERGY AND ENVIRONMENTAL DESIGN LANDLORD

LOW VOLTAGE

MAX MAXIMUM "MECHANICAL, ELECTRICAL AND PLUMBING'

MFR MANUFACTURER MIN MINIMUM

NIC NOT IN CONTRACT NIGHT LIGHT NTS NOT TO SCALE

OC ON CENTER O.D. OUTSIDE DIAMETER

PLC PLACE

RADIUS REF REFERENCE

REQ'D REQUIRED REV REVISION RND ROUND

STARBUCKS SOLID CORE SQUARE FEET SHEET

SIM SIMILAR SPEC SPECIFICATION SQ SQUARE

TEMP TEMPORARY TYP TYPICAL


UC UNDER COUNTER UNO UNLESS NOTED OTHERWISE

VERT VERTICAL VIF VERIFY IN FIELD

RESPONSIBILITY LEGEND


GC GENERAL CONTRACTOR LL LANDLORD SB STARBUCKS

ARCHITECTURAL SYMBOL LEGEND

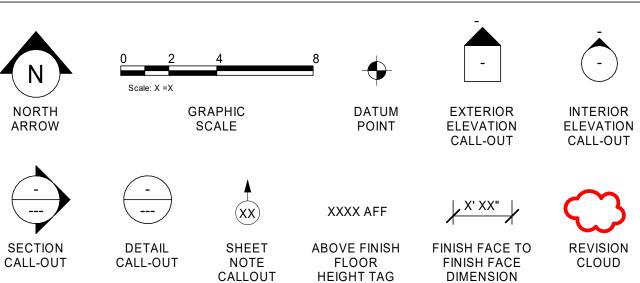


PXXX-ES XXXXXX DXXXXX (WXXXXX) PAINT DOOR REVISION DESIGN ID WINDOW TAG TAG TAG TAG TAG

AERIAL MAP

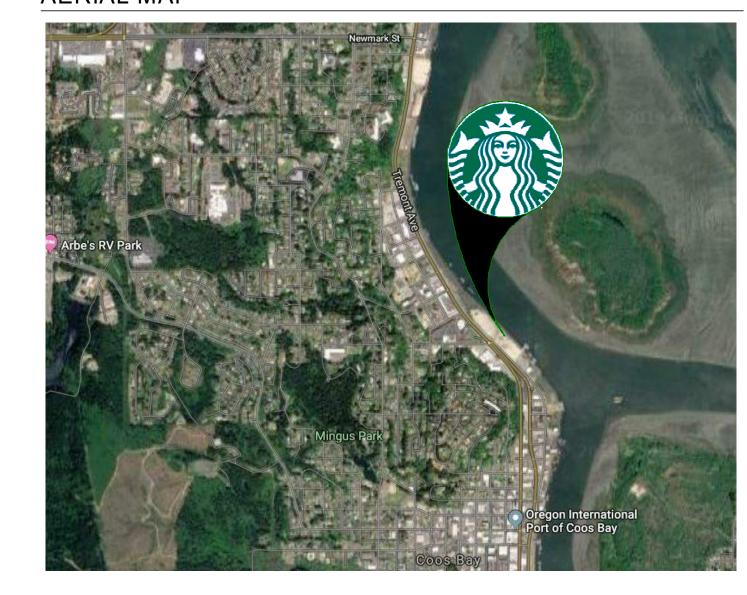

VICINITY PLAN

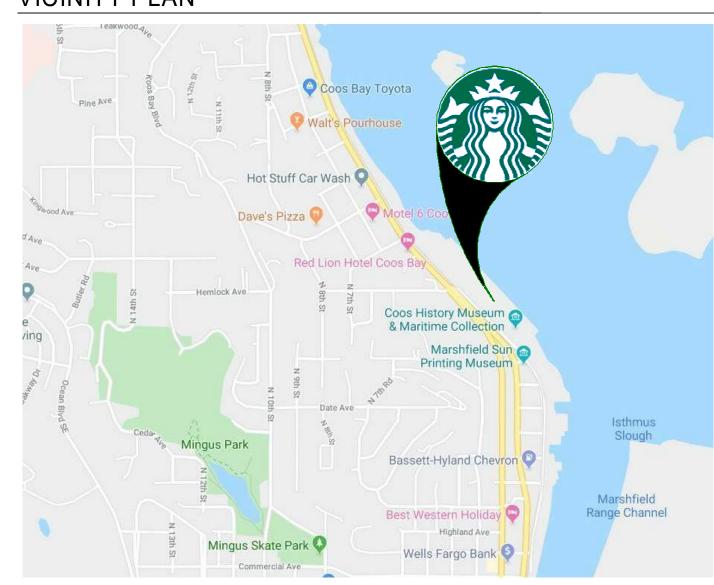

PROJECT CONTACTS

MAILING STARBUCKS COFFEE COMPANY ADDRESS: 2401 UTAH AVENUE SOUTH MS STOP: S-SD10

SEATTLE, WASHINGTON 98134 (206) 318-1575

DESIGN RYAN WONG MANAGER: STARBUCKS COFFEE COMPANY 2401 UTAH AVENUE SOUTH MS STOP: S-SD10

SEATTLE, WASHINGTON 98134 (206) 318-0019

ARCHITECT

OF RECORD:

CONSTRUCTION RON BLANCHETTE MANAGER: STARBUCKS COFFEE COMPANY 2401 UTAH AVENUE SOUTH MS STOP: S-SD10

SEATTLE, WASHINGTON 98134 (503) 572-4345

GPD ENGINEERING & ARCHITECTURE PROFESISONAL CORPORATION 520 SOUTH MAIN ST. SUITE 2531 AKRON, OH 44311 330-572-3611

CONTACT: TONY WAHL AWAHL@GPDGROUP.COM **GPD ENGINEERING &** CONSULTANT ARCHITECTURE PROFESISONAL OF RECORD:

CORPORATION 520 SOUTH MAIN ST. SUITE 2531 AKRON, OH 44311 330-572-3611

STRUCTURAL **GPD ENGINEERING &** ARCHITECTURE PROFESISONAL **CONSULTANT:** CORPORATION 520 SOUTH MAIN ST. SUITE 2531

AKRON, OH 44311

330-572-3611

SCOPE OF WORK

NEW PROPOSED TENANT IMPROVEMENT FOR NEW STARBUCKS STORE W/ DRIVE-THRU.

INTERIOR SCOPE OF WORK INCLUDES INTERIOR WALLS, WALL FINISHES, FURNITURE, FIXTURES, EQUIPMENT, CASEWORK, AND ACCESSIBLE RESTROOMS.

EXTERIOR SCOPE OF WORK INCLUDES BUILDING SIGNAGE, DRIVE-THRU EQUIPMENT. IT ALSO INCLUDES EXTERIOR FURNITURE.

SIGNAGE AND DRIVE-THRU EQUIPMENT PERMITTED SEPARATELY.

GENERAL NOTES

- 1. THE DRAWINGS AND PROJECT MANUAL TOGETHER CONSTITUTE THE CONTRACT DOCUMENTS FOR CONSTRUCTION. ALL GENERAL REQUIREMENTS ARE TO BE MET AND ALL MATERIALS, FINISHES AND SYSTEMS ARE TO BE INSTALLED AND PERFORM PER SPECIFICATIONS UNLESS OTHERWISE NOTED.
- 2. GENERAL CONTRACTOR SHALL VISIT THE SITE, REVIEW THE BUILDING SHELL DRAWINGS AS SUBMITTED BY THE LANDLORD OR STARBUCKS AND BECOME THOROUGHLY FAMILIAR WITH THE SITE CONDITIONS PRIOR TO CONSTRUCTION.
- 3. GENERAL CONTRACTOR SHALL CONSULT WITH STARBUCKS CONSTRUCTION MANAGER TO RESOLVE ANY CHANGES, OMISSIONS OR PLAN DISCREPANCIES PRIOR TO CONSTRUCTION.
- 4. ALL WORK SHALL BE PERFORMED IN STRICT COMPLIANCE WITH LOCAL, COUNTY, STATE AND FEDERAL CODES AND ORDINANCES.
- 5. GENERAL CONTRACTOR SHALL VERIFY THE LOCATION OF ALL UTILITIES.
- 6. GENERAL CONTRACTOR TO VERIFY ALL DIMENSIONS, INCLUDING CLEARANCES REQUIRED BY OTHER TRADES AND NOTIFY STARBUCKS CONSTRUCTION MANAGER OF ANY DISCREPANCIES PRIOR TO PROCEEDING WITH THE WORK. ALL DIMENSIONS ARE TO THE FACE OF THE FINISHED SURFACE UNLESS NOTED OTHERWISE. ALL DIMENSIONS TO BE TAKEN FROM DESIGNATED DATUM POINT. DO NOT SCALE DRAWINGS.
- 7. GENERAL CONTRACTOR SHALL PATCH AND REPAIR ALL EXISTING WALLS, FLOORS, CEILINGS, OR OTHER SURFACES IDENTIFIED TO REMAIN THAT MAY BECOME DAMAGED DURING THE COURSE OF THE
- 8. THE GENERAL CONTRACTOR IS RESPONSIBLE FOR OBTAINING PERMITS FOR FIRE PROTECTION, PLUMBING, MECHANICAL, AND ELECTRICAL SYSTEMS PRIOR TO INSTALLATION OF SUCH SYSTEMS.
- 9. GENERAL CONTRACTOR SHALL RETAIN ONE SET OF PERMIT PLANS ON-SITE TO DOCUMENT ALL CHANGES MADE DURING CONSTRUCTION. THE RECORD DRAWINGS SHALL BE ISSUED TO THE OWNER AT PROJECT CLOSE-OUT AS DESCRIBED IN THE GENERAL REQUIREMENTS OF THE PROJECT MANUAL.
- 10. GENERAL CONTRACTOR IS RESPONSIBLE FOR COORDINATING DELIVERY OF MATERIALS FROM STARBUCKS CONTRACTED THIRD PARTY LOGISTICS DISTRIBUTION SERVICES AND VENDOR DIRECT SHIPMENTS. SEE THE PROJECT MANUAL FOR ADDITIONAL INFORMATION.
- 11. RESPONSIBILITY FOR SUPPLY AND DELIVERY OF MATERIALS AND EQUIPMENT IS IDENTIFIED IN THE DRAWING SCHEDULE SHEETS UNDER THE COLUMN LABELED "RESPONSIBILITY".
- 12. FOR THE PURPOSE OF THE DOCUMENTS, TO "INSTALL", SHALL MEAN TO PROVIDE ALL FASTENERS, MISCELLANEOUS HARDWARE, BLOCKING, ELECTRICAL CONNECTIONS, PLUMBING CONNECTIONS AND OTHER ITEMS REQUIRED FOR A COMPLETE AND OPERATIONAL INSTALLATION, UNLESS OTHERWISE NOTED.
- 13. ALL ITEM SUBSTITUTIONS MUST BE APPROVED BY THE STARBUCKS CONSTRUCTION MANAGER.

SITE INFORMATION

CODE AUTHORITIES: CITY OF COOS BAY BUILDING CODE: 2019 OREGON STRUCTURAL SPECIALTY CODE

PLUMBING CODE: 2017 OREGON PLUMBING SPECIALTY CODE MECHANICAL CODE: 2019 OREGON MECHANICAL SPECIALTY

ELECTRICAL CODE: 2017 OREGON ELECTRICAL SPECIALTY

ENERGY CODE: 2019 OREGON ZERO ENERGY READY COMMERCIAL CODE

2019 OREGON FIRE CODE

HEALTH CODE: OREGON HEALTH CODE ACCESSIBILITY CODE: 2009 ICC / ANSI A117.1

ZONING:

FIRE CODE:

SPRINKLED: YES LEASABLE AREA: 1,859 CONSTRUCTION TYPE: V-B OCCUPANCY TYPE: A-2 NO CHANGE

PROPOSED USE: RETAIL SALES AND SERVICES

40

2,100 SF

1,859 SF

DEFERRED SUBMITTALS: SIGNAGE

OCCUPANCY LOAD: 60 INDOOR SEATING / CAFE: 677 SF / 15 = 45 RETAIL / SALES: 290 SF / 30 = 10 BACKBAR: 375 SF / 200= 2 WORKROOM: 375 SF / 300 = 2

RESTROOM / VESTIBULES: 141 SF / 300 = 1

TOTAL INTERIOR OCCUPANT LOAD: **TOTAL INTERIOR SEATING: TOTAL EXTERIOR SEATING:** TOTAL GROSS SQUARE FOOTAGE: TOTAL NET SQUARE FOOTAGE:

INDEX OF SHEETS

LEGEND: X - SHEET ISSUED R - SHEET ISSUED FOR REFERENCE AND COORDINATION ONLY SEE TITLEBLOCK FOR REVISION ISSUE DATE(S) SHEET SHEET TITLE

GENERAL G001 GENERAL INFORMATION G002 GENERAL INFORMATION |X|X|G003 LIFE SAFETY AND ACCESSIBILITY PLAN XX G004 HEALTH DEPARTMENT PLAN | X | X | |

ARCHITECTURAL A001 ARCHITECTURAL SITE PLAN A002 ARCHITECTURAL SITE DETAILS |X|X|A003 ARCHITECTURAL SITE DETAILS A101 BUILDING FLOOR PLAN | X | X | A102 BUILDING FLOOR PENETRATION PLAN | X | X | A103 BUILDING ROOF PLAN $X \mid X \mid$ A201 BUILDING EXTERIOR ELEVATIONS XX A202 BUILDING EXTERIOR ELEVATIONS |X|X|A602 WINDOW AND DOOR SCHEDULES & DETAILS | X | X |

INTEDIODO

INTERIOR	S			
I101	FF & E PLAN	X	X	
I102	CASEWORK PLAN	X	X	
I103	REFLECTED CEILING PLAN	X	X	
I103B	LIGHTING PLAN	X	X	
I104	INTERIOR FINISH PLAN	X	X	
1201	INTERIOR FINISH ELEVATIONS	X	X	
1202	INTERIOR FINISH ELEVATIONS	X	X	
1203	INTERIOR FINISH ELEVATIONS	X	X	
1204	INTERIOR FINISH ELEVATIONS	X	X	
1205	INTERIOR FINISH ELEVATIONS	X	X	
I401	RESTROOM PLAN & ELEVATIONS	X	X	
I501	INTERIOR DETAILS	X	X	
1502	INTERIOR DETAILS	X	X	
1503	DESIGN DETAILS	X	Х	
1504	DESIGN DETAILS	X	X	
I601	CASEWORK AND FF&E SCHEDULES	X	Х	
1602	INTERIOR FINISHES & SITE SCHEDULES	X	Х	

STRUCTURAL S001 STRUCTURAL GENERAL NOTES | X | X | | S102 SOFFIT DETAILS / KEYPLAN | X | X | |

ELECTRICAL E001 ELECTRICAL NOTES E004 ELECTRICAL SITE PLAN $X \mid X \mid$ E101 POWER PLAN | X | X | E102 LIGHTING PLAN | X | X | E103 ENLARGED ELECTRICAL PLACEMENT PLAN XX E502 ELECTRICAL DETAILS | X | X | | E513 GENERAL ELECTRICAL - EMS, NO LIGHTING

E601 ELECTRICAL PANEL SCHEDULES

MECHANIC	CAL				
M001	MECHANICAL NOTES	Χ	Χ		
M101	MECHANICAL DESIGN PLAN	Χ	Χ		
M102	MECHANICAL ROOF PLAN	Χ	Χ		
M501	MECHANICAL DETAILS	Χ	Χ		

PLUMBING	G	
P001	PLUMBING NOTES	XX
P101	PLUMBING SUPPLY PLAN	X X
P102	PLUMBING WASTE & VENT PLAN	X X
P103	PLUMBING ISOMETRIC & SCHEDULE	X X
P104	PLUMBING UNDERSLAB PLAN	X X
P501	PLUMBING DETAILS	X X
P502	PLUMBING DETAILS	X X
P503	PLUMBING DETAILS	XX

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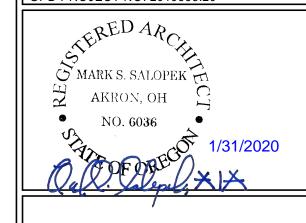
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STARBUCKS TEMPLATE VERSION: i2019-10-25



GPD PROJECT NO: 2019355.20



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STORE #: 60983 PROJECT #: 84073-001 ISSUE DATE: 01-29-20 - 100 percent DESIGN MANAGER: RYAN WONG PRODUCTION DESIGNER: GPD

Revision Schedule

Rev Date By Description

GENERAL INFORMATION

CHECKED BY:

SCALE: AS SHOWN

SHEET NUMBER:

G001

INDOOR S	EATING		
TYPE	DESCRIPTION	NUMBER OF ITEMS	TOTAL SEATS
01 SEAT	TABLE TOP, ROUND	2	4
02 SEAT	TABLE TOP, SQUARE/RECTANGLE	7	24
03 SEAT	COMMUNITY TABLE	1	8
04 SEAT	TABLE TOP OVAL	1	4

OUTDOOR SEATING			
TYPE	DESCRIPTION	NUMBER OF ITEMS	TOTAL SEATS
05 SEAT	TABLE TOP, ROUND	1	2
06 SEAT	TABLE TOP, SQUARE	3	6
07 SEAT	OTHER (ADA)	1	2

EGRESS CALCULATION	
EXIT WIDTH REQUIRED - 60 OCC X 0.2	= 12 IN.
EXIT WIDTH PROVIDED	= 114 IN.
EXITS	= 36 IN. PRIMARY ENTRY, 36 IN. SECONDARY ENTRY, 42 IN. WORKROOM
# EXITS REQUIRED	= 2
# EXITS PROVIDED	= 3
MAXIMUM ALLOWABLE TRAVEL DISTANCE	= 75 FT.
MAXIMUM TRAVEL DISTANCE PROVIDED	= 42 FT.
MINIMUM EXIT SEPARATION	= 74' - 11". (MAXIMUM DIAGONAL) / 2 = 37' - 5.5"
EXIT SEPARATION PROVIDED	= 44' - 1.25"

ROOM SCHEDULE

<u>NAME</u>	AREA
BACKBAR	376 SF
CAFE	967 SF
MEN'S RESTROOM	49 SF
RESTROOM VESTIBULE	44 SF
WOMEN'S RESTROOM	48 SF
WORKROOM	374 SF
GRAND TOTAL	1859 SF

OCCUPANCY NOTES

OCCUPANCY CLASSIFICATION: A-2 60

TOTAL OCCUPANTS:

OCCUPANCY	
CAFE: 677 SQ. FT. / 15 SQ. FT. / OCC	45 OCC
RETAIL: 290 SQ. FT. / 30 SQ. FT. / OCC	10 OCC
BAR: 375SQ. FT. / 200 SQ. FT. / OCC	2 OCC
WORKROOM: 375 SQ. FT. / 300 SQ. FT. / OCC	2 OCC
UNOCCUPIED: 141 SQ. FT. / 300 SQ. FT. / OCC	1 OCC
TOTAL OCC LOAD:	60 OCC

ACCESSIBLE SEATING

INTERIOR SEATING: 40 SEATS X 5% = 2 ADA REQUIRED (4 PROVIDED)

EXTERIOR SEATING:
10 SEATS X 5% = 1 ADA REQUIRED (1 PROVIDED)



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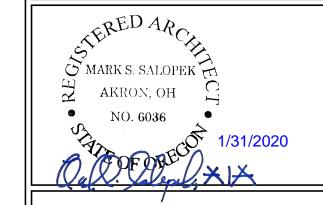
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STARBUCKS TEMPLATE VERSION: i2019-10-25



520 SOUTH MAIN ST, SUITE 2531 AKRON, OH 44311 P: 330-572-2100 F: 330-572-2101

GPD PROJECT NO: 2019355.20



PROJECT ADDRESS: 101, COOS BAY VILLAGE COOS BAY, OR 97420 PROJE HW

STORE #: 60983 PROJECT #: 84073-001 ISSUE DATE: 01-29-20 - 100 percent DESIGN MANAGER: RYAN
PRODUCTION DESIGNER: GPD
CHECKED BY: TC RYAN WONG

Revision Schedule		
Date	Ву	Description

GENERAL INFORMATION

SCALE: AS SHOWN

SHEET NUMBER:

G002


PLUMBING FIXTURE CALCULATION CHAPTER 29-29023 (FOR REFERNCE ONLY) MALE **FEMALE** TOTAL OCCUPANCY 30 OCC 30 OCC 60 OCC WATERCLOSETS **LAVATORIES WATER FOUNTAIN** FREE WATER PROVIDED 1 / 25 OCC 1 / 40 OCC. **FIXTURES** 1 WC PER M 1 WC PER F 1 LAV PER M REQUIRED: 1 LAV PER F PROVIDED: 1 WC PER M 1 WC PER F 1 LAV PER M 1 LAV PER F


Scale: 3/16" = 1'-0"

1 LIFE SAFETY PLAN

Scale: 3/16" = 1'-0"



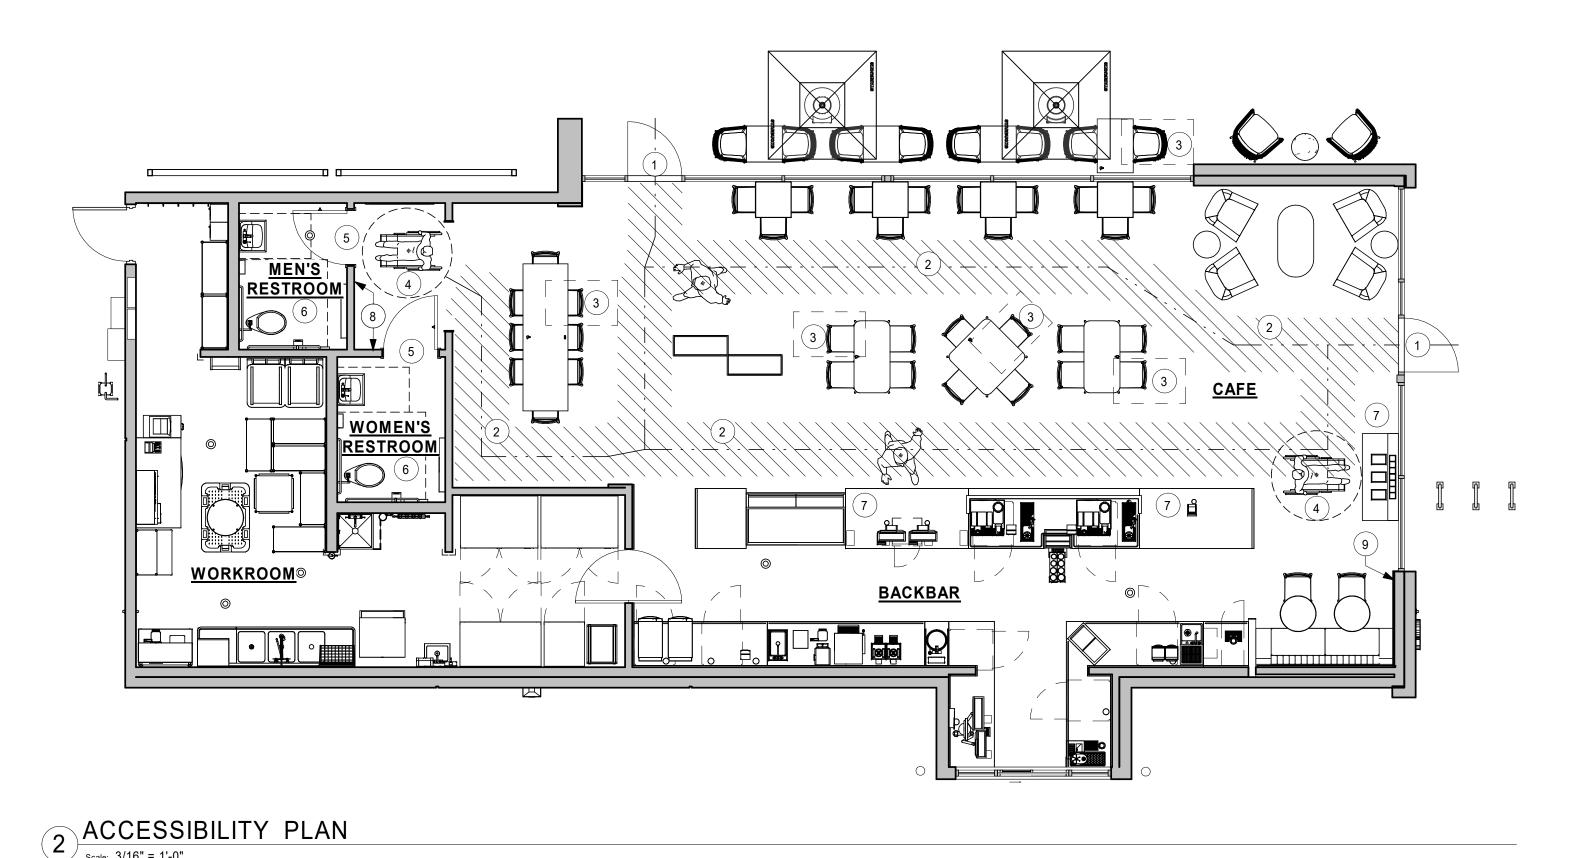

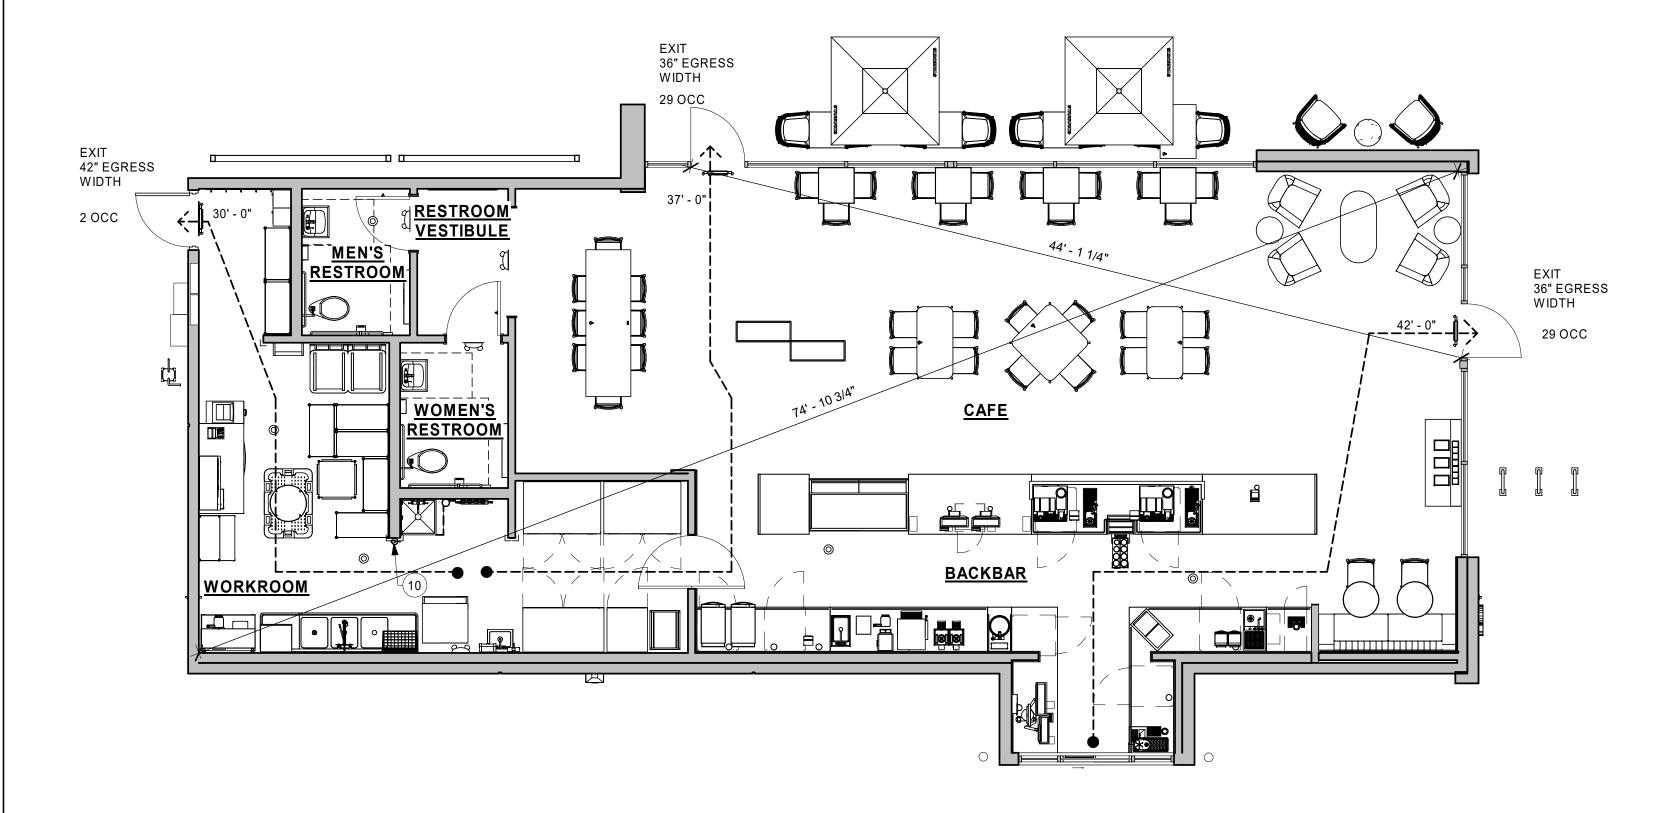

KEYED NOTES

- 1. THRESHOLDS TO BE BARRIER FREE COMPLIANT PER ALL APPLICABLE CODES.
- 2. BARRIER-FREE PATH OF TRAVEL.
- 3. 30" (160 MM) X 48" (1220 MM) CLEAR FOR WHEELCHAIR ACCESS.
- 4. 60" (1525 MM) DIAMETER MINIMUM TURN RADIUS FOR WHEELCHAIR ACCESS.
- 5. 32" (815 MM) MINIMUM CLEAR AT RESTROOM DOOR.
- 6. SEE ENLARGED RESTROOM PLAN AND ELEVATIONS SHEET(S) FOR ADDITIONAL INFORMATION ON ACCESSIBLE RESTROOM CLEARANCES.
- 7. POS TRANSACTION PLANE, CONDIMENT CART TOP AND HAND-OFF PLANE ARE 34 INCHES (860 MM) ABOVE THE FINISHED FLOOR FOR WHEELCHAIR ACCESSIBILITY.
- 8. PROVIDE BARRIER-FREE SIGNAGE AT ADA RESTROOMS PER ALL APPLICABLE CODES.
- 9. PROVIDE & POST OCCUPANT LOAD SIGNAGE, PER IBC 1004.3.
- 10. FIRE EXTINGUISHER LOCATION. G.C. TO CONFIRM LOCATION WITH INSPECTOR.

ROOM SCHEDULE

NAME	AREA
BACKBAR	376 SF
CAFE	967 SF
MEN'S RESTROOM	49 SF
RESTROOM VESTIBULE	44 SF
WOMEN'S RESTROOM	48 SF
WORKROOM	374 SF
GRAND TOTAL	1859 SF

MEANS OF EGRESS NOTES

- A. EVERY ROOM OR SPACE THAT IS ASSEMBLY OCCUPANCY SHALL HAVE THE OCCUPANT LOAD OF THE ROOM OR SPACE POSTED IN A CONSPICUOUS PLACE, NEAR THE MAIN EXIT ACCESS DOORWAY. POSTED SIGNS SHALL BE OF AN APPROVED LEGIBLE PERMANENT DESIGN AND SHALL BE MAINTAINED BY THE OWNER AUTHORIZED AGENT. (1004.3)
- B. EGRESS SHALL NOT PASS THROUGH KITCHENS, STORAGE ROOMS, CLOSETS OR SIMILAR SPACES. (1014.2)
- C. PANIC AND FIRE EXIT HARDWARE. WHERE INSTALLED ON DOORS IN THIS BUILDING SHALL SATISFY THE FOLLOWING (1008.1.10):
- 1) THE ACTUATION PORTION OF THE RELEASING DEVICE SHALL EXTEND AT LEAST ONE-HALF OF THE DOOR LEAF WIDTH.
- 2) THE MAXIMUM UNLATCHING FORCE DOES NOT EXCEED 15 POUNDS (6.8 KG).
- 3) PIVOTED OR BALANCED DOORS SHALL BE OF THE PUSH-PAD TYPE WHERE PANIC HARDWARE IS REQUIRED AND THE PAD SHALL NOT EXTEND ACROSS MORE THAN ONE-HALF OF THE DOOR WIDTH, MEASURED FROM THE LATCH SIDE.
- 4) PANIC HARDWARE LISTED IN ACCORDANCE WITH UL 305.
- 5) FIRE EXIT HARDWARE LISTED IN ACCORDANCE WITH UL 10C AND UL 305.
- D. STRUCTURAL ELEMENTS, FIXTURES OR FURNISHINGS SHALL NOT PROJECT HORIZONTALLY FROM EITHER SIDE MORE THAN 4 INCHES (100 MM) OVER ANY WALKING SURFACE BETWEEN 27 INCHES (685 MM) AND 80 INCHES (2030 MM) ABOVE THE WALKING SURFACE. EXCEPTION: HANDRAILS SERVING STAIRS AND RAMPS ARE PERMITTED TO PROTRUDE 4 1/2 INCHES (115 MM) FROM THE WALL. (1003.3.3)
- E. THE PATH OF EGRESS TRAVEL EXITS AND WITHIN EXITS IN THIS BUILDING SHALL BE IDENTIFIED BY EXIT SIGNS CONFORMING TO THE REQUIREMENTS OF SECTION 1011 AND AS NOTED BELOW:
- 1) EXIT SIGNS SHALL BE READILY VISIBLE FROM ANY DIRECTION OF EGRESS TRAVEL.
- 2) EXIT SIGNS SHALL BE LOCATED AS NECESSARY TO CLEARLY INDICATE THE DIRECTION OF EGRESS TRAVEL.
- 3) NO POINT IN A CORRIDOR SHALL BE MORE THAN 100 FT (30.5 M) OR THE LISTED VIEWING DISTANCE FOR THE SIGN, WHICHEVER IS LESS, FROM THE NEAREST VISIBLE EXIT SIGN.
- F. WHERE KEY OPERATED LOCKING DEVICES ARE USED, POST A SIGN ON OR ADJACENT TO THE REQUIRED MAIN EXIT DOOR WITH 1 INCH (25 MM) LETTERING STATING THAT "THIS DOOR TO REMAIN UNLOCKED WHEN BUILDING IS OCCUPIED". (1008.1.9.3)
- G. EGRESS DOORS OR GATES SHALL BE OPENABLE FROM THE EGRESS SIDE WITHOUT THE USE OF A KEY, SPECIAL KNOWLEDGE OR EFFORT. DOOR HANDLES, PULLS, LATCHES, LOCKS AND OTHER OPERATING DEVICES SHALL BE INSTALLED 34 INCHES (860 MM) TO 48 INCHES (1220 MM) ABOVE FINISHED FLOOR. MANUALLY OPERATED FLUSH BOLTS OR SURFACE BOLTS ARE NOT PERMITTED. THE UNLATCHING OF ANY DOOR OR LEAF SHALL NOT REQUIRE MORE THAN ONE OPERATION. (1008.1.9)
- H. LANDINGS SHALL BE PROVIDED ON EACH SIDE OF DOORS AND SUCH LANDING SHALL BE AT THE SAME ELEVATION ON EACH SIDE OF THE DOOR LANDINGS SHALL HAVE A WIDTH NOT LESS THAN THE WIDTH OF THE DOOR AND LENGTH MEASURED IN THE DIRECTION OF TRAVEL OF NOT LESS THAN 44 INCHES (11120 MM). (1008.1.5, 1008.1.6)

LEGEND

← X'-X"(XXMM) **→** TRAVEL DISTANCE BARRIER FREE PATH OF TRAVEL (MIN 3'-0" (915MM) - NO PINCH POINT) **EMERGENCY LIGHT** EXIT SIGN WITH LIGHTING

FIRE EXTINGUISHER



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BOTH PARTIES. STARBUCKS TEMPLATE VERSION: i2019-10-25


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WRITTEN AGREEMENT IS FULLY EXECUTED BY



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GPD PROJECT NO: 2019355.20



 $\ddot{\circ}$ 101, COO T PR

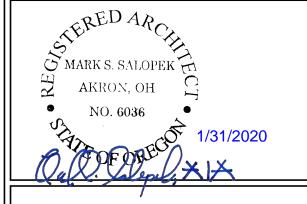STORE #: 60983 84073-001 PROJECT #: ISSUE DATE: 01-29-20 - 100 percent DESIGN MANAGER: RYAN WONG

PRODUCTION DESIGNER: GPD

CHECKED BY:

Revision Schedule

LIFE SAFETY AND ACCESSIBILITY PLAN


SCALE: AS SHOWN SHEET NUMBER:

G003

	SP	ECIALTY EQUIPMENT SCHEDULE - "E" (HEALTH DE	PT)
DESIGN ID	COUNT	DESCRIPTION	COMMENTS
DESIGN ID	COUNT	DESCRIPTION	COMMINICIATS
20178	27	ACOUSTIC CEILING PANEL	TECTUM DIRECT ATTACHED CEILING PANEL. MOUNTED BETWEEN TRUSSES. 8175T10 BY ARMSTRONG. GC TO FIELD PAINT SW9140 BLUSTERY SKY
X5001	7	METAL WALL CAP (MT0011)	
COOLING			
10267	5	FRIDGE UNDERCOUNTER 1 DOOR - 27IN 685MM	
11083	2	FRIDGE REACH IN 2 DOOR - 51X35IN 1295X890MM	
12618	2	FRIDGE UNDERCOUNTER 1 DOOR WITH SHELF - 27IN 685MM	
13620	1	FREEZER REACH IN 1 DOOR LH - 27IN 685MM	
13682	1	FREEZER REACH IN 2 DOOR - 54IN 1370MM	
20010	1	FRIDGE NITRO 2 TAP JT NITCOM LH	KIT INCLUDES UNDERCOUNTER FRIDGE, FONT, TRAY, AND TUBING
EQUIPMENT			
10312	2	BREWER SOFT HEAT WARMING STAND SINGLE	
10746	1	BREWER DUAL SOFT HEAT	
10808	2	GRINDER DITTING KR1203	
10856	4	BREWER SERVER SOFT HEAT	
10907	1	DISHWASHER LEGS AND SKIRT	
12407	2	OVEN TURBOCHEF NEXT GENERATION	
12508	2	BLENDER QUIET MODEL ON COUNTER	
15186	1	DISHWASHER HOT LOW STEAM	
16623	2	SCALE DIGITAL WITH ADJUSTABLE DISPLAY MOUNT SMALL	
17564	1	BLENDER PITCHER RINSER WITH SENSOR	
19559	1	NITROGEN GENERATOR ELEMENT	
19742	2	ESPRESSO MACHINE MASTRENA II	
FOOD CASE	-		•
16238	1	FOOD CASE - ZEPHYR - 66IN 1675MM	
ICE		•	-

	J.	ECIALTY EQUIPMENT SCHEDULE - "E" (HEALTH DE	,
DESIGN ID	COUNT	DESCRIPTION	COMMENTS
10102	1	ICE - BIN B55	
10229	1	ICE - MACHINE ICE1506HR REMOTE COOLED	
10344	1	ICE - BIN DROP IN 90LB 40KG	
19278	1	ICE - BIN DROP IN 45LB 20KG HORIZONTAL	
OTHER			
10091	1	CUP DISPENSER TALL HOT VERTICAL	
10099	2	RESTROOM TOILET PAPER HOLDER	
10172	2	RESTROOM SEAT COVER DISPENSER	
10179	2	HAND DRYER SURFACE MOUNTED	
10384	2	DIAPER CHANGING STATION HORIZONTAL	
10396	1	CUP DISPENSER SHORT HOT VERTICAL	
10467	1	FILE CABINET 2 DRAWER	
10501	1	FIRE EXTINGUISHER	
10769	2	RESTROOM GRAB BAR VERTICAL - 18IN 455MM	
10791	2	CUP DISPENSER GRANDE VENTI COLD VERTICAL	
10829	5	CORNER GUARD - 1.25IN 30MM - PEWTER	BOH ONLY
10855	2	CUP DISPENSER GRANDE VENTI HOT VERTICAL	
10858	1	CUP DISPENSER TALL COLD VERTICAL	
10859	2	RESTROOM GRAB BAR - 48IN 1220MM	
10862	2	RESTROOM GRAB BAR - 36IN 915MM	
10947	1	SOAP DISPENSER WALL MOUNTED	
10977	1	PAPER TOWEL DISPENSER FULL SIZE - TRANSLUCENT GRAY	
10992	1	PAPER TOWEL DISPENSER HALF SIZE - TRANSLUCENT GRAY	
11115	3	SOAP DISPENSER SINK MOUNTED	
13330	1	MOBILE CUP DISPENSER CADDY	
13584	1	CUP DISPENSER TRENTA COLD VERTICAL	
19495	1	NITRO 2 TAP HANDLE AND BADGE KIT	
20079	1	NITRO 2 TAP BADGE MOUNT BACKBAR LH	
20080	1	NITRO 2 TAP BADGE MOUNT BACKBAR RH	
X07403	1	ROOF ACCESS LADDER	
STORAGE			
10222	1	WIRE SHELF GRID AT SINK	
10416	7	WORKROOM SHELVING - 36IN 915MM	
10462	7	WORKROOM SHELVING POSTS	
10698	1	MOP RACK WITH 3 HOLDERS	
13578	1	DISHWARE DRYING RACK - 21IN 535MM	
15699	1	PARTNER WORK CENTER	
17264	1	ROLLING PASTRY TRAY THAW RACK - 20X26IN 510X660MM	
17639	1	WORKROOM CART - 24IN 610MM	
19476	2	5 COMP LOCKER - 12IN 305MM	

DESIGN ID COUNT DESCRIPTION COMMENTS							
DESIGN ID	COUNT	DESCRIPTION	COMMENTS				
X0101	6	FLOOR CLEANOUT	ZURN ZN1400, ADJUSTABLE FLOOR CLEANOUT, NICKEL BRONZE FRAME AND COVER.				
X0102	2	FLOOR DRAIN	ZURN FD2209, ADJUSTABLE FLOOR DRAIN, 3" HUB OUTLET, NICKLE BRONZE TOP.				
X0103	1	GREASE INTERCEPTOR 75 GPM	SCHIER MODEL GB-75, 75 GPM, 125 GAL. LIQUID CAPACITY				
X0104	1	RECIRCULATING PUMP	BELL AND GOSSET MODEL NBF-18S, 120V, 100 WATT, WITH AQUASTAT				
DRAIN							
10294	4	DRAIN - FLOOR SINK SQUARE - 12IN 305MM	ZURN FD2372-H, A.R.E. FLOOR SINK WITH 6" SUPM DEPTH AND 1/2 GRATE.				
10726	4	FLOOR SINK - GRATE HALF SQUARE - 12IN 305MM	ZURN FD2372-H, A.R.E. FLOOR SINK WITH 6" SUPM DEPTH AND 1/2 GRATE.				
FAUCET							
10152	1	FAUCET - DOUBLE LABORATORY WITH BENT RISER SPOUT					
10153	1	FAUCET - WATER TOWER - 12IN 305MM					
10215	2	FAUCET - DOUBLE LABORATORY WITH SWING SPOUT					
10447	1	FAUCET - PRE RINSE SPRAYER WALL MOUNTED	1.2 GPM FLOW RATE				
10597	3	FAUCET - SINGLE HANDLE	0.5 GPM FLOW RATE				
10804	1	FAUCET - PRE RINSE SWING SPOUT					
10874	1	FAUCET - HOT WATER DISPENSER GOOSENECK					
10922	1	FAUCET - MOP SINK WALL MOUNTED					
11003	2	FAUCET - METERED	METERED				
13588	1	FAUCET - HAND SINK WALL MOUNTED					
15749	2	FAUCET - HOT AND COLD WATER SYSTEM					
17569	1	FAUCET - WARE RINSER IN COUNTER - 24X9IN 600X235MM					
17572	1	FAUCET - TAP SINGLE HANDLE					

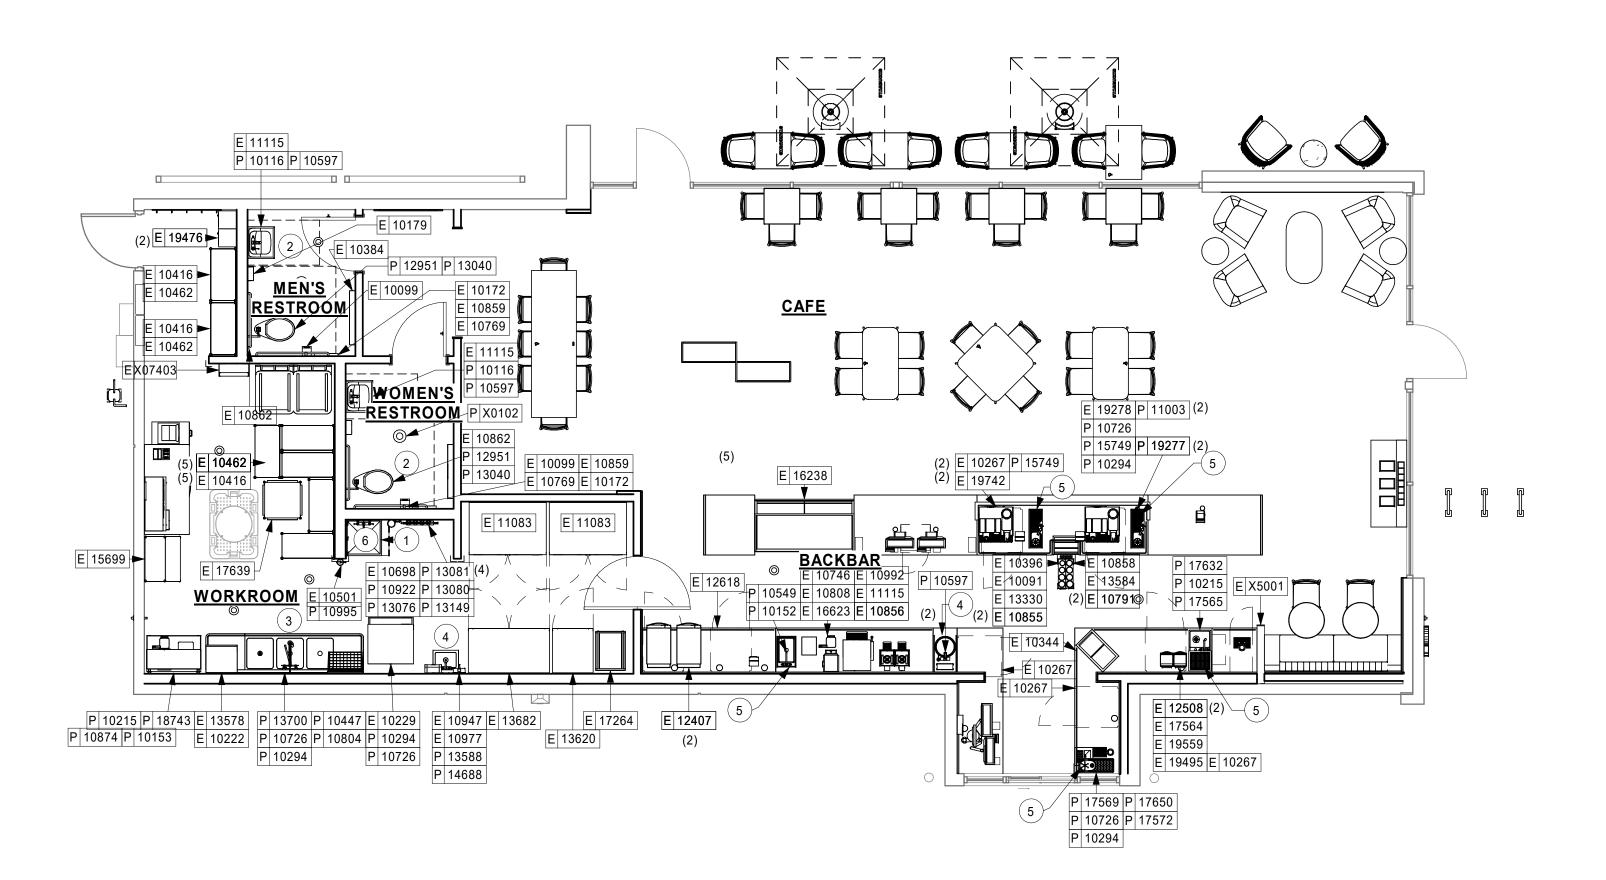





HEALTH DEPT. FINISH SCHEDULE

FLOOR: SEALED CONCRETE

WALL: LAMINATE, WOOD CLADDING, BACKSPLASH, WITH 6" COVED

TILE BASE CEILING: GYPSUM SOFFIT

CAFE:

FLOOR: SEALED CONCRETE WITH WALK OFF MATS

WALL: STOREFRONT, WALL COVERING, PAINTED GYPSUM WALL BOARD WITH 6" COVED TILE BASE CEILING: GYPSUM SOFFIT & EXPOSED STRUCTURE

WORKROOM:

FLOOR: POLYVINYL FLOOR TILE - ECO-GRIP WALL: FRP WITH 6" COVED TILE BASE

CEILING: ACOUSTICAL TILE CEILING

RESTROOMS:

FLOOR: SEALED CONCRETE

WALL: WALL TILE

CEILING: GYPSUM CEILING

HEALTH DEPT. PLAN NOTES

A. GENERAL CONTRACTOR TO SCHEDULE WITH LOCAL REFRIGERATION CONTRACTOR TO CONDUCT INITIAL FOOD CASE START-UP AND TESTING. FOR APPROVED CONTRACTOR, CONTACT

B. THE SPACE IS SERVED BY THE MUNICIPAL WATER AND SEWER SYSTEM UNLESS OTHERWISE NOTED.

C. ALL EQUIPMENT AND INSTALLATION WILL MEET NATIONAL SANITATION FOUNDATION STANDARDS OR EQUIVALENT.

D. EQUIPMENT UNITS SHALL CONTAIN NO EXPOSED THREADS, EMBELLISHMENTS OR OVERHANGING EDGES THAT SERVE AS PLACES FOR ACCUMULATION OF DUST, DIRT AND DEBRIS.

E. WARMING OVEN(S) SHOWN FOR PERMITTING PURPOSES. INSTALLATION AT STORE OPENING TO BE VERIFIED BY STARBUCKS CONSTRUCTION REPRESENTATIVE.

F. EACH HAND WASHING SINK WILL HAVE A SINGLE SERVICE TOWEL AND SOAP DISPENSER, AND ALL HAND SINKS TO HAVE A COMBINATION FAUCET OR PREMIXING FAUCET.

G. SEE SHEETS I-6001 & I-6002 FOR SCHEDULES.

SHEET NOTES

- WATER HEATER ON SHELF ABOVE.
- 2. ADA COMPLIANT RESTROOM AND ACCESSORIES
- 3. 3-COMP SINK.
- 4. HAND SINK.
- WORK SINK.
- 6. MOP SINK.





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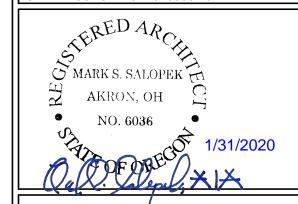
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STARBUCKS TEMPLATE VERSION: i2019-10-25



AKRON, OH 44311 P: 330-572-2100 F: 330-572-2101

GPD PROJECT NO: 2019355.20



S S ≻ - ADD 008 BA S S 101, COO A T

STORE #: 60983 PROJECT #: 84073-001

ISSUE DATE: 01-29-20 - 100 percent DESIGN MANAGER: RYAN WONG PRODUCTION DESIGNER: GPD

Revision Schedule

	Rev	Date	Ву	Description
1				
1				
1				
1				
-				

HEALTH DEPARTMENT

PLAN SCALE: AS SHOWN

G004

SHEET NUMBER:

CHECKED BY:

(15)S 14106

(13)S 14327

(11)|Y|14119|-

-|Y|20073 |Y|12147 |

2 A201

STARBUCKS

HWY 101 (OREGON COAST HIGHWAY)

(11)|Y|15700|Y|1/4116|-

Y 14163 Y 14093

KEYED NOTES

- 1. STARBUCKS PATIO / SEATING AREA.
- 2. HATCH INDICATES STARBUCKS TENANT SPACE.
- 3. SIDEWALKS, BY LL, ENSURE ACCESSIBLE PATH OF TRAVEL TO ENTRY.
- 4. MINIMUM 12'-0" WIDE 6" THICK INTEGRAL BLACK REINFORCED CONCRETE (6X6 10/10 WWF) DRIVE-THRU LANE WITH 6" CURB. EXTEND 12' BEYOND CENTERLINE OF DT WINDOW AND 12' BEFORE ORDER POINT. (BY LL)
- 5. TRASH ENCLOSURE, BY LL.
- 6. LANDSCAPE AREA, BY LL.
- 7. CROSSROAD SAFETY STRIPING ON PAVEMENT BY LL.
- 8. CANOPY ABOVE, BY LL.
- 9. HOSE BIBB (BY LL). LOCATION PER SHELL DRAWINGS, SEE SHELL DRAWINGS FOR ADDITIONAL INFORMATION.
- 10. NON-ILLUMINATED BOLLARD AND FOOTING, BY LL.
- 11. STARBUCKS DRIVE-THRU EQUIPMENT. ASSOCIATED FOUNDATION AND ELECTRICAL CONDUIT WITH PULL STRINGS BY LL, SEE STRUCTURAL AND ELECTRICAL DRAWINGS FOR ADDITIONAL INFORMATION.
- 12. OUTLINE OF CANOPY ABOVE DRIVE-THRU WINDOW,
- 13. SITE DIRECTIONAL SIGNAGE LOCATION. ASSOCIATED FOOTING AND ELECTRICAL CONDUIT WITH PULL STRINGS BY LL. SEE ELECTRICAL DRAWINGS.
- 14. ACCESSIBLE PARKING SPACES, BY LL.
- 15. DT CLEARANCE BAR LOCATION. ASSOCIATED FOOTING BY LL.
- 16. DT DETECTOR LOOP AT ORDER POINT AND DT WINDOW, BY LL, SEE ELECTRICAL FOR MORE INFORMATION.
- 17. HOOP BIKE RACK, BY LL. SEE SHELL BUILDING CONSTRUCTION DRAWINGS FOR DETAILS.
- 18. UMBRELLA AND BASE.
- 19. DRIVE-THRU WINDOW WITH AIR CURTAIN, BY LL.
- 20. DRIVE-THRU LANE ENTRY/EXIT THERMOGRAPHIC BY

21. SITE BOLLARD BY LL

GENERAL NOTES

- A. REFER TO EXTERIOR ELEVATIONS ON SHEET A201 FOR BUILDING SIGNAGE LOCATION AND DESIGN ID. REFER TO ELECTRICAL PLANS FOR ELECTRICAL REQUIREMENTS.
- B. LANDSCAPING TO BE PROVIDED PER ZONING CODE AND SUSTAINABILITY REQUIREMENTS.
- C. DRIVE-THRU EQUIPMENT INCLUDING VEHICLE DETECTION LOOP, WIRELESS COMMUNICATION AND MONITORS SHALL BE COORDINATED BY STARBUCKS CONSTRUCTION MANAGER. REFER TO ELECTRICAL DRAWINGS FOR ADDITIONAL REQUIREMENTS.
- D. PROVIDE 6" (150MM) THICK CONCRETE PAVING THE LENGTH OF THE DRIVE-THRU LANE, EXTENT TO INCLUDE DRIVE-THRU ENTRY POINT THROUGH WINDOW STANDING PAD.
- E. GENERAL CONTRACTOR TO APPLY CONCRETE SEALER TO ALL EXTERIOR CONCRETE PATIO AND

WALKWAY SURFACES.

- F. GENERAL CONTRACTOR TO VERIFY ALL EXISTING ELEVATIONS AND BUILDING CONDITIONS IN FIELD PRIOR TO START OF CONSTRUCTION.
- G. PROVIDE DETECTABLE WARNING (IF APPLICABLE PER LOCAL CODE) AT TRANSITION FROM SIDEWALK TO DRIVE AISLE.
- H. ACCESSIBLE PARKING SPACES AND ACCESS AISLES SHALL HAVE SURFACE SLOPE NOT TO EXCEED 2% IN ALL DIRECTIONS.
- I. REFER TO ELECTRICAL DRAWINGS FOR SITE RELATED ELECTRICAL WORK.
- J. SCRAPE AND REPAINT ALL EXISTING PAINTED SITE FEATURES, INCLUDING, BUT NOT LIMITED TO CURBS, BOLLARDS, RAILINGS AND SITE LIGHTING BASES.
- K. SEE SHEET A002 FOR ARCHITECTURAL SITE



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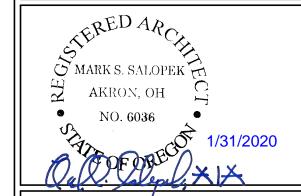
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STARBUCKS TEMPLATE VERSION: i2019-10-25



520 SOUTH MAIN ST, SUITE 2531 AKRON, OH 44311 P: 330-572-2100 F: 330-572-2101

GPD PROJECT NO: 2019355.20



STORE #: 60983 PROJECT #: 84073-001 **DESIGN MANAGER:** PRODUCTION DESIGNER: GPD

ARCHITECTURAL SITE PLAN

SCALE: AS SHOWN SHEET NUMBER:

CHECKED BY:

A001



	INTERIOR NEW WALL SCHEDULE								
TAG	DESCRIPTION	INSULATION	NOTES						
1-T-N	1 1/2" 20 GA STUD FURRING WALL	NONE	TERMINATE 6" ABOVE CEILING. SEE PLAN FOR WALL SHEATHING.						
3-F-A	3 5/8" 20 GA STUDS @ 16" O.C.	ACOUSTIC	FULL HT. WALL. SEE PLAN FOR WALL SHEATHING.						
3-F-N	3 5/8" 20 GA STUDS @ 16" O.C.	NONE	FULL HT. WALL. SEE PLAN FOR WALL SHEATHING.						
3-P-N	3 5/8" 16 GA STUDS @ 16" O.C.	NONE	PARTIAL HT. WALL W/ RCKW RIGID CONNECTORS AT FLOOR. SEE ELEVATIONS FOR WALL HT. SEE PLAN FOR WALL SHEATHING.						
3-T-N	3 5/8" 20 GA STUDS @ 16" O.C.	NONE	TERMINATE 6" ABOVE CEILING. PROVIDE 45 DEGREE METAL STUD BRACING AT 48" O.C. FROM STUD WALL TO STRUCTURE ABOVE. SEE PLAN FOR WALL SHEATHING.						
4-F-A	6" 20 GA STUDS @ 16" O.C.	ACOUSTIC	FULL HT. WALL. SEE PLAN FOR WALL SHEATHING.						
4-F-N	6" 20 GA STUDS @ 16" O.C.	NONE	FULL HT. WALL. SEE PLAN FOR WALL SHEATHING.						
4-T-N	6" 20 GA STUDS @ 16" O.C.	NONE	TERMINATE 6" ABOVE CEILING. PROVIDE 45 DEGREE METAL STUD BRACING AT 48" O.C. FROM STUD WALL TO STRUCTURE ABOVE. SEE PLAN FOR WALL SHEATHING.FINISH ONE SIDE ONLY						

6' - 7 1/4"

RESTROOM

3-F-A

5' - 5 1/2"

4-F-A

G

5' - 5 1/2"

RESTROOM VESTIBULE

WOMEN'S RESTROOM 6' - 3 1/4"

3-F-N 0

WALL BLOCKING KEY

SYMBOL	ITEM	WEIGHT	HEIGHT A.F.F.	APPROX. WIDTH
A	WORKROOM HAND SINK	128 LBS (58 KG)	36" TO 40" (915MM TO 1015MM)	30" (760MM) BEHIND SINK
B	SHELVES ABOVE COMPARTMENT SINK	200 LBS (91 KG)	48" TO 76" (1220MM TO 1930MM)	96" (2440MM) CENTERED ABOVE COMPARTMENT SINK
C	UPPER WIRE SHELVES	BLOC	CKING SPECIFICATION T	O BE PROVIDED BY VENDOR
D	SHELVES AT MANAGER'S DESK	300 LBS (136 KG)	32" TO 96" (810MM TO 2440MM)	48" (1220MM) 3/4 (19MM) ACX PLYWOOD, CENTERED ON SHELVES
E	EQUIPMENT RACK AT MANAGER'S DESK	300 LBS (136 KG)	44" TO 96" (1120MM TO 2440MM)	28" (710MM) 3/4 (19MM) ACX PLYWOOD, CENTERED ON RACK
F	METRO SHELVES	WALL BLO	KING SPECIFICATION TO BE PROVIDED BY VENDOR. IN- OCKING PREFERRED, HOWEVER EXISTING FRP FINISHE L MAY RECEIVE SURFACE MOUNTED, PAINTED WHITE.	
G	RESTROOM GRAB BARS	200 LBS (91 KG)	30" TO 36" (760MM TO 915MM)	60" (1525MM) AROUND WATER CLOSET
H	RESTROOM HAND SINK	200 LBS (91 KG)		LLATION REQUIRES CONCEALED FER TO MFR'S SPECIFICATION.
	MILLWORK BOXES	BLOCK		R FRENCH CLEATING SYSTEM.) DETAILS.
J	DIAPER CHANGING STATION	250 LBS (113 KG)	40 1/2" TO 46 1/2" (1030MM TO 1180MM)	32" (810MM) BEHIND STATION
K	WATER FILTRATION SYSTEM	TBD BY VENDOR	COORDINATE LOCAT	ION AND EXTENT WITH PENTAIR
	ALL ARTWORK, FIXTURES, ACCESSORIES AND CASEWORK FABRICATIONS NOT OTHERWISE NOTED	TBD BY VENDOR (VARIES)	ALL ITEMS FOR INSTALLATION. E	LL BLOCKING AS REQUIRED FOR A COMPLETE AND SECURE EXTEND BLOCKING 8" (205MM) EACH SIDE OF EACH ITEM.

KEYED NOTES

- 1. INSTALL NEW DOORS AS INDICATED. SEE SHEET A601 FOR DOOR AND HARDWARE TYPE.
- 2. OUTLINE OF BAR PER CASEWORK MANUFACTURER.
- 3. FIRE EXTINGUISHER LOCATION. G.C. TO CONFIRM LOCATION WITH INSPECTOR.
- 4. ELECTRICAL PANEL LOCATIONS. MAINTAIN MINIMUM CLEARANCE AS REQUIRED BY CODE.
- 5. ALIGN FACE OF FINISHED WALL.
- 6. SHELF FOR WATER HEATER ABOVE.
- 7. OUTLINE OF (2) MERCHANDISE DISPLAY.
- 8. OUTLINE OF COMMUNITY TABLE.
- 9. RECESSED WALK-OFF MAT.

9

10. LOCKERS TO BE SECURED TO WALL.

GENERAL NOTES

- A. GENERAL CONTRACTOR TO VERIFY ALL DIMENSIONS AND NOTIFY STARBUCKS CONSTRUCTION MANAGER OF ANY DISCREPANCIES PRIOR TO CONSTRUCTION. ALL DIMENSIONS TO BE TAKEN FROM DESIGNATED DATUM POINT.
- B. GENERAL CONTRACTOR TO PROVIDE FIRE TREATED WOOD STUD BLOCKING, OR EQUIVALENT TO SUPPORT ANY WALL ATTACHMENT AND/OR SIGNAGE.
- C. IF EXISTING EXTERIOR ENTRANCE THRESHOLD EXCEEDS MINIMUM BARRIER FREE PROVISION OF THE CODE, REMOVE AND REPLACE WITH ACCESSIBLE THRESHOLD. RAISED THRESHOLDS AND FLOOR LEVEL CHANGES AT ACCESSIBLE DOORWAYS TO BE BEVELED WITH A SLOPE NO GREATER THAN 1:12.
- D. ALL DIMENSIONS ARE TO FINISHED FACE UNLESS SHOWN OR NOTED OTHERWISE.
- E.. INSTALL MOISTURE RESISTANT GREEN BOARD ON BACKBAR WALL PER PROJECT MANUAL.
- F. ALL DOORS SHALL BE 32" (815MM) MINIMUM CLEAR OPENING WHEN OPENED TO 90 DEGREE POSITION UNLESS OTHERWISE NOTED.
- G. SEE SHEET A601 FOR EXTERIOR DOOR AND WINDOW SCHEDULES.
- H. STARBUCKS VENDOR TO PROVIDE DOOR HARDWARE COMPONENTS AND GC TO INSTALL.
- I. VERIFY ALL EXISTING DOORS, HARDWARE AND FRAMES MEET STARBUCKS AND/OR CODE REQUIREMENTS.
- J. PROVIDE FIRE EXTINGUISHERS AS NOTED ON THE APPROVED PLANS FROM THE CITY.
- K. REFER TO SHEET I104 FOR FLOOR FINISHES.

GENERAL LEGEND

NEW FULL HEIGHT WALL NEW PARTIAL HEIGHT WALL

EXISTING WALL WALL BLOCKING CALL OUT


STORE #: PROJECT #:

DESIGN MANAGER: PRODUCTION DESIGNER: GPD CHECKED BY:

Rev	Date	Ву	Description

BUILDING FLOOR PLAN

SHEET NUMBER:

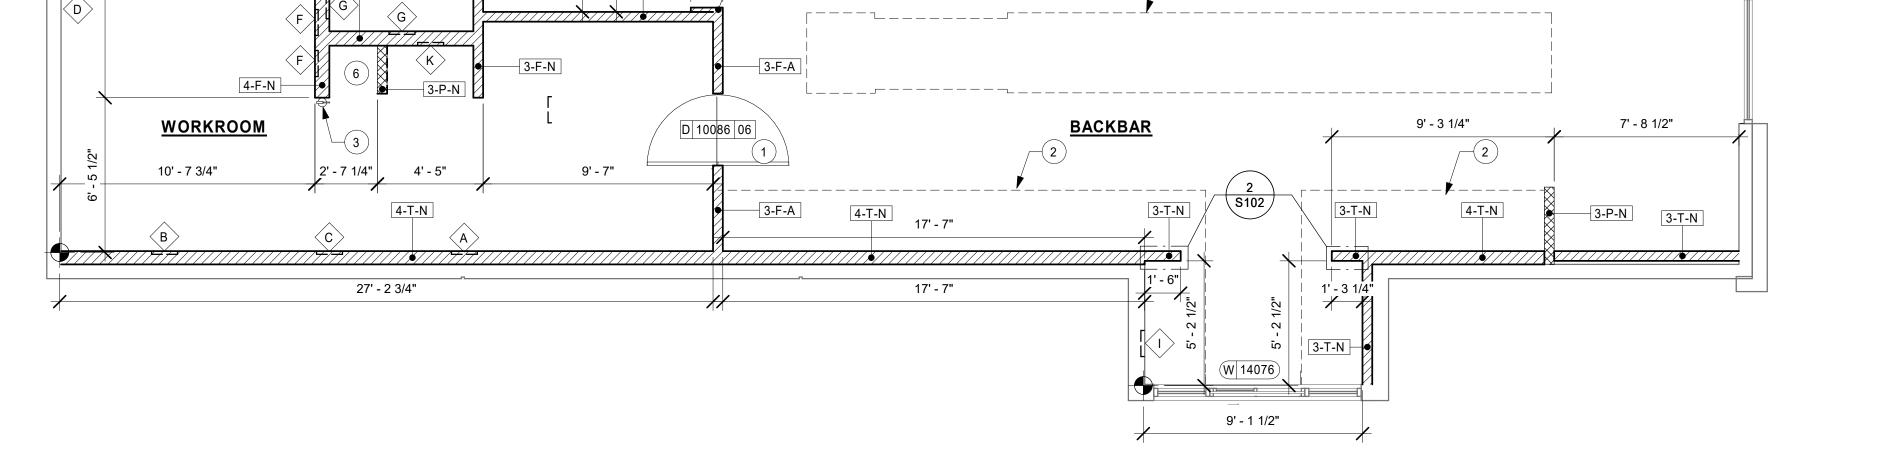

<u>CAFE</u>



1 1ST FLOOR - FLOOR PLAN

| Scale: 1/4" = 1'-0"



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STARBUCKS TEMPLATE VERSION: i2019-10-25



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GPD PROJECT NO: 2019355.20


MARK S. SALOPEK AKRON, OH NO. 6036

60983

84073-001


SCALE: AS SHOWN

A101

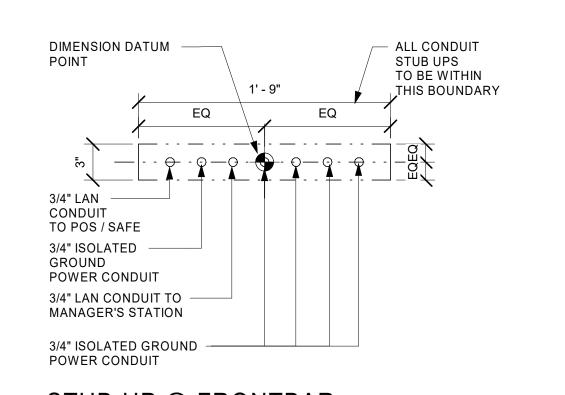

DIMENSION ALL CONDUIT DATUM STUB UPS POINT TO BE WITHIN THIS BOUNDARY CWF STUB UP HW STUB UP -CW STUB UP -

STUB-UP @ FRONTBAR

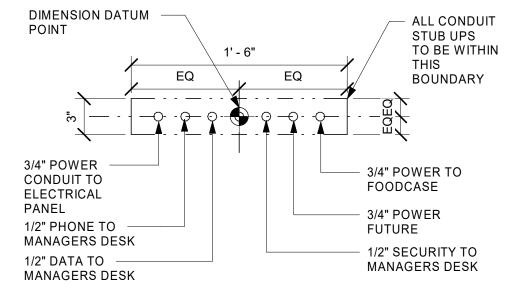

STUB-UP @ POS/SAFE

KEYED NOTES

- 1. FLOOR SINK LOCATION, TYP. SEE SHEET P101.
- 2. ELECTRICAL STUB-UP LOCATION. SEE SHEET E101.
- 3. PLUMBING STUB-UP LOCATION. SEE SHEET P101.
- 4. WASTE DRAIN FOR MOP SINK.
- 5. WASTE DRAIN FOR TOILET.
- 6. LOCATION OF ELECTRICAL PANELS, SEE ELECTRICAL FOR ADDITIONAL INFORMATION.
- 7. FLOOR ELECTRICAL OUTLET, SEE ELECTRICAL FOR ADDITIONAL INFORMATION.
- 8. FLOOR CLEANOUT, SEE PLUMBING FOR ADDITIONAL INFORMATION.
- 9. DATUM POINT FOR ENGINE LAYOUT.
- 10. DATUM POINT FOR BOH AND RESTROOMS LAYOUT.
- 11. FLOOR DRAIN, SEE PLUMBING FOR ADDITIONAL INFORMATION.
- 12. GREASE INTERCEPTOR, SEE PLUMBING FOR ADDITIONAL INFORMATION.
- 13. OUTLINE OF RECESSED WALK-OFF MAT.

GENERAL NOTES

- A. ALL STUB-UP DIMENSIONS ARE RELATIVE TO FINISHED WALL LOCATIONS (SHOWN AS OUTLINES ON THIS PLAN). REFER TO FLOOR PLAN FOR WALL PLACEMENT.
- B. FLOOR SINK: REFER TO CUT SHEETS FOR COMPONENT SPECIFICATIONS AND CUTOUT REQUIREMENTS.
- C. WASTE LINE PENETRATIONS: REFER TO PLUMBING PLANS FOR INDIVIDUAL LINE LOCATIONS.
- D. STUB-UP PENETRATIONS: REFER TO ELECTRICAL AND PLUMBING PLANS FOR INDIVIDUAL STUB-UP LOCATIONS.
- E. TOILET FLOOR PENETRATION: REFER TO CUT SHEETS FOR STUB-UP LOCATION RELATIVE TO FINISHED WALL.
- F. PENETRATION TO BE LOCATED ON CENTERLINE OF WALL OR AS REQUIRED PER CONDITIONS.
- G. TRENCHING OUTLINE FOR GUIDELINE USE ONLY. GENERAL CONTRACTOR TO COORDINATE WITH SPECIFIC TRADES AND SITE CONDITIONS TO DETERMINE ACTUAL LAYOUT.
- H. REFER TO SHEET I101 FOR FLOOR FINISHES.



EXISTING WALL

DATUM POINT



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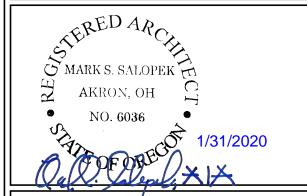
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GPD PROJECT NO: 2019355.20



PROJECT ADDRESS: 101, COOS BAY VILLAGE COOS BAY, OR 97420

STORE #: 60983 PROJECT #: 84073-001 ISSUE DATE: **DESIGN MANAGER:** RYAN WONG


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CHECKED BY:

BUILDING FLOOR PENETRATION PLAN

SCALE: AS SHOWN SHEET NUMBER:

A102



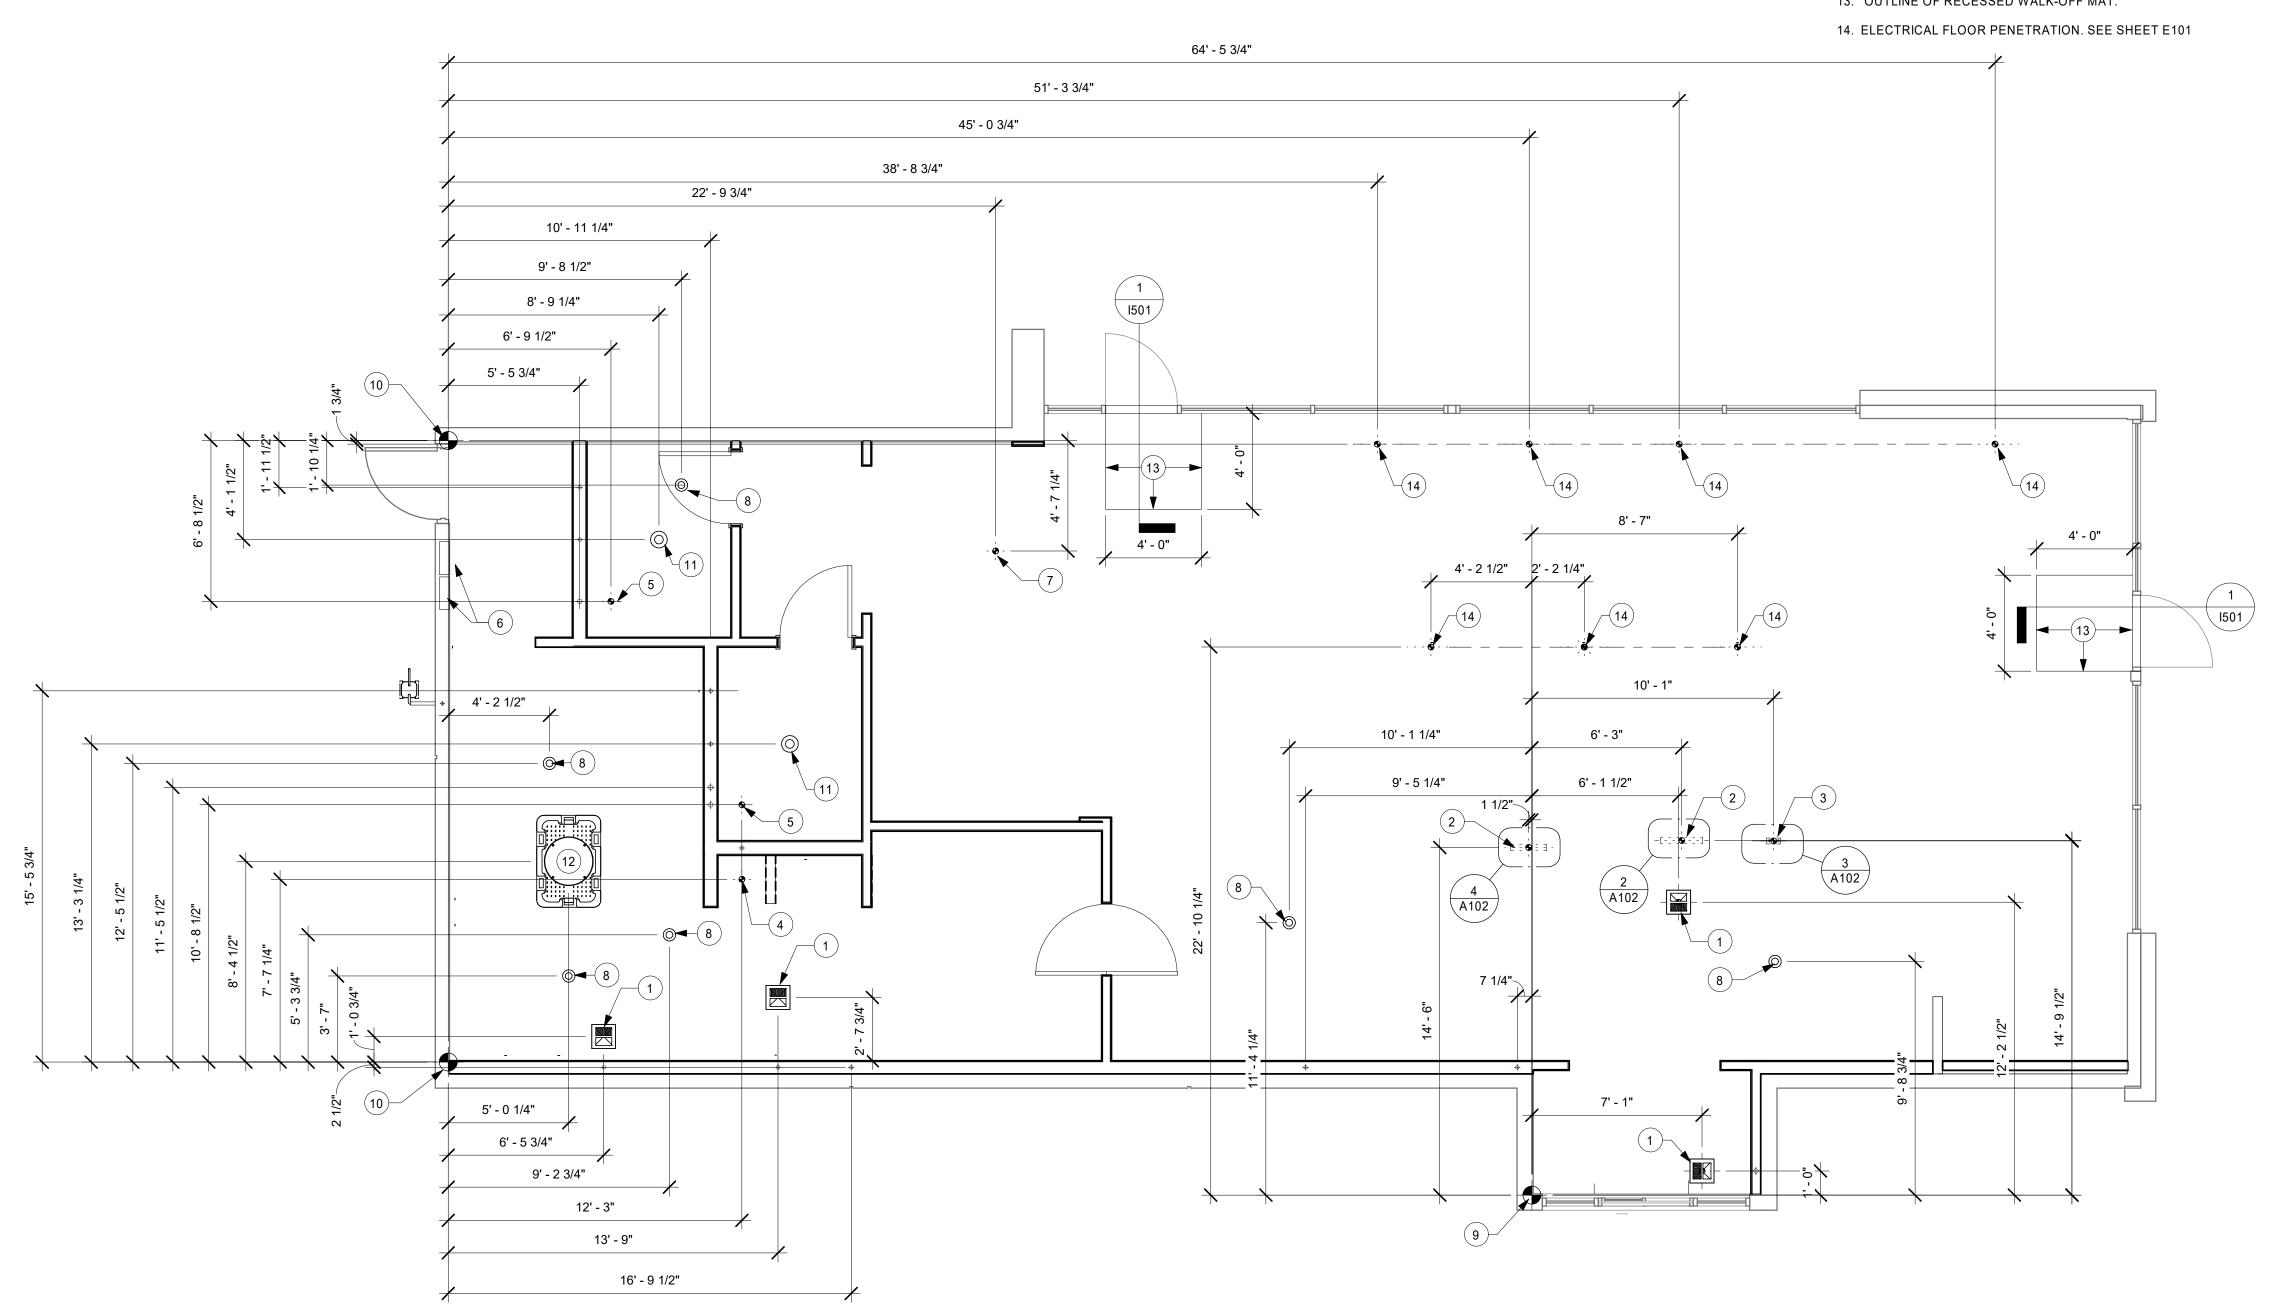

1ST FLOOR - FLOOR PENETRATION PLAN

Scale: 1/4" = 1'-0"

- NEW ROOF TOP UNIT BY LL. SEE MECHANICAL DRAWINGS. FIELD VERIFY LOCATION.
- RESTROOM EXHAUST FAN. SEE MECHANICAL DRAWINGS.
- 3. OUTLINE OF CANOPY BELOW.
- 4. ICE MACHINE CONDENSER, SEE MECHANICAL DRAWINGS.
- 5. SCUPPER AND DOWN SPOUT BY LL.
- 6. 3" VENT THROUGH ROOF, SEE MECHANICAL.
- 7. 4" FLUE FOR WATER HEATER, SEE MECHANICAL.
- 8. ROOF ACCESS HATCH BY LL.

GENERAL NOTES

- A. GENERAL CONTRACTOR TO VERIFY ALL DIMENSIONS AND NOTIFY STARBUCKS CONSTRUCTION MANAGER OF ANY DISCREPANCIES PRIOR TO CONSTRUCTION. ALL DIMENSIONS TO BE TAKEN FROM DESIGNATED DATUM POINT.
- B. IN FREEZE THAW CLIMATES ONLY: INSTALL SELF-REGULATING HEAT TAPE IN ALL DOWNSPOUTS. SEE ELECTRICAL FOR FURTHER INFORMATION.
- C. ROOF TOP PLUMBING VENTS ARE NOT SHOWN FOR CLARITY. REFER TO PLUMBING DRAWINGS FOR VTR LOCATIONS AND FURTHER INFORMATION.



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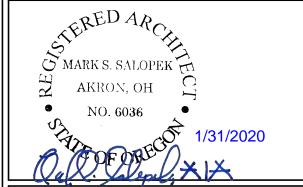
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520 SOUTH MAIN ST, SUITE 2531 AKRON, OH 44311 P: 330-572-2100 F: 330-572-2101

GPD PROJECT NO: 2019355.20



HWY 101 - COOS BAY
PROJECT ADDRESS:
101, COOS BAY VILLAGE
COOS BAY, OR 97420

STORE #: 60983
PROJECT #: 84073-001
ISSUE DATE: 01-29-20 - 100
DESIGN MANAGER: BYAN WONG

DESIGN MANAGER: RYAN WONG PRODUCTION DESIGNER: GPD CHECKED BY: TC

Revision Schedule

Rev	Date	Ву	Description	

ET TITLE:

BUILDING ROOF PLAN

SCALE: AS SHOWN

SHEET NUMBER: A103

0 2' 4' 8'
Scale: 1/4" = 1'-0"




22' - 3"

15' - 11 1/2"

10' - 9 3/4"

6' - 9 1/2"

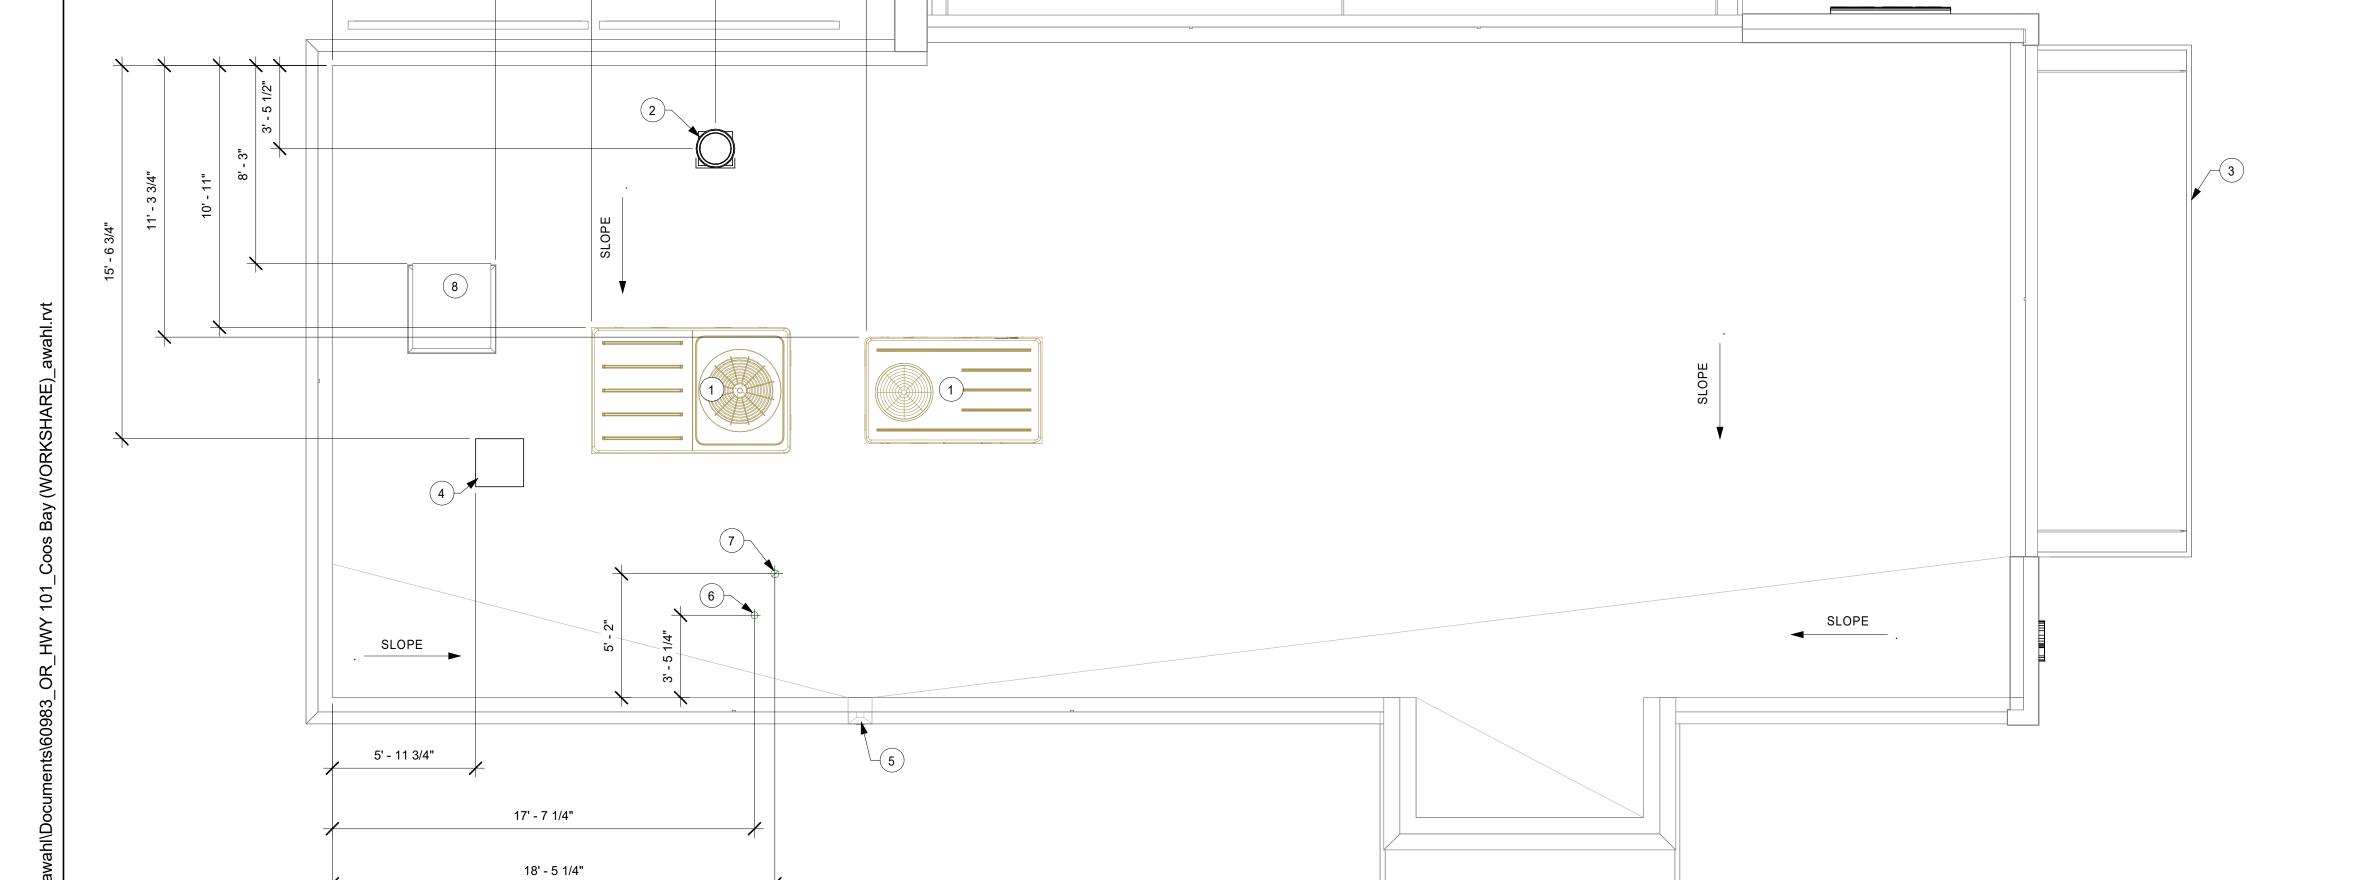

SIGNAGE TO BE SUBMITTED UNDER SEPARATE PERMIT BY OTHERS -SHOWN FOR REFERENCE ONLY.

> DIMENSIONS OF BUILDING SHELL FOR REFERENCE ONLY

1. GC TO PROVIDE J-BOX W/ PULL STRING FOR FUTURE BUILDING SIGNAGE. COORDINATE LOCATION OF J-BOX W/ SIGNAGE VENDOR PRIOR TO INSTALL.

2. PROVIDE 3/4" MARINE GRADE PLYWOOD BLOCKING FOR EXTERIOR SIGNAGE. EXTEND BLOCKING 8" (205MM) MIN. BEYOND EDGE OF SIGNAGE.

3. SIGNAGE BY STARBUCKS.

KEYED NOTES

- 4. SIGNAGE UNDER SEPARATE PERMIT. GC TO COORDINATE REQUIRED ATTACHMENT WITH GM AND SIGNAGE
- 5. LL TO FURNISH AND INSTALL SECURITY LIGHT ABOVE ENTRY DOOR.
- 6. EXTERIOR TRELLIS BY LL.
- 7. EXTERIOR FURNITURE, TYP.
- 8. HOSE BIBB LOCATION.
- 9. BIKE RACK BY LL.
- 10. DRIVE-THRU CANOPY BY LL
- 11. EXTERIOR SCONCE LIGHT BY LL, TYP.

GENERAL NOTES

- A. GENERAL CONTRACTOR TO COORDINATE AND SCHEDULE SIGNAGE INSTALLATION WITH THE SIGNAGE CONTRACTOR PROVIDING A MINIMUM SCHEDULING NOTICE OF 4 WEEKS AND 1 WEEK PRIOR TO SCHEDULED DATE OF INSTALLATION. CONSTRUCTION MANAGER TO PROVIDE GENERAL CONTRACTOR WITH SIGNAGE CONTRACTOR CONTACT INFORMATION.
- B. GENERAL CONTRACTOR SHALL COORDINATE WITH ELECTRICAL CONTRACTOR TO FURNISH AND INSTALL ELECTRICAL CIRCUITS INCLUDING ALL CONDUIT, WIRE, CONNECTIONS AND BREAKER AT PANEL BOARD NECESSARY TO SERVE SIGNAGE.
- C. GENERAL CONTRACTOR TO PROVIDE FIRE TREATED WOOD STUD BLOCKING OR EQUIVALENT TO SUPPORT
- D. SIGNAGE CONTRACTOR SHALL VERIFY SIZE AND LOCATION OF ANY AND ALL ALLOWABLE MONUMENT OR POLE SIGNAGE AND PROVIDE SHOP DRAWING(S) PRIOR TO FABRICATION TO THE STARBUCKS DESIGNER FOR APPROVAL.
- E. SIGNAGE CONTRACTOR TO INSTALL SIGNAGE IN COMPLIANCE WITH LOCAL CODES AND OBTAIN PERMIT.
- F. SIGNAGE CONTRACTOR TO SUPPLY SHOP DRAWINGS TO CONSTRUCTION MANAGER AND TO THE GENERAL CONTRACTOR AS NEEDED. GENERAL CONTRACTOR TO NOTIFY CONSTRUCTION MANAGER IMMEDIATELY IF SHOP DRAWINGS OR INSTALLATION IS IN DISCREPANCY WITH ARCHITECTURAL DRAWINGS.
- G. GENERAL CONTRACTOR TO CLEAN, PATCH AND REPAIR EXISTING EXTERIOR AS REQUIRED.



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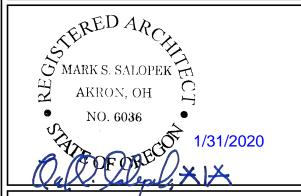
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STARBUCKS TEMPLATE VERSION: i2019-10-25



520 SOUTH MAIN ST, SUITE 2531 AKRON, OH 44311 P: 330-572-2100 F: 330-572-2101

GPD PROJECT NO: 2019355.20



PROJECT ADDRESS: 101, COOS BAY VILLAGI COOS BAY, OR 97420

60983 STORE #: 84073-001 PROJECT #: **DESIGN MANAGER:** RYAN WONG PRODUCTION DESIGNER: GPD

Revision Schedule

Rev	Date	Ву	Description	

CHECKED BY:

BUILDING EXTERIOR ELEVATIONS SCALE: AS SHOWN

SHEET NUMBER:

A201



5


Exterior A

| Scale: 1/4" = 1'-0"

4 3 2 1 S 18498

10—

DIMENSIONS OF BUILDING SHELL FOR REFERENCE ONLY

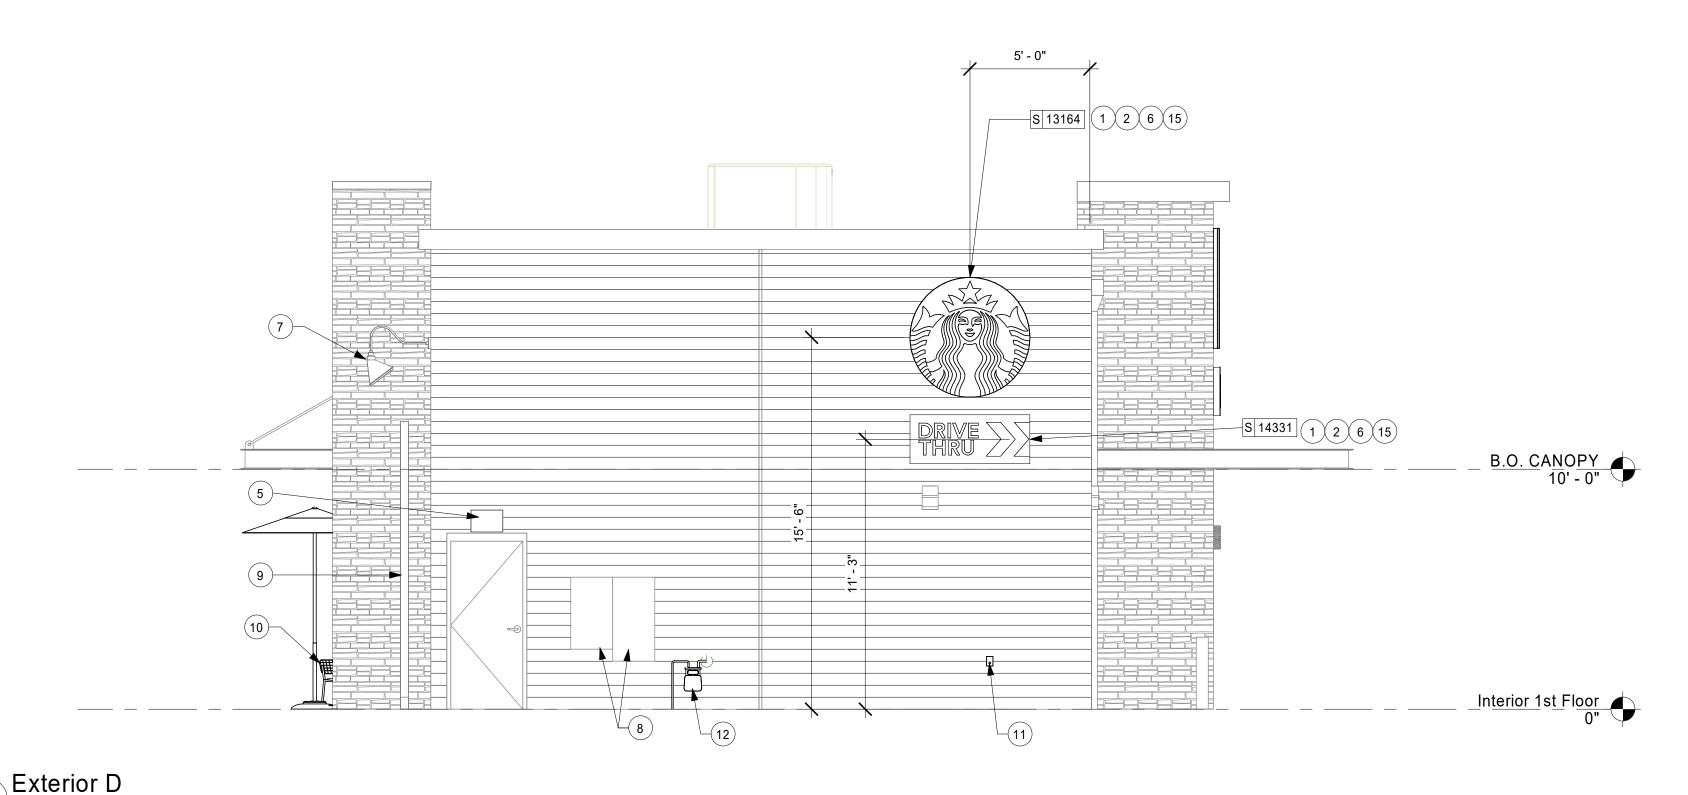

KEYED NOTES

- 1. GC TO PROVIDE J-BOX W/ PULL STRING FOR FUTURE BUILDING SIGNAGE. COORDINATE LOCATION OF J-BOX W/ SIGNAGE VENDOR PRIOR TO INSTALL.
- 2. PROVIDE 3/4" MARINE GRADE PLYWOOD BLOCKING FOR EXTERIOR SIGNAGE. EXTEND BLOCKING 8" (205MM) MIN. BEYOND EDGE OF SIGNAGE.
- 3. LL TO FURNISH AND INSTALL TENANT SPECIFIED DRIVE THRU SERVICE WINDOW WITH ALL CONNECTIONS.
- 4. LL TO FURNISH AND INSTALL AIR CURTAIN AND FLY FAN AT DRIVE THRU WINDOW.
- 5. LL TO FURNISH AND INSTALL SECURITY LIGHT ABOVE SERVICE DOOR.
- 6. SIGNAGE BY STARBUCKS.
- 7. EXTERIOR LIGHT BY LL.
- 8. ELECTRIC METER AND CT CABINET LOCATION.
- 9. EXTERIOR TRELLIS BY LL.
- 10. EXTERIOR FURNITURE, TYP.
- 11. HOSE BIBB LOCATION.
- 12. GAS METER. LOCATION.
- 13. BIKE RACK BY LL.14. DRIVE-THRU CANOPY BY LL.
- 15. SIGNAGE UNDER SEPARATE PERMIT. GC TO COORDINATE REQUIRED ATTACHMENT WITH GM AND SIGNAGE VENDOR.

GENERAL NOTES

- A. GENERAL CONTRACTOR TO COORDINATE AND SCHEDULE SIGNAGE INSTALLATION WITH THE SIGNAGE CONTRACTOR PROVIDING A MINIMUM SCHEDULING NOTICE OF 4 WEEKS AND 1 WEEK PRIOR TO SCHEDULED DATE OF INSTALLATION. CONSTRUCTION MANAGER TO PROVIDE GENERAL CONTRACTOR WITH SIGNAGE CONTRACTOR CONTACT INFORMATION.
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520 SOUTH MAIN ST, SUITE 2531 AKRON, OH 44311 P: 330-572-2100 F: 330-572-2101

GPD PROJECT NO: 2019355.20



PROJECT NAME:

HWY 101 - COOS BAY

101, COOS BAY VILLAGE
COOS BAY, OR 97420

STORE #: 60983
PROJECT #: 84073-001
ISSUE DATE: 01-29-20 - 100
DESIGN MANAGER: RYAN WONG

PRODUCTION DESIGNER: GPD CHECKED BY: TC


Revision Schedule

Rev	Date	Ву	Description

SHEET TITLE:
BUILDING EXTERIOR
ELEVATIONS

SCALE: AS SHOWN
SHEET NUMBER:

A202

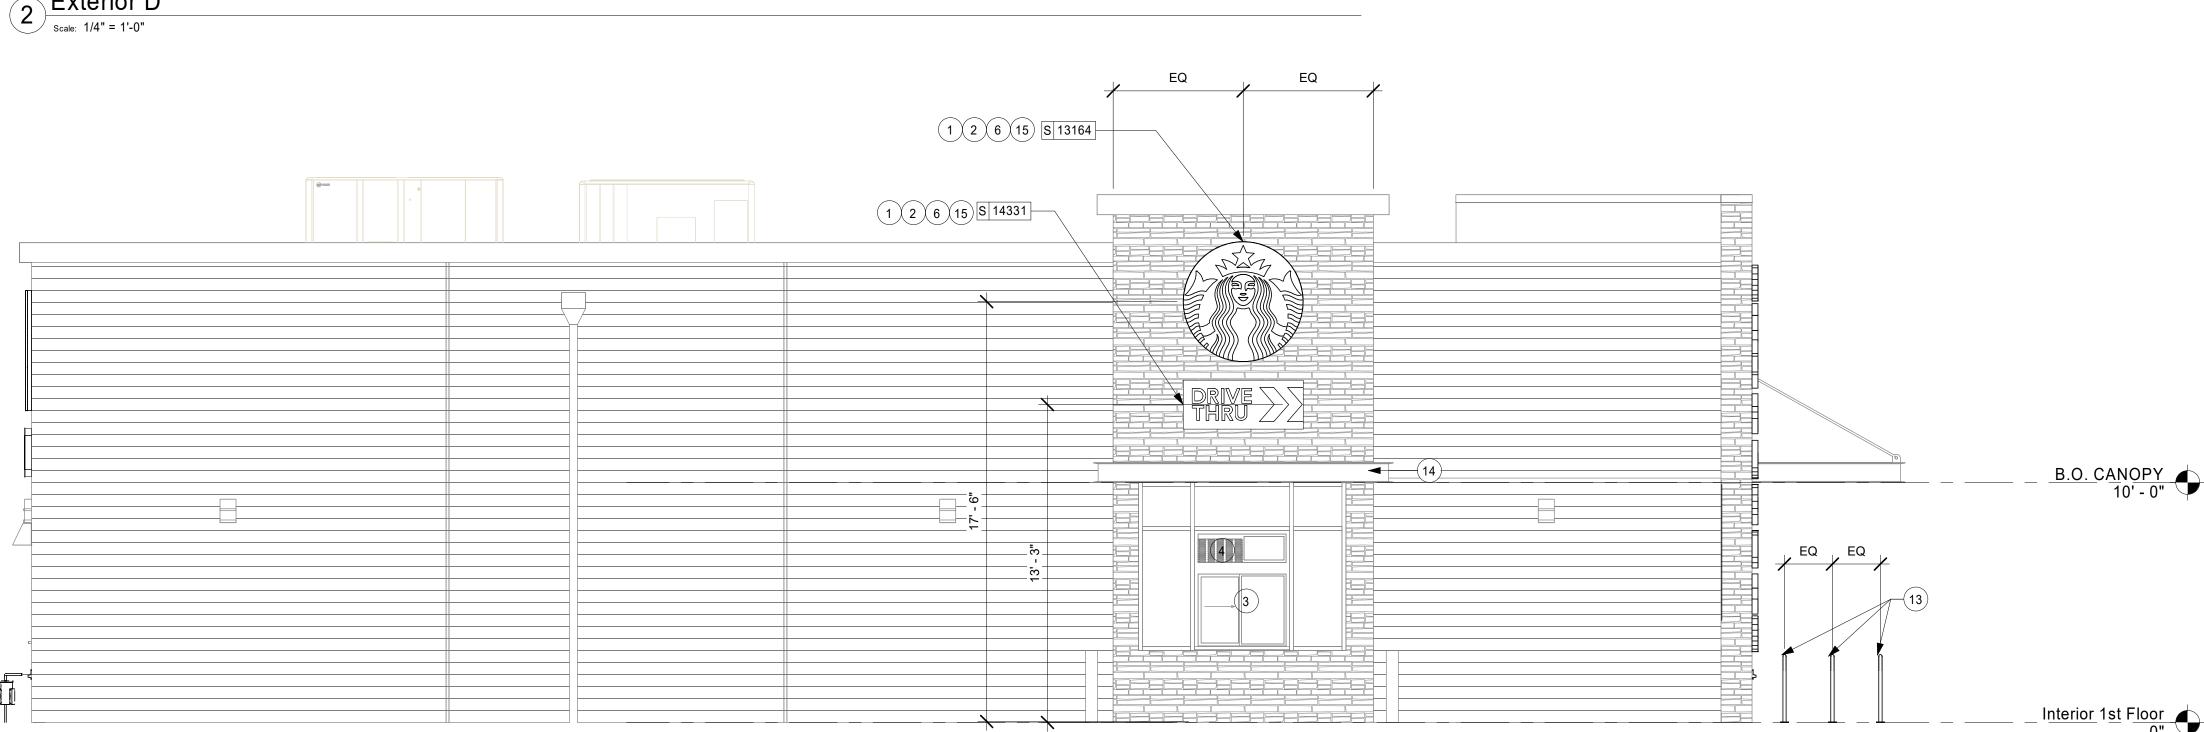

1 Exterior C


| Scale: 1/4" = 1'-0"

0 2' 4' 8'


WINDOW SCHEDULE - "W"							
DESIGN ID	COUNT	DESCRIPTION	FURN. BY	INST. BY	COMMENTS		
WINDOW							
14076 1 WINDOW - DT WITH SPLIT TRANSOM - 48X60IN LL LL USE IN CONJUNCTION WITH AA100 FLYFAN							

WINDOW LEGEND

DOOR LEGEND

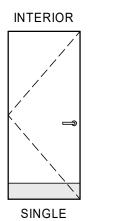



FLUSH

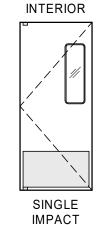


DOUBLE

ACTING

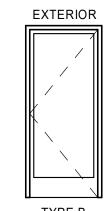

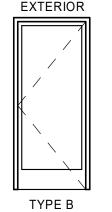

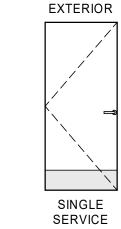

	DOOR HARDWARE SET NO. 6 - For restroom door with lever and privacy lock						
No.	ltem	Description	Manufacturer	Finish			
3	Hanging Items	TA2714/MPB79 Hinge MacPro Bearing 4.5 x 4.5	McKinney	626			
1	Securing Devices	PB5425LN Lock, Shallow Coin Turn, Privacy PB5425LN-693-497 1-3/4	Yale Lock	626			
1	Closing Devices	8916 Door Closer 8916 AF89P	Dorma	689			
2	Protective Trim Units	K1050 B4E Kickplate 8" x 34" Each Side 32D	Rockwood	630			
3	Accessories	GJ64 Rubber Silencer	Glynn Johnson	Gray			
1	Stops and Holders	473 Door Stop w/ Hook	Rockwood	626			

	DOOR HARDWARE SET NO. 11 - For workroom door at backbar						
No.	Item	Description	Manufacturer	Finish			
1	Traffic Door Package	SCP8 36" x 84"	Eliason	As Selected			

	DOO	PR HARDWARE SET NO. 2 - For new single aluminum m	ain entry/exit do	or
No.	Item	Description	Manufacturer	Finish
3	Hanging Devices	TH2314/MPB91	McKinney	630
1	Securing Devices	MS1851S Deadbolt	Adams Rite	628
1	Sign	Vinyl Sign: "THIS DOOR MUST REMAIN UNLOCKED WHEN BUILDING IS OCCUPIED"	Seton	
2	Securing Devices	C607 7-Pin Core Combinated "A" Keyway	Falcon Lock	626
1	Securing Devices	KB609-2 Cut Control Key "A" Keyway	Falcon Lock	
9	Securing Devices	KB632-2 Cut User Key "A" Keyway	Falcon Lock	
2	Securing Devices	C987 7-Pin Mortise Cylinder Housing w/AR Cam 26D	Falcon Lock	626
2	Securing Devices	AO8794-003 Adjustable Ring, Mortise Cyl. 5/16-13/32	Falcon Lock	626
1	Operating Trim	108 Door Pull Handle 32D	Rockwood	630
1	Operating Trim	48 Push Bar x 31	Rockwood	630
1	Closing Devices	8916 Door Closer 8916 AF89P	Dorma	689
1	Stops and Holders	473 Door Stop w/Hook	Rockwood	626
1	Threshold	325 Half Saddle Threshold	National Guard	

No.	Item	Description	Manufacturer	Finish
3	Hanging Devices	TH2314/MPB91	McKinney	630
1	Securing Devices	CD35A-NL-OP Panic Device	Von Duprin	628/630
2	Securing Devices	C607 7-Pin Core Combinated "A" Keyway	Falcon Lock	626
1	Securing Devices	KB609-2 Cut Control Key "A" Keyway	Falcon Lock	
9	Securing Devices	KB632-2 Cut User Key "A" Keyway	Falcon Lock	
1	Securing Devices	C953 7-Pin Rim Cylinder Housing	Falcon Lock	626
1	Securing Devices	C987 7-Pin Mortise Cylinder Housing w/AR Cam	Falcon Lock	626
1	Securing Devices	A08794-003 Adjustable Ring, Mortise Cyl. 516-13/32	Falcon Lock	626
1	Operating Trim	108 Door Pull Handle	Rockwood	630
1	Closing Devices	8916 Door Closer 8916 AF89P	Dorma	689
1	Stops and Holders	473 Door Stop w/ Hook	Rockwood	626
1	Threshold	325 Half Saddle Threshold	National Guard	
1	Sign	Vinyl Sign: "THIS DOOR MUST REMAIN UNLOCKED WHEN BUILDING IS OCCUPIED"	Seton	

No.	ltem	Description	Manufacturer	Finish
3	Hanging Devices	TH2314/MPB91 Hinge MacPro Bearing 4.5 x 4.5	McKinney	630
1	Securing Devices	C607 7-Pin Core Combinated "A" Keyway	Falcon Lock	626
1	Securing Devices	I/O 2000L-03IC Auto Locking Door Alarm, IC; No CTR Includes Mortise Cylinder	Sur-Lock	
1	Closing Devices	8916 Door Closer 8916 AF89P	Dorma	689
1	Protective Trim Units	K1050 B4E Kickplate 10" x 40"	Rockwood	630
1	Accessories	137NA Weather Strip 20' 42" x 84"	National Guard	А
1	Accessories	Door Sweep 18062CNB36	Pemko	Α
1	Miscellaneous Items	DS / 1000 Door Scope	Security Products	Silver
1	Miscellaneous Items	MCV309NWHGL Door Bell	Nutone	As Selected

GENERAL NOTES

- A. STARBUCKS VENDOR TO PROVIDE DOOR HARDWARE COMPONENTS. GC TO INSTALL.
- B. SEE SHEET A101 FOR TAGGED LOCATION OF EXTERIOR DOORS AND WINDOWS.
- C. EGRESS SHALL NOT PASS THROUGH KITCHENS, STORAGE ROOMS, CLOSETS OR SIMILAR SPACES. (1014.2)
- D. PANIC AND FIRE EXIT HARDWARE, WHERE INSTALLED ON DOORS IN THIS BUILDING SHALL SATISFY THE FOLLOWING (1008.1.10):
- a) THE ACTUATION PORTION OF THE RELEASING DEVICE SHALL EXTEND AT LEAST ONE-HALF OF THE DOOR LEAF WIDTH.
- b) THE MAXIMUM UNLATCHING FORCE DOES NOT EXCEED 15 POUNDS (6.8 KG).
- c) PIVOTED OR BALANCED DOORS SHALL BE OF THE PUSH-PAD TYPE WHERE PANIC HARDWARE IS REQUIRED AND THE PAD SHALL NOT EXTEND ACROSS MORE THAN ONE-HALF OF THE DOOR WIDTH, MEASURED FROM THE LATCH SIDE.
- d) PANIC HARDWARE LISTED IN ACCORDANCE WITH UL 305.
- e) FIRE EXIT HARDWARE LISTED IN ACCORDANCE WITH UL 10C AND UL 305.



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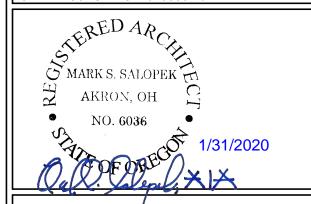
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520 SOUTH MAIN ST, SUITE 2531 AKRON, OH 44311 P: 330-572-2100 F: 330-572-2101

GPD PROJECT NO: 2019355.20



PROJE HW

STORE #: 60983 PROJECT #: 84073-001 ISSUE DATE:

DESIGN MANAGER: RYAN WONG PRODUCTION DESIGNER: GPD CHECKED BY: TC

Revision Schedule

Rev	Date	Ву	Description

WINDOW AND DOOR SCHEDULES & DETAILS

SCALE: AS SHOWN SHEET NUMBER:

A602

- 1. INSTALL EXTERIOR FURNITURE THROUGHOUT AS
- 2. INSTALL CAFE FURNITURE THROUGHOUT AS SHOWN.
- 3. COMMUNITY TABLE. SEE FURNITURE SCHEDULE.
- 4. REFER TO ENLARGED RESTROOM PLANS AND ELEVATIONS (SHEET I401) FOR FIXTURE LOCATION AND MOUNTING HEIGHTS
- 5. CONDIMENT CART. SEE INTERIOR FINISH ELEVATIONS.
- 6. PLACE MERCHANDISE FIXTURES AND RETAIL FLOOR BASKETS PER PLAN. STORE OPERATORS TO ORDER RETAIL FLOOR BASKETS.
- 7. MERCHANDISE DISPLAY. SEE DETAILS X/I50X FOR MORE INFORMATION. ALIGN FRONT OF MERCH. BAYS WITH STOREFRONT DOOR FRAME. CENTER MERCH. BAYS WITH CENTERLINE OF WALL BEHIND.
- 8. DO NOT BLOCK FOOD CASE INTAKE/EXHAUST.
- 9. SAFE LOCATED AT POS CABINET. SEE ELECTRICAL FOR ADDITIONAL INFORMATION.
- 10. HAND SINK W/INTEGRAL SPLASH GUARD.
- 11. INSTALL CORNER GUARD AS INDICATED. SEE INTERIOR FINISH ELEVATIONS.
- 12. LOCATION OF SWITCHES AND THERMOSTAT CONTROLS.
- 13. LOCATION OF FIRE EXTINGUISHER.
- 14. SECURE LOCKERS TO WALL.
- 15. VENDOR TO INSTALL WATER FILTRATION SYSTEM PER MANUFACTURER'S REQUIREMENTS. G.C. TO PROVIDE PLUMBING AND ELECTRICAL REQUIREMENTS.
- 16. WATER HEATER LOCATED ABOVE. SEE PLUMBING
- 17. G.C. TO REVERSE HINGE ON U.C. REFRIGERATOR TO LEFT HAND SWING AS SHOWN.
- 18. MANAGERS DESK. SEE MANAGER'S DESK/EQUIPMENT RACK ELECTRICAL DETAIL FOR ADDITIONAL INFORMATION.

GENERAL NOTES

- A. GENERAL CONTRACTOR TO SCHEDULE WITH LOCAL REFRIGERATION CONTRACTOR TO CONDUCT INITIAL FOOD CASE START-UP AND TESTING. FOR LIST OF APPROVED START UP CONTRACTORS, CONTACT PROJECT CONSTRUCTION REPRESENTATIVE.
- B. THE SITE IS SERVED BY THE MUNICIPAL WATER AND SEWER SYSTEM UNLESS OTHERWISE NOTED.
- C. ALL FOOD STORAGE SHALL BE 6" (150mm) A.F.F.
- D. ALL WOOD SURFACES (DOORS, TRIM, SHELVES, CABINETS) SHALL BE SEALED.
- E. ALL EQUIPMENT AND INSTALLATION WILL MEET NATIONAL SANITATION FOUNDATION STANDARDS OR EQUIVALENT.
- F. ALL EQUIPMENT AND CABINETRY WILL BE FLUSH MOUNTED TO COUNTERS, WALLS OR FLOORS, OR BE RAISED TO ALLOW FOR CLEANING.
- G. CONFIRM ALL NECESSARY EQUIPMENT CLEARANCES PER PRODUCT CUT SHEET (E.G. ICE MACHINE).
- H. FOR LOCATION OF COUNTERTOP EQUIPMENT, REFER TO CASEWORK ELECTRICAL DETAILS.
- I. EQUIPMENT UNITS SHALL CONTAIN NO EXPOSED THREADS, EMBELLISHMENTS OR OVERHANGING EDGES THAT SERVE AS PLACES FOR ACCUMULATION OF DUST, DIRT AND DEBRIS.
- J. WARMING OVEN(S) SHOWN FOR PERMITTING PURPOSES. INSTALLATION AT STORE OPENING TO BE VERIFIED BY STARBUCKS CONSTRUCTION REPRESENTATIVE.
- K. EACH HAND WASHING SINK WILL HAVE A SINGLE SERVICE TOWEL AND SOAP DISPENSER, AND ALL HAND SINKS TO HAVE A COMBINATION FAUCET OR PREMIXING FAUCET.
- L. FOR PLUMBING FIXTURES, REFER TO THE PLUMBING DESIGN PLAN. FOR DATA DEVICE SCHEDULE, REFER TO THE ELECTRICAL DESIGN PLAN.
- M. SEE ELEVATIONS FOR DISTRIBUTION OF CUP DISPENSERS.
- N. PROVIDE FIRE EXTINGUISHERS AS NOTED ON THE APPROVED PLANS FROM THE LOCAL JURISDICTION.



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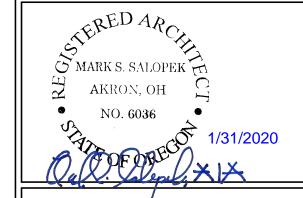
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STARBUCKS TEMPLATE VERSION: i2019-10-25



AKRON, OH 44311 P: 330-572-2100 F: 330-572-2101

GPD PROJECT NO: 2019355.20



COOS BAY
S BAY, OR 101, (COO)

STORE #: 60983 PROJECT #: 84073-001 ISSUE DATE: 01-29-20 - 100 percent DESIGN MANAGER: RYAN WONG PRODUCTION DESIGNER: GPD CHECKED BY:


Revision Schedule

FF & E PLAN

SCALE: AS SHOWN

SHEET NUMBER:

1101

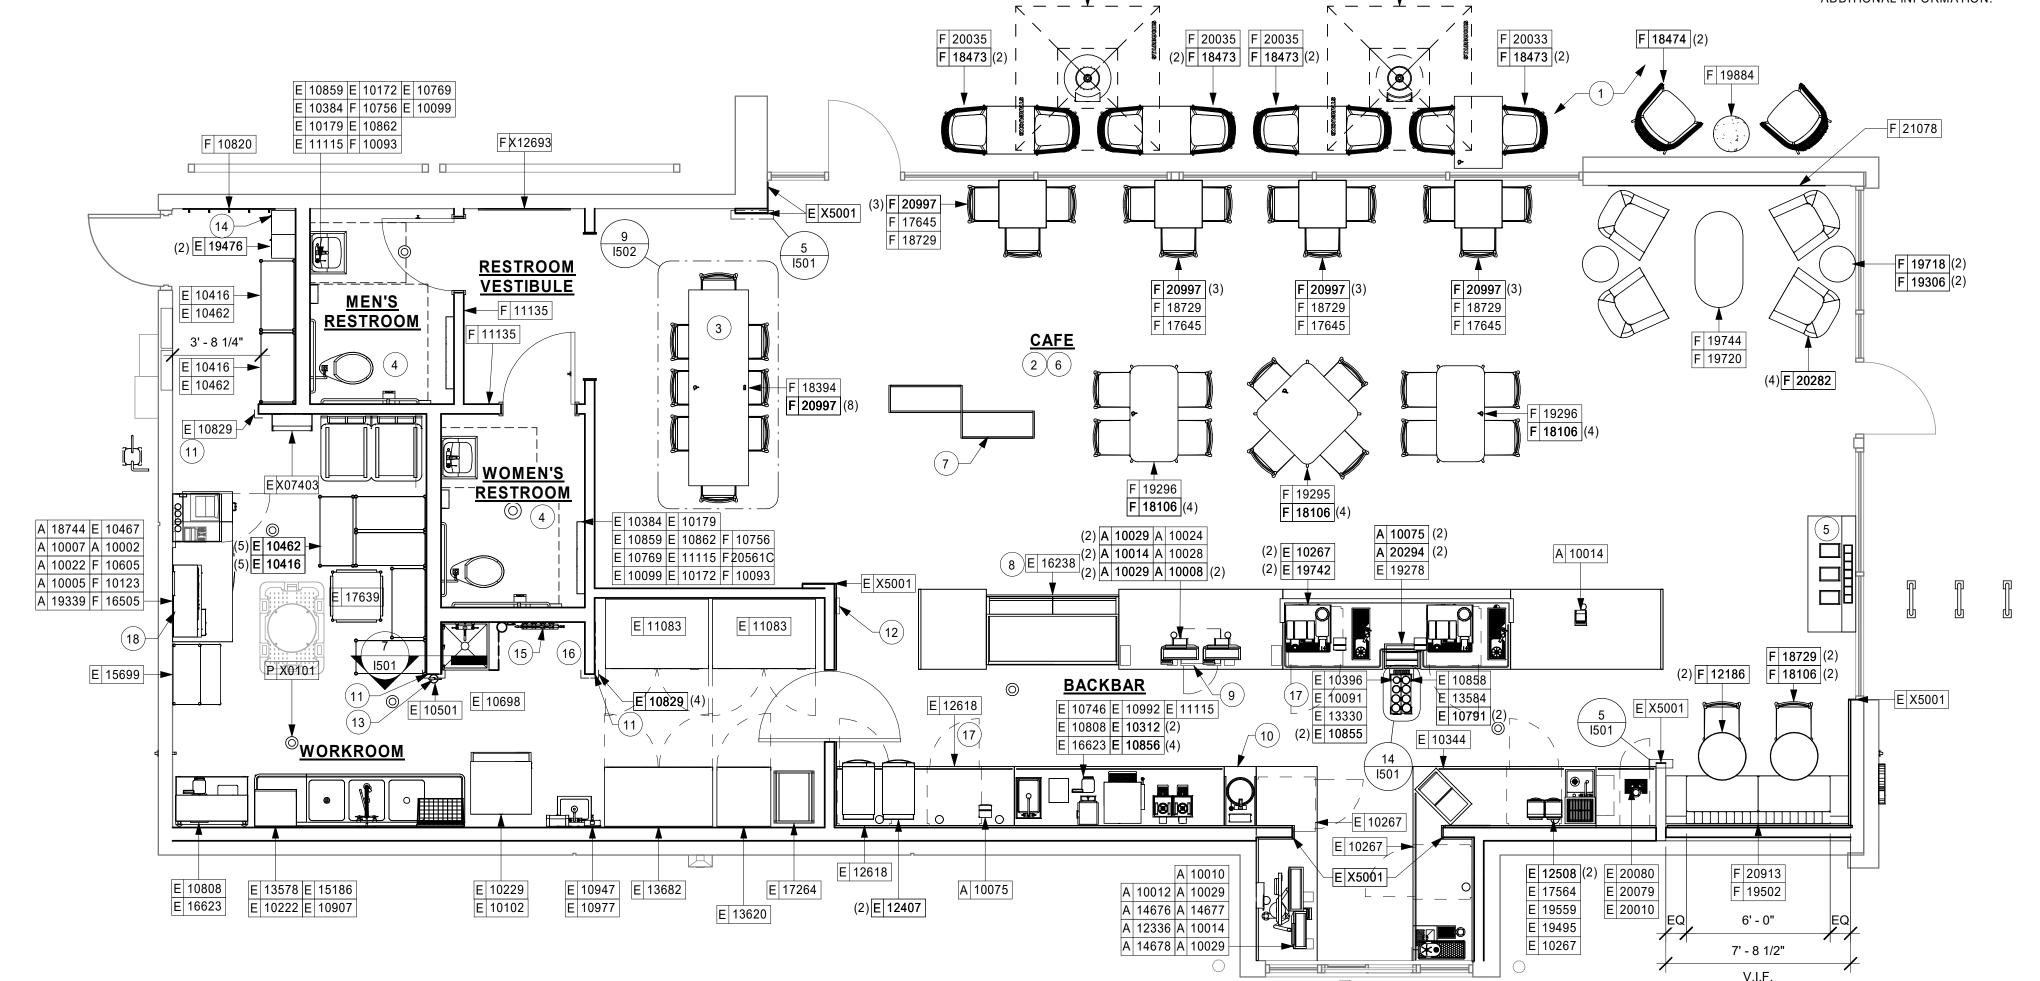

Y 12147

Y 20073

- 1. DO NOT CAULK TRASH RINGS TO COUNTERTOPS.
- 2. INSTALL CASEWORK, COUNTERTOPS, SHELVES, CUBBIES, FINISHES, TRIM AND TABLE TOPS THROUGHOUT. REFERENCE FINISH SCHEDULE AND MANUFACTURER'S SPECIFICATIONS FOR ADDITIONAL INFORMATION.
- 3. ALL COUNTERTOPS UTILIZED FOR CUSTOMER TRANSACTIONS, INCLUDING BAR, CONDIMENT AND SALES COUNTERTOPS SHALL BE INSTALLED AT 2'-10" (860 MM) MAXIMUM A.F.F.
- 4. PROVIDE COUNTERTOP TASK LIGHTING. MOUNT TO UNDERSIDE OF SHELVES. SEE INTERIOR ELEVATIONS AND ELECTRICAL FOR ADDITIONAL INFORMATION.
- 5. VARIABLE WIDTH FILLER CABINET / COUNTERTOP REQUIRED TO FILL GAP (FIELD VERIFY DIMENSION). VENDOR TO COORDINATE EXACT DIMENSION WITH GC PRIOR TO INSTALLATION.
- 6. FLOOR SINK BELOW. CASEWORK MANUFACTURER TO COORDINATE DESIGN TO INSURE THIS AREA IS READILY ACCESSIBLE FOR CLEANING AND FREE OF COUNTERTOP SUPPORT.
- 7. CEILING CASEWORK ABOVE

FOR REFERENCE ONLY - REFER TO CASEWORK SHOP DRAWINGS FOR FURTHER INFORMATION

GENERAL NOTES

- A. GENERAL CONTRACTOR TO NOTIFY CONSTRUCTION MANAGER IMMEDIATELY IF A DISCREPANCY EXISTS BETWEEN CASEWORK SHOP DRAWINGS, EXITING SITE CONDITIONS, ARCHITECTURAL DRAWINGS OR BUILT FIXTURES. ALL DIMENSIONS SHALL BE FIELD VERIFIED BY GC PRIOR TO SHOP DRAWINGS PRODUCTION.
- B. STARBUCKS CONSTRUCTION MANAGER TO COORDINATE AND SCHEDULE CASEWORK DELIVERY DATE. GENERAL CONTRACTOR TO CONFIRM CASEWORK DELIVERY DATE WITH CASEWORK MANUFACTURER AT FOUR (4) WEEKS PRIOR AND THEN ONE (1) WEEK PRIOR TO SCHEDULED DATE OF DELIVERY.
- C. STARBUCKS CONTRACTS DIRECTLY WITH CASEWORK VENDOR TO SUPPLY CASEWORK LISTED IN THE CASEWORK SCHEDULE, UNLESS OTHERWISE NOTED.
- D. CASEWORK VENDOR TO PROVIDE COMPLETE SHOP DRAWINGS AND INSTALLATION PACKAGE TO GENERAL CONTRACTOR TO FACILITATE PROPER INSTALLATION.
- E. ALL CASEWORK BOX BASE / TOE KICKS SHALL BE SET AND LEVELED USING 1/4" (6 MM) NON-ABSORBENT PLASTIC SHIMS PROVIDED BY CASEWORK VENDOR.
- F. SEE INTERIOR FINISH ELEVATIONS AND SCHEDULES FOR LOCATION AND TAGGING OF WALL TREATMENTS BY CV AND OTHERS.
- G. SEE REFLECTED CEILING PLAN FOR CASEWORK SOFFIT LOCATIONS.
- H. REFERENCE PLUMBING AND ELECTRICAL PLANS FOR PLACEMENT OF ELECTRICAL, DATA AND PLUMBING ON FRONT AND BACKLINE OF BAR.
- I. PROVIDE ACCENT LIGHTING AT FRONT EDGE OF BAR. SEE INTERIOR ELEVATIONS AND ELECTRICAL FOR ADDITIONAL INFORMATION.
- J. CASEWORK VENDOR TO ENGINEER PROPER COUNTERTOP SUPPORT AT ESPRESSO BAR AND OTHER WORKSTATIONS PER STARBUCKS MINIMUM PERFORMANCE REQUIREMENTS.

LEGEND

INDICATES SOLID SURFACE (SS) COUNTERTOP

C 12345 CASEWORK TAG

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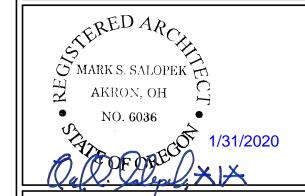
STARBUCKS TEMPLATE VERSION: i2019-10-25

BOTH PARTIES.



520 SOUTH MAIN ST, SUITE 2531 AKRON, OH 44311 P: 330-572-2100 F: 330-572-2101

GPD PROJECT NO: 2019355.20



COOS S BAY, 101, (COO)

60983 STORE #: PROJECT #: 84073-001 ISSUE DATE: 01-29-20 - 100 percent DESIGN MANAGER: RYAN WONG

CHECKED BY: **Revision Schedule**


PRODUCTION DESIGNER: GPD

Rev	Date	Ву	Description

CASEWORK PLAN


SCALE: AS SHOWN SHEET NUMBER:

1102

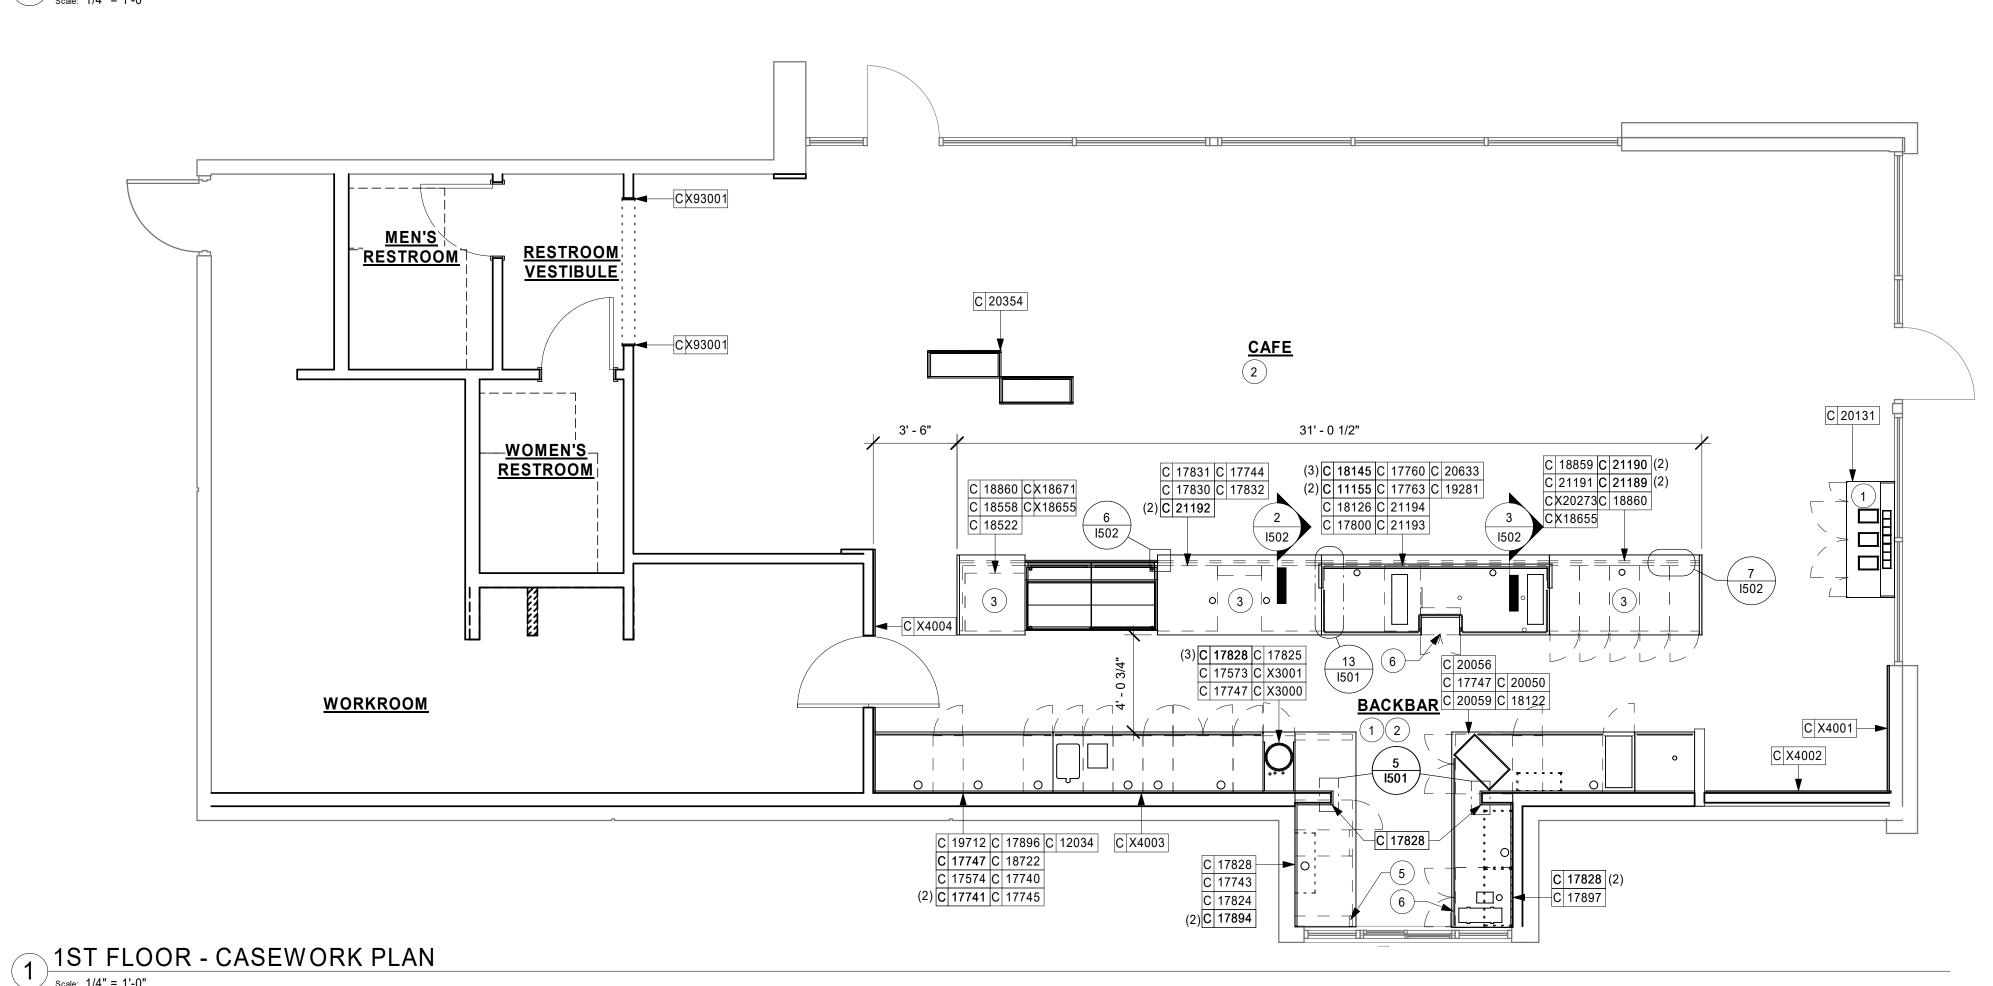



Scale: 1/4" = 1'-0"

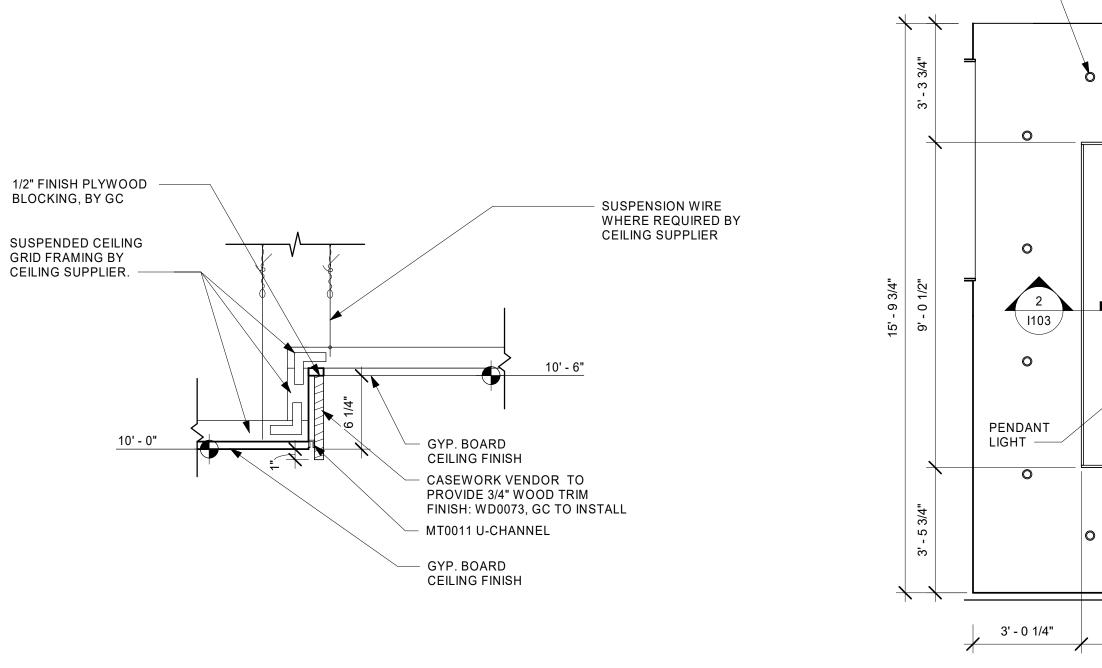

COMMUNITY TABLE CEILING CASEWORK

COMMUNITY TABLE SOFFIT DIMENSIONS Scale: 3/8" = 1'-0"

4' - 6"

0

0

SUSPENDED GYP

CEILING SEE DETAILS


CASEWORK, SEE

I/102 FOR DETAILS

─ AV SPEAKER

5' - 5 3/4"

CAN FIXTURE

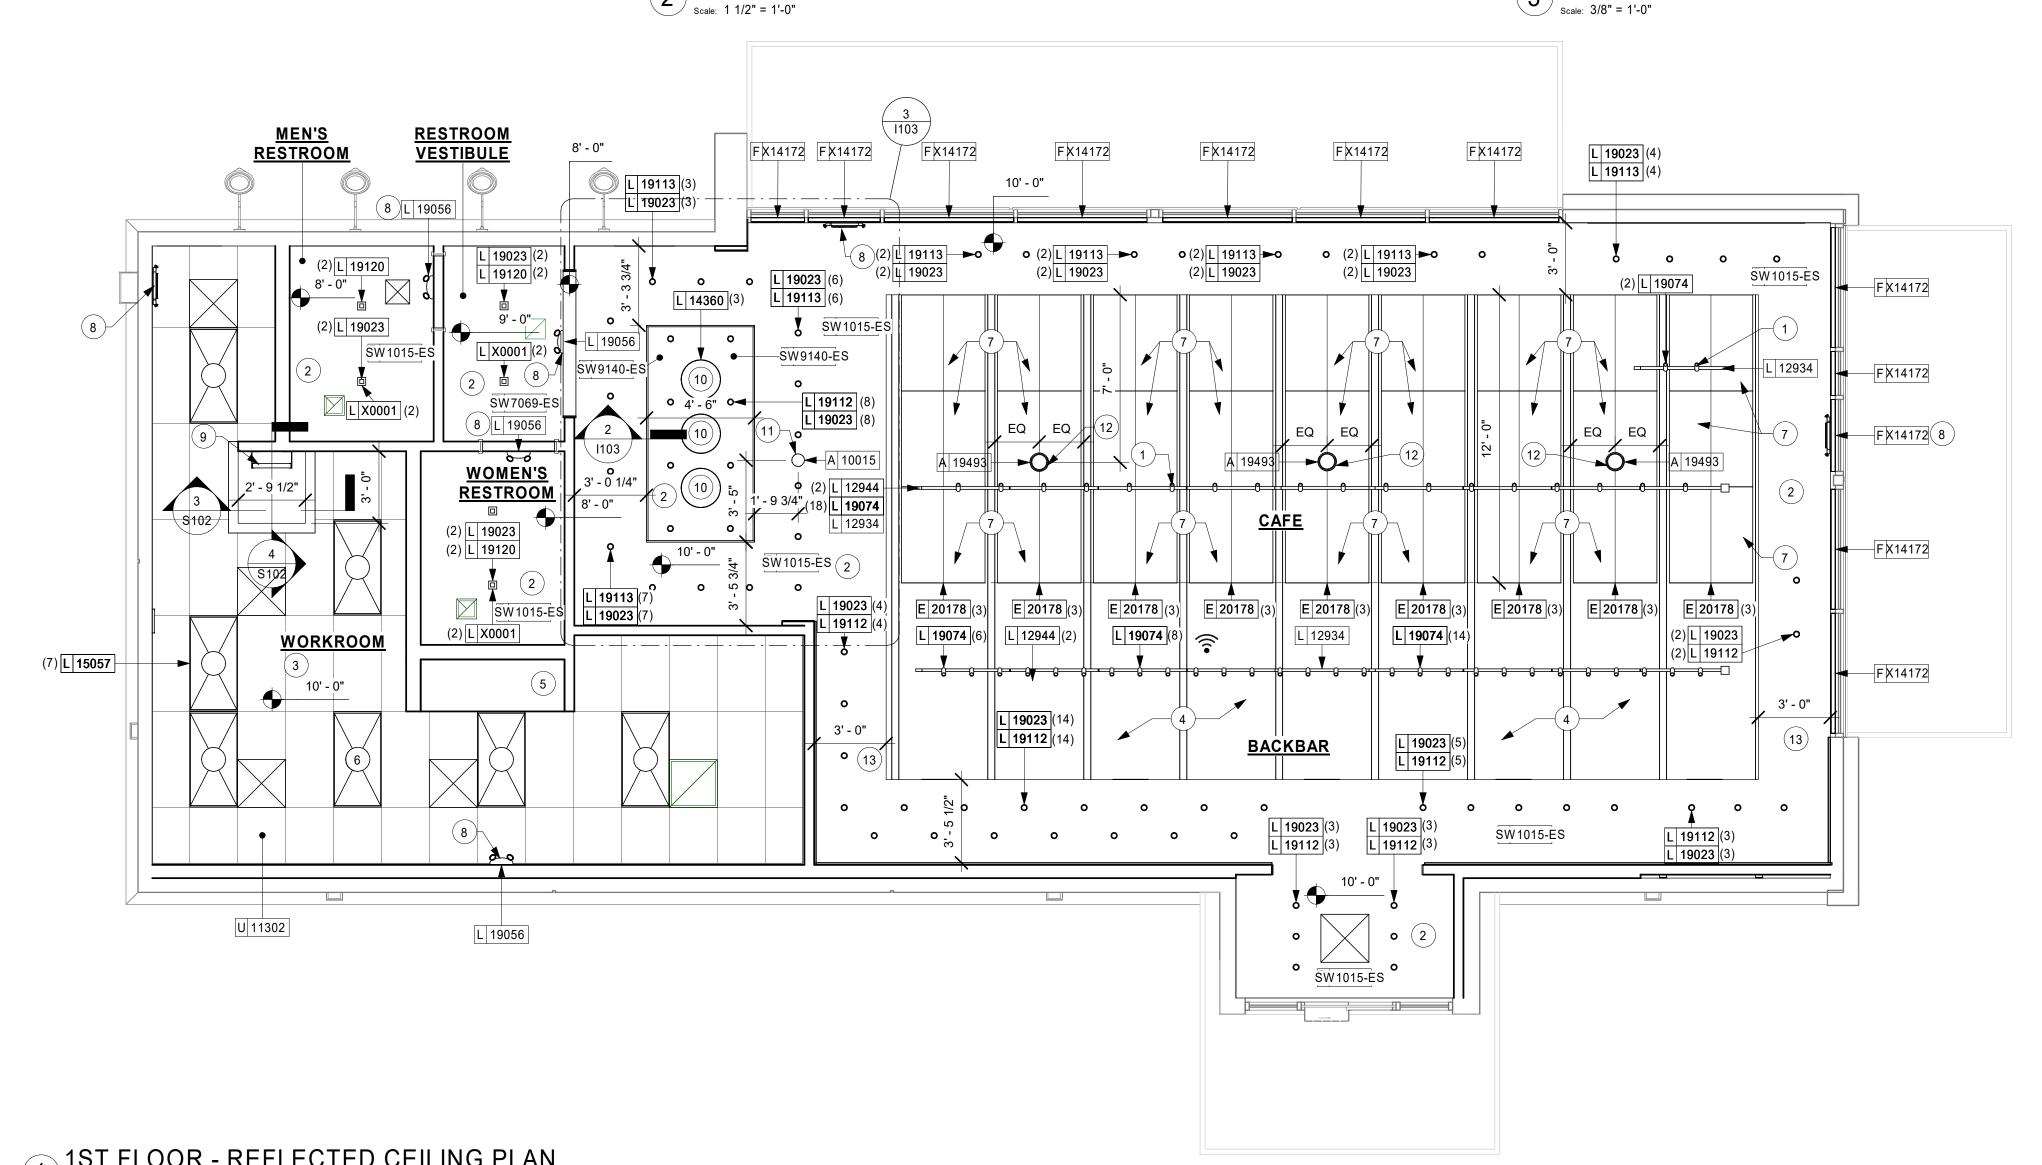

GENERAL NOTES

- A. IF REQUIRED BY LOCAL CODE. GENERAL CONTRACTOR TO PROVIDE SEMI-RECESSED SPRINKLER HEADS WITH POLISHED CHROME ESCUTCHEONS CENTERED IN ACOUSTICAL CEILING TILE. IF PENDANT HEADS ARE REQUIRED IN GWB SOFFIT OVER FRONTBAR, CONCEAL SUPPLY PIPING WITHIN SOFFIT. GENERAL CONTRACTOR TO SUBMIT SPRINKLER LAYOUT TO STARBUCKS' CONSTRUCTION MANAGER FOR APPROVAL PRIOR TO INSTALLATION.
- B. LEAVE TEN (10) ADDITIONAL RETAIL CEILING TILES TO MATCH RETAIL CEILING PAINT COLOR ABOVE THE WORKROOM CEILING AT MANAGER'S DESK FOR FUTURE
- C. PROVIDE GROMMET AT ACOUSTIC CEILING PENETRATIONS FOR FIXTURES OF SUPPORTS.
- D. HEATING, VENTILATING AND AIR CONDITIONING SHOWN ON THIS PLAN PROVIDED FOR REFERENCE ONLY. SEE MECHANICAL DRAWINGS FOR ADDITIONAL INFORMATION.
- E. DIFFUSERS AND RETURNS IN ACOUSTICAL CEILING TILE TO BE CENTERED IN TILE AND PAINTED TO MATCH ADJACENT FINISHES (TYP.).
- F. PAINT ALL EXPOSED HVAC DUCTS, HVAC DIFFUSERS, LIGHT TRIM RINGS, PIPING, CONDUIT AND JUNCTION BOXES THE SAME COLOR AS SPECIFIED ON SURROUNDING CEILING OR SOFFIT UNLESS OTHERWISE NOTED. TYPICAL THROUGHOUT RETAIL AREA OF STORE.
- G. PAINT SUBSTITUTIONS ARE NOT ALLOWED. USE STARBUCKS' NATIONAL ACCOUNT "COLOR CODE" WHEN ORDERING PAINTS.
- H. DATA CABLING ABOVE HEAD SHALL BE IN PLENUM WHEN AVAILABLE.
- I. DATA CABLING AT EXPOSED CEILING SHALL BE INSTALLED IN METAL CONDUIT OR PER LOCAL CODE REQUIREMENT.

KEYED NOTES

- 1. BOTTOM OF TRACK TO BE 14' 3"
- 2. GWB CEILING. PAINT CEILING DIFFUSERS AS INDICATED.
- 3. WASHABLE CEILING TILE LOCATED IN BACK OF HOUSE
- 4. OPEN TO STRUCTURE ABOVE. PAINT BOTTOM OF DECK AND TRUSSES SW9140-ES
- 5. PLATFORM FOR HEATER AND WATER FILTRATION. PROVIDE SOFFIT AND LIFT CEILING THIS AREA ONLY TO INSURE ADEQUATE CLEARANCE FOR SERVICING.
- 6. 2X4 LIGHT TROFFER, SEE ELECTRICAL, TYP.
- 7. ACOUSTIC PANEL. ATTACHED TO DECKING. PAINTED SW9140-ES. PANEL NOT TO EXTEND PAST FACE OF BAR
- 8. EXIT LIGHTING. SEE ELECTRICAL, TYP.
- 9. ROOF LADDER AND ACCESS HATCH TO BE PROVIDED BY
- 10. PENDANT LIGTHING SEE INTERIOR ELEVATIONS FOR MOUNTING HEIGHT
- 11. MOUNT CEILING SPEAKER FLUSH WITH CEILING
- 12. PENDANT SPEAKER, MOUNTED 15'-0" A.F.F.
- 13. COORDINATE SOFFIT EXTENT BASED ON DETAIL AT

LEGEND



EXIT SECURITY LIGHT


MUSIC SYSTEM PENDANT SPEAKER

WIFI ACCESS POINT (WAP)

RESPONSIBILITY LEGEND

GC GENERAL CONTRACTOR LL LANDLORD

SB STARBUCKS

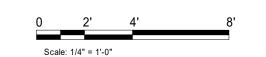





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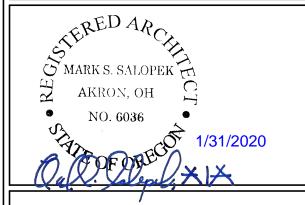
CHANGE AT ANYTIME) AND DO NOT REFLECT ACTUAL SITE CONDITIONS. NEITHER PARTY SHALL HAVE ANY OBLIGATION NOR LIABILITY TO THE OTHER (EXCEPT STATED ABOVE) UNTIL A WRITTEN AGREEMENT IS FULLY EXECUTED BY BOTH PARTIES.

STARBUCKS TEMPLATE VERSION: i2019-10-25



520 SOUTH MAIN ST, SUITE 2531 AKRON, OH 44311 P: 330-572-2100 F: 330-572-2101

GPD PROJECT NO: 2019355.20



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STORE #: 60983 PROJECT #: 84073-001 ISSUE DATE: 01-29-20 - 100 percent DESIGN MANAGER: RYAN WONG

PRODUCTION DESIGNER: GPD CHECKED BY:

Rev	Date	By	Description

Revision Schedule


SHEET TITLE: REFLECTED CEILING PLAN SCALE: AS SHOWN

SHEET NUMBER:

I103

1ST FLOOR - REFLECTED CEILING PLAN

| Scale: 1/4" = 1'-0"

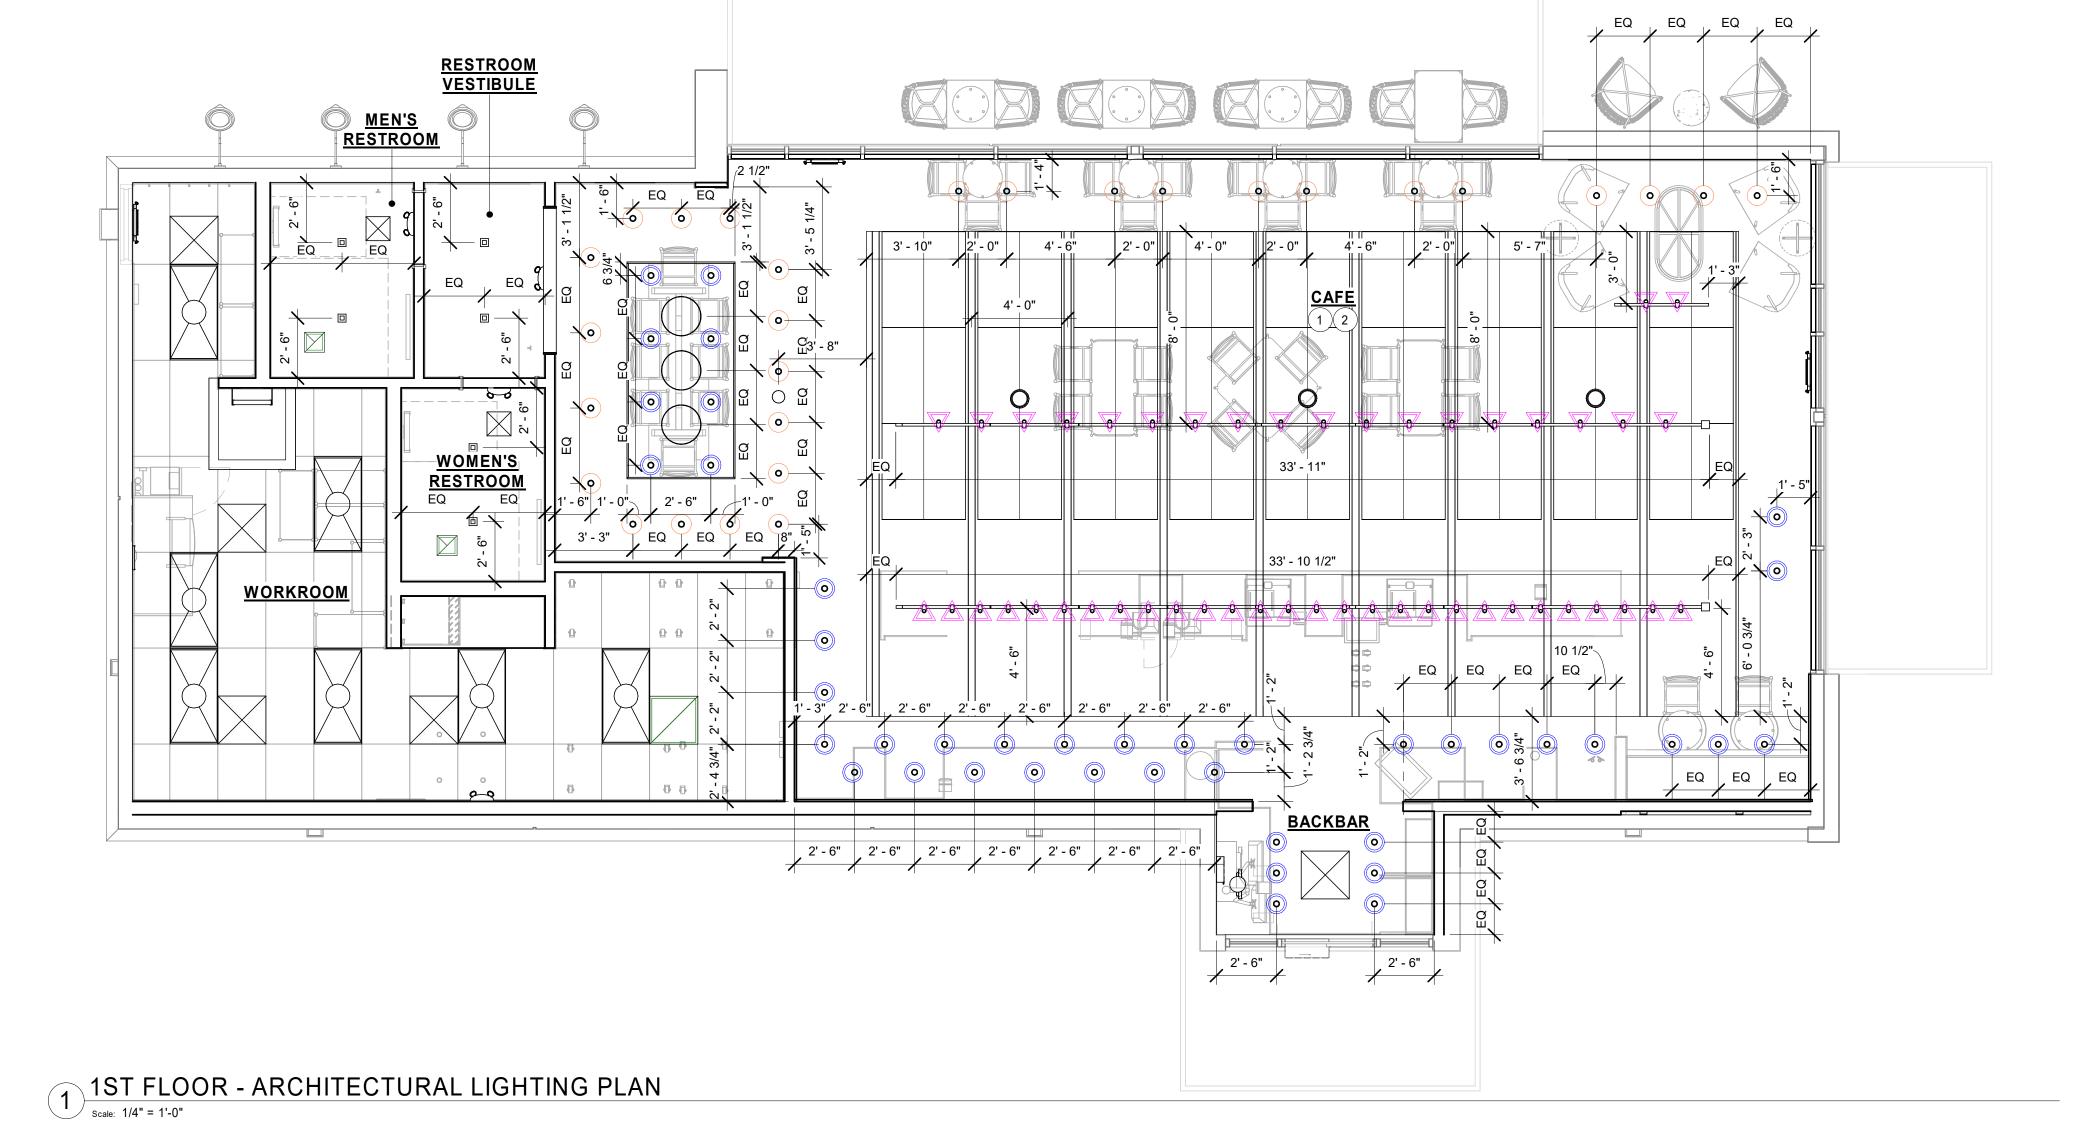

LIGHTING PLAN NOTES

- A. IF REQUIRED BY LOCAL CODE, GENERAL CONTRACTOR TO PROVIDE SEMI-RECESSED SPRINKLER HEADS WITH POLISHED CHROME ESCUTCHEONS CENTERED IN ACOUSTICAL CEILING TILE. IF PENDANT HEADS ARE REQUIRED IN GYPSUM SOFFIT OVER FRONTBAR, CONCEAL SUPPLY PIPING WITHIN SOFFIT. GENERAL CONTRACTOR TO SUBMIT SPRINKLER LAYOUT TO STARBUCKS' CONSTRUCTION MANAGER FOR APPROVAL PRIOR TO INSTALLATION.
- B. GENERAL CONTRACTOR TO PROVIDE AND LOCATE SPRINKLERS PER LOCAL CODES. CONTACT STARBUCKS CONSTRUCTION MANAGER IF DESIGN INTENT IS
- C. WHERE ACOUSTICAL CEILING MEETS WALL, PROVIDE ANGLE WALL MOLDING FOR REVEAL. MATCH CEILING GRID COLOR WHEN APPLICABLE.
- D. LEAVE (10) ADDITIONAL RETAIL CEILING TILES, TO MATCH RETAIL CEILING PAINT COLOR, ABOVE THE WORKROOM CEILING AT MANAGER'S DESK FOR FUTURE USE.
- E. PROVIDE GROMMET AT ALL CEILING PENETRATIONS FOR FIXTURES OR SUPPORTS.
- F. HEATING, VENTILATING, AND AIR CONDITIONING (HVAC) SHOWN FOR DESIGN INTENT ONLY. CONTACT PROJECT MANAGER IF CHANGED.
- G. DIFFUSERS AND RETURNS AT BACKBAR IN ACOUSTICAL CEILING TILE TO BE CENTERED IN TILE, PAINTED TO MATCH ADJACENT FINISHES, TYPICAL.
- H. PAINT ALL EXPOSED HVAC DUCTS, HVAC DIFFUSERS, RECESSED SPEAKERS, LIGHT TRIM RINGS, PIPING, CONDUIT AND JUNCTION BOXES THE SAME COLOR AS SPECIFIED ON SURROUNDING CEILING OR SOFFIT UNLESS NOTED OTHERWISE. TYPICAL THROUGHOUT RETAIL AREA OF STORE.
- J. PAINT SUBSTITUTIONS ARE NOT ALLOWED. USE STARBUCKS' NATIONAL ACCOUNT "COLOR CODE" WHEN ORDERING PAINTS.
- K. SEE LIGHTING DESIGN PLAN FOR LIGHTING SCHEDULE, FIXTURE TYPES AND DIMENSIONED LOCATIONS.
- L. ADJUST EACH TRACK HEAD AT MENU BOARD LIGHTING SO LIGHT BEAMS ARE POINTING CONSISTENTLY, JUST BELOW THE CENTER OF EACH MENU BOARD PANEL.. ADJUST FOCUS OF ALL TRACK AND RECESSED DIRECTIONAL LIGHTING TO FULLY ILLUMINATE ALL ARTWORK, MENU BOARDS, AND MERCHANDISE BAYS.
- M. ALL FIXTURES IN FOOD PREPARATION AREA SHALL HAVE SHATTERPROOF LAMPS IF THE FIXTURE IS NOT LENSED.
- N. CENTER EMERGENCY/EXIT LIGHTS ABOVE DOORS, UON.

SHEET NOTES

- 1. OPEN STRUCTURE ABOVE
- 2. EXPOSED STRUCTURE AND DUCTWORK TO BE PAINTED AS SCHEDULED

LIGHTING LEGEND

TRACK HEAD: FLOOD (2" HOUSING DID 19074)

CAN FIXTURE: SPOT (2", DID 19112)

CAN FIXTURE:
NARROW FLOOD (2" DID 19113)

RESPONSIBILITY LEGEND

GC GENERAL CONTRACTOR LL LANDLORD SB STARBUCKS







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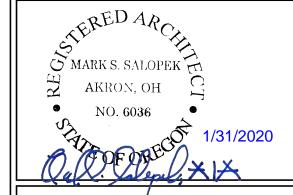
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STARBUCKS TEMPLATE VERSION: i2019-10-25



520 SOUTH MAIN ST, SUITE 2531 AKRON, OH 44311 P: 330-572-2100 F: 330-572-2101

GPD PROJECT NO: 2019355.20



PROJECT NAME:
HWY 101 - COOS BAY
PROJECT ADDRESS:
101, COOS BAY VILLAGE
COOS BAY, OR 97420

STORE #: 60983

PROJECT #: 84073-001

ISSUE DATE: 01-29-20 - 100 percent

DESIGN MANAGER: RYAN WONG PRODUCTION DESIGNER: GPD CHECKED BY: TC

Revision	Schedule

ı	Rev	Date	Ву	Description
ı				
ı				
ı				
ı				
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EET TITLE:

LIGHTING PLAN

SCALE: AS SHOWN

SHEET NUMBER:

I103B

FINISHING PROCESS FOR CONCRETE SLAB

- INTEGRAL GRINDING WILL BEGIN AT A MINIMUM OF 36 HYBRID BOND DIAMOND GRIT. AFTER A UNIFORM SCRATCH PATTERN HAS BEEN DEVELOPED IN THE SURFACE OF THE CONCRETE; BEGIN GRINDING THE FLOOR UP TO A DIAMOND GRIT ACCEPTABLE FOR DENSIFING. LEVEL OF FINISH TO BE [OPEN AGGREGATE, SALT & PEPPER, LIGHT SAND]. GC TO HAND GRIND OR USE A STAND-UP EDGER FOR GRINDING/POLISHING EDGE AND INSIDE CORNER CONDITIONS.
- CLEAN FLOOR WITH VEXCON CERTI-SHINE CLEAR DENSIFIER APPLIED IN MULTIPLE COATS.
 AFTER THE DENSIFIER HAS CURED, RINSE THE FLOOR WITH VEXCON CERTI-SHINE FIXATIVE, REMOVING UN-REACTED SILICATES FROM THE SURFACE OF THE CONCRETE AND IMPROVING. THE CHEMICAL AND STAIN RESISTANCE OF
- REACTED SILICATES FROM THE SURFACE OF THE CONCRETE AND IMPROVING THE CHEMICAL AND STAIN RESISTANCE OF THE POLISHED CONCRETE SYSTEM.

 ONCE THE RINSE HAS BEEN COMPLETED CONTINUE POLISHING THE FLOOR UP TO A 400 GRIT POLISH.
- CLEAN FLOOR AGAIN AND APPLY A VEXCON CERTISHINE FINISH COAT ULTRA WB IN MULTIPLE COATS. ALLOWING FOR OPTIMAL PENETRATION.
- AFTER THE STAIN PROTECTANT HAS CURED, BURNISH THE FLOOR WITH A HIGH SPEED BUFFER.

POLISHING PROCEDURE:

- ADHERE TO INDUSTRY STANDARD POLISHING PROCEDURES FOR DRY AND WET GRINDING/POLISHING IS ACCEPTABLE WHEN INDUSTRY STANDARD POLISHING PROCEDURES ARE ADHERED TO.
- SCRUB AND RINSE SLAB SURFACE WITH CLEAN WATER AND VACUUM WITH AUTO-SCRUBBER BETWEEN AND AFTER FINAL POLISHING PASSES..
- SEQUENTIAL PROGRESSION OF DIAMOND POLISHING STEPS SHALL BE REQUIRED AND LIMITED TO NO MORE THAN DOUBLE THE GRIT VALUE OF THE PREVIOUS DIAMONDS USED.
- DOUBLE THE GRIT VALUE OF THE PREVIOUS DIAMONDS USED.
 OVERLAP ADJACENT POLISHING PASSES BY 25 PERCENT
- PERFORM EACH PASS PERPENDICULAR TO THE OTHER PASS NORTH/SOUTH THEN EAST/WEST; MULTIPLE PASSES MAY BE NEEDED.
- PROGRESSIVELY GRIND AND POLISH THE SLAB SURFACE UTILIZING APPROVED DIAMOND SEGMENTS AS NECESSARY TO PRODUCE FINISHING REQUIREMENTS.

PREPARATION:

- Clean dirt, dust, oil, grease and other contaminants that interfere with penetration or performance of specified product from surfaces. Use appropriate concrete cleaners approved by the concrete surface treatment manufacturer where necessary. Rinse
- thoroughly using pressure water spray to remove cleaner residues. Allow surfaces to dry completely before application of product.

 Repair, patch and fill cracks, voids, defects and damaged areas in surface as approved by the Architect. Allow repair materials to
- cure completely before application of product.
 Variations in substrate texture and color will affect final appearance and should be corrected prior to application of sealer/hardener
- system and the polishing steps.
 Protect surrounding areas prior to application of densifiers and stains. If products are accidentally misapplied to adjacent surfaces,
- flush with water immediately before material dries.

 Avoid contact in areas not to be treated. Avoid contact with metal, glass and painted surfaces.
- Apply specified sealants and caulking and allow complete curing before application of penetrating concrete hardener/densifier.
 Test surfaces with droplets of water. If water beads and does not penetrate surface, or penetrates only in some areas, profile
- surfaces by grinding, sanding, or abrasive blasting. Retest and continue profiling surface until water droplets immediately darken and uniformly penetrate concrete surfaces.

SET TOOM WORKSOM WORKSOM BESTROOM TYPES BACKBAR DISTRICT BACKBA

KEYED NOTES

- 1. FLOOR SINK LOCATION. SEE BUILDING FLOOR PENETRATION PLAN ON SHEET A102 AND PLUMBING FOR ADDITIONAL INFORMATION.
- 2. RECESSED WALK-OFF MAT AT ENTRY. SEE INTERIOR DETAIL SHEETS FOR TRANSITION.
- 3. MOP SINK WHERE INDICATED. SEE PLUMBING PLANS FOR MORE INFORMATION.
- 4. GREASE INTERCEPTOR, SEE PLUMBING PLANS FOR MORE INFORMATION.

GENERAL NOTES

- A. WORKROOM TO BE FINISHED PER LOCAL CODE REQUIREMENTS.
- B. FLOORS, WALLS AND CEILING FINISHES IN FOOD PREPARATION AREAS SHALL BE SMOOTH, NON-TOXIC, NON-ABSORBENT, DURABLE AND EASILY CLEANABLE. PAINT SHALL BE WASHABLE; SEMI-GLOSS OR HIGH-GLOSS FINISH.
- C. STARBUCKS TO SUPPLY FLOORING AND BASE FOR FRONT AND BACK OF HOUSE AS NOTED IN SCHEDULES. GENERAL CONTRACTOR TO INSTALL. GENERAL CONTRACTOR TO SUPPLY WORKROOM TILE AND BASE AND INSTALL. GENERAL CONTRACTOR TO SUPPLY AND INSTALL MORTAR, ADHESIVE, AND GROUT. GENERAL CONTRACTOR TO INSPECT ALL TILES AND REJECT DAMAGED OR SUBSTANDARD TILES PRIOR TO INSTALLATION.
- D. ALIGN TILE TRANSITIONS ON WHOLE TILES AS SHOWN.
- E. ALL FLOOR AND WALL JUNCTIONS IN STORAGE AND FOOD PREPARATION AREAS SHALL HAVE A 6" COVED BASE.

LEGEND

---- INDICATES LAMINATE MOTTLED BLACK (DID : PL019)*

____ - - ___ INDICATES FULL HEIGHT FRP PANELING ABOVE

TILE BASE (WHITE FRP -DID: 11469)*

__ - _ INDICATES WALL COVERING - RUSHMORE

2VRM-14 GEMSTONE ABOVE TILE BASE (DID: X2000)*

INDICATES RESTROOM WALL TILE PRO ARCHITECTURA GREY- 4X12IN ABOVE TILE BASE

(DID: 14744)**

INDICATES PAINT SW7069 - IRON ORE ABOVE

TILE BASE (DID : SW7069-ES)*

— - - - — INDICATES WOOD CLADDING OVER TALL BACKSPLASH (WD0073)*

INDICATES TILE BASE 6X12IN

(DID : 14770) GRAPHITE

INDICATES METAL END CAP (MT0011)

INDICATES METAL BASE (MT0011).


INDICATES STAINLESS STEEL CORNER GUARD FOR BOH OR HOT ROLLED STEEL CORNER GUARD FOR CAFE SPACE. INSTALL 6" (150mm) TO 42" (1065mm) A.F.F. UNLESS OTHERWISE

*SEE INTERIOR FINISH ELEVATIONS FOR TAGGED LOCATION OF WALL FINISH MATERIAL

**SEE RESTROOM PLAN & ELEVATIONS FOR TAGGED LOCATION OF WALL FINISH MATERIAL

RESPONSIBILITY LEGEND

GC GENERAL CONTRACTOR LL LANDLORD SB STARBUCKS

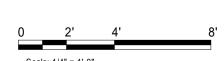





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WRITTEN AGREEMENT IS FULLY EXECUTED BY


BOTH PARTIES.

STARBUCKS TEMPLATE VERSION: i2019-10-25



AKRON, OH 44311 P: 330-572-2100 F: 330-572-2101

GPD PROJECT NO: 2019355.20

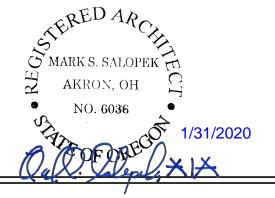

PROJECT NAME:

HWY 101 - COOS BAY

101, COOS BAY VILLAGE

COOS BAY, OR 97420

 STORE #:
 60983

 PROJECT #:
 84073-001

 ISSUE DATE:
 01-29-20 - 100 percent

 DESIGN MANAGER:
 RYAN WONG

PRODUCTION DESIGNER: GPD

Revision Schedule

Rev Date By Description

SHEET TITLE:

CHECKED BY:

INTERIOR FINISH PLAN

SCALE: AS SHOWN

SHEET NUMBER:

WINDOW SHADES, TYP.

2. SHELVING FOR CBE STATION AS SHOWN. G.C. TO PROVIDE WALL BLOCKING FOR FASTENERS.

3. CUP DISPENSERS. SEE FF & E PLAN ON SHEET I101 FOR ADDITIONAL INFORMATION.

4. WALL FINISH BEHIND EXPOSED CABINETRY AND BELOW UNDERSIDE OF COUNTERTOP SUBSTRATE TO BE FRP.

5. ACOUSTIC PANEL. ATTACHED TO DECKING. PAINTED SW9140-ES. PANEL NOT TO EXTEND PAST FACE OF BAR BELOW

6. PENDANT LIGHT FIXTURE (SEE REFLECTED CEILING PLAN ON SHEET I103 AND LIGHTING PLAN ON SHEET E102 FOR ADDITIONAL INFORMATION).

7. EXPOSED STRUCTURE TO BE PAINTED AS SCHEDULED

8. METAL BASE LOCATED AT FRONTBAR AT CAFE SIDE ONLY.

GENERAL NOTES

GLOSS FINISH.

- A. FOR GRAPHICS SCHEDULE, REFER TO THE FURNITURE, FIXTURES, AND EQUIPMENT (FF & E) SCHEDULES ON SHEET 1601.
- B. REFER TO MANUFACTURER'S INSTRUCTIONS INCLUDED WITH ARTWORK/GRAPHICS FOR PROPER INSTALLATION.
- C. CHANGE PAINT COLOR ONLY AT INSIDE CORNERS
- D. PAINT FINISHES SHALL BE APPLIED AS FOLLOWS,
- UNLESS NOTED OTHERWISE: 1) WOODS AND METAL SURFACES SHALL BE

UNLESS OTHERWISE INDICATED.


- SEMI-GLOSS OR EQUAL. 2) ACCENT AND TRIM PAINTS TO BE SEMI-GLOSS OR
- EQUAL. a. WALL AND CEILING PAINTS TO BE EGGSHELL OR
- 3) PAINTS IN BOH, RESTROOM(S) OR CAFE BAR SHALL


STARBUCKS NATIONAL ACCOUNT COLOR CODE WHEN

- BE SEMI-GLOSS OR EQUAL. E. PAINT SUBSTITUTIONS ARE NOT ALLOWED. USE
- ORDERING PAINTS. F. FLOORS, WALLS AND CEILING FINISHES IN FOOD PREPARATION AREAS SHALL BE SMOOTH, NON-TOXIC, NON-ABSORBENT, DURABLE AND EASILY CLEANABLE.

PAINT SHALL BE WASHABLE; SEMI-GLOSS OR HIGH

- G. ALL WOOD SURFACES (DOORS, TRIM, SHELVES, CABINETRY) SHALL BE SEALED.
- H. REFER TO CASEWORK FINISH SCHEDULE ON THE CASEWORK FINISH PLAN ON SHEET 1102 FOR CASEWORK FINISH MATERIAL INFORMATION.
- I. ALIGN TILE TRANSITIONS ON WHOLE TILES AS SHOWN.
- J. ALL FLOOR AND WALL JUNCTIONS IN STORAGE AND FOOD PREPARATION AREAS SHALL HAVE A 6" COVED
- K. ALL FOOD STORAGE SHALL BE 6" (150MM) A.F.F.
- L. INSTALL BLOCKING AND HANGERS FOR WALL SHELVING BEFORE INSTALLING BACK BAR TILE.
- M. GENERAL CONTRACTOR TO PROVIDE AND INSTALL WORKROOM WALL FINISHES.

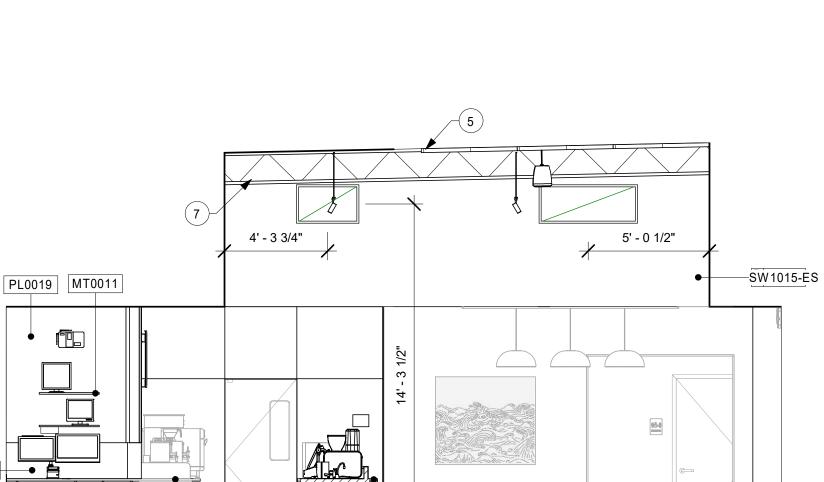

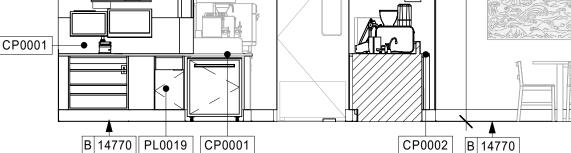

DT POS - COMMUNITY TABLE

scale: 1/4" = 1'-0"


3' - 0"

G20561A

G20561B

B 14770

X2000

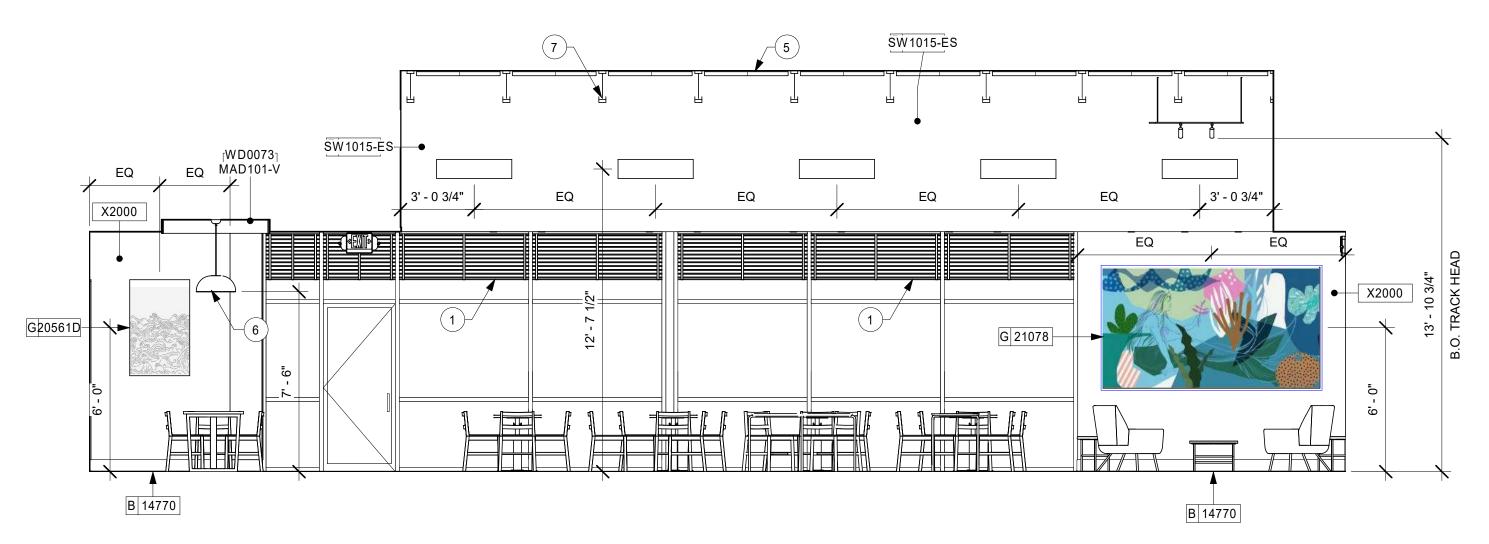

- 2 3/4"

EQ

EQ

CAFE
scale: 1/4" = 1'-0"

EQ

FRONT BAR-CUSTOMERS SIDE

EQ

EQ


B X1448

EQ

|WD0073| |MAD101-V | CP0002


EQ

[WD0073] MAD101-V CP0002

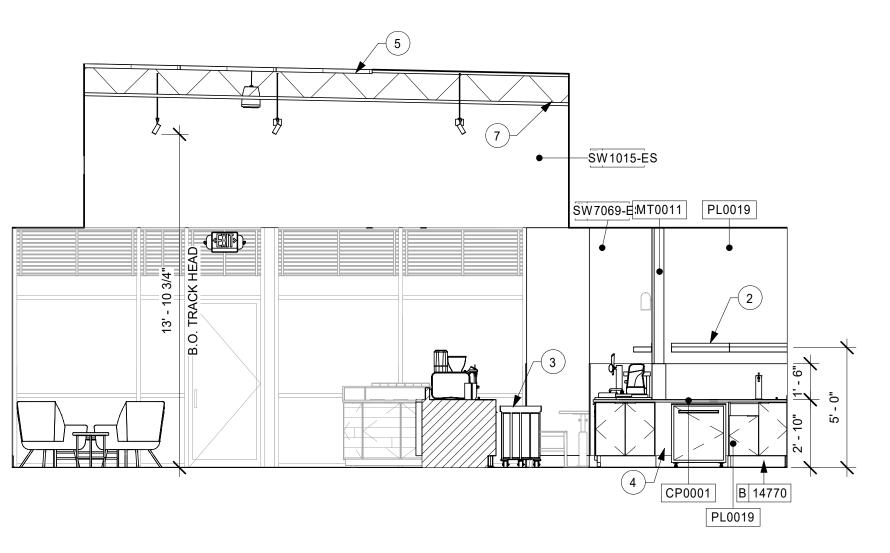

2 CAFE - CONDIMENT-BACKBAR

Scale: 1/4" = 1'-0"

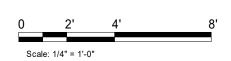



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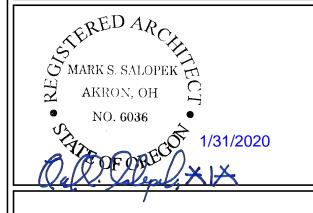
BOTH PARTIES.

STARBUCKS TEMPLATE VERSION: i2019-10-25



520 SOUTH MAIN ST, SUITE 2531 AKRON, OH 44311 P: 330-572-2100 F: 330-572-2101

GPD PROJECT NO: 2019355.20



PROJECT ADDRESS: 101, COOS BAY VILLAGE COOS BAY, OR 97420

60983 STORE #: 84073-001 PROJECT #: ISSUE DATE: DESIGN MANAGER: RYAN WONG

PRODUCTION DESIGNER: GPD

CHECKED BY:

Revision Schedule

INTERIOR FINISH ELEVATIONS SCALE: AS SHOWN

SHEET NUMBER:

- 1. ACOUSTIC PANEL. ATTACHED TO DECKING. PAINTED SW9140-ES. PANEL NOT TO EXTEND PAST FACE OF BAR BELOW
- 2. SHELVING FOR CBE STATION AS SHOWN. G.C. TO PROVIDE WALL BLOCKING FOR FASTENERS.
- 3. CUP DISPENSERS. SEE FF & E PLAN ON SHEET I101 FOR ADDITIONAL INFORMATION.
- 4. WALL SCONCE LIGHT FIXTURE (SEE REFLECTED CEILING PLAN ON SHEET I103 AND LIGHTING PLAN ON SHEET E102 FOR ADDITIONAL INFORMATION).
- 5. WINDOW SHADES. TYP.
- 6. EXPOSED STRUCTURE TO BE PAINTED AS SCHEDULED

- SHEET I601.
- B. REFER TO MANUFACTURER'S INSTRUCTIONS INCLUDED
- C. CHANGE PAINT COLOR ONLY AT INSIDE CORNERS UNLESS OTHERWISE INDICATED.
- UNLESS NOTED OTHERWISE:
- 2) ACCENT AND TRIM PAINTS TO BE SEMI-GLOSS OR
- a. WALL AND CEILING PAINTS TO BE EGGSHELL OR EQUAL.
- STARBUCKS NATIONAL ACCOUNT COLOR CODE WHEN ORDERING PAINTS.
- F. FLOORS, WALLS AND CEILING FINISHES IN FOOD PREPARATION AREAS SHALL BE SMOOTH, NON-TOXIC, NON-ABSORBENT, DURABLE AND EASILY CLEANABLE. PAINT SHALL BE WASHABLE; SEMI-GLOSS OR HIGH GLOSS FINISH.
- G. ALL WOOD SURFACES (DOORS, TRIM, SHELVES, CABINETRY) SHALL BE SEALED.
- I. ALIGN TILE TRANSITIONS ON WHOLE TILES AS SHOWN.
- J. ALL FLOOR AND WALL JUNCTIONS IN STORAGE AND FOOD PREPARATION AREAS SHALL HAVE A 6" COVED
- K. ALL FOOD STORAGE SHALL BE 6" (150MM) A.F.F.
- L. INSTALL BLOCKING AND HANGERS FOR WALL SHELVING BEFORE INSTALLING BACK BAR TILE.

GENERAL NOTES

- A. FOR GRAPHICS SCHEDULE, REFER TO THE FURNITURE, FIXTURES, AND EQUIPMENT (FF & E) SCHEDULES ON
- WITH ARTWORK/GRAPHICS FOR PROPER INSTALLATION.
- D. PAINT FINISHES SHALL BE APPLIED AS FOLLOWS,
- 1) WOODS AND METAL SURFACES SHALL BE
- SEMI-GLOSS OR EQUAL.
- 3) PAINTS IN BOH, RESTROOM(S) OR CAFE BAR SHALL BE SEMI-GLOSS OR EQUAL.
- E. PAINT SUBSTITUTIONS ARE NOT ALLOWED. USE

- H. REFER TO CASEWORK FINISH SCHEDULE ON THE CASEWORK FINISH PLAN ON SHEET I102 FOR CASEWORK FINISH MATERIAL INFORMATION.

- M. GENERAL CONTRACTOR TO PROVIDE AND INSTALL WORKROOM WALL FINISHES.



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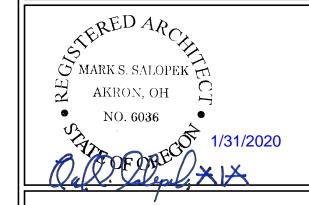
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STARBUCKS TEMPLATE VERSION: i2019-10-25



520 SOUTH MAIN ST, SUITE 2531 AKRON, OH 44311 P: 330-572-2100 F: 330-572-2101

GPD PROJECT NO: 2019355.20



PROJECT ADDRESS: 101, COOS BAY VILLAGE COOS BAY, OR 97420 PROJE HW

PRODUCTION DESIGNER: GPD CHECKED BY: **Revision Schedule**

60983

84073-001

RYAN WONG

01-29-20 - 100 percent

STORE #:


ISSUE DATE:


PROJECT #:


DESIGN MANAGER:

INTERIOR FINISH ELEVATIONS SCALE: AS SHOWN

SHEET NUMBER:

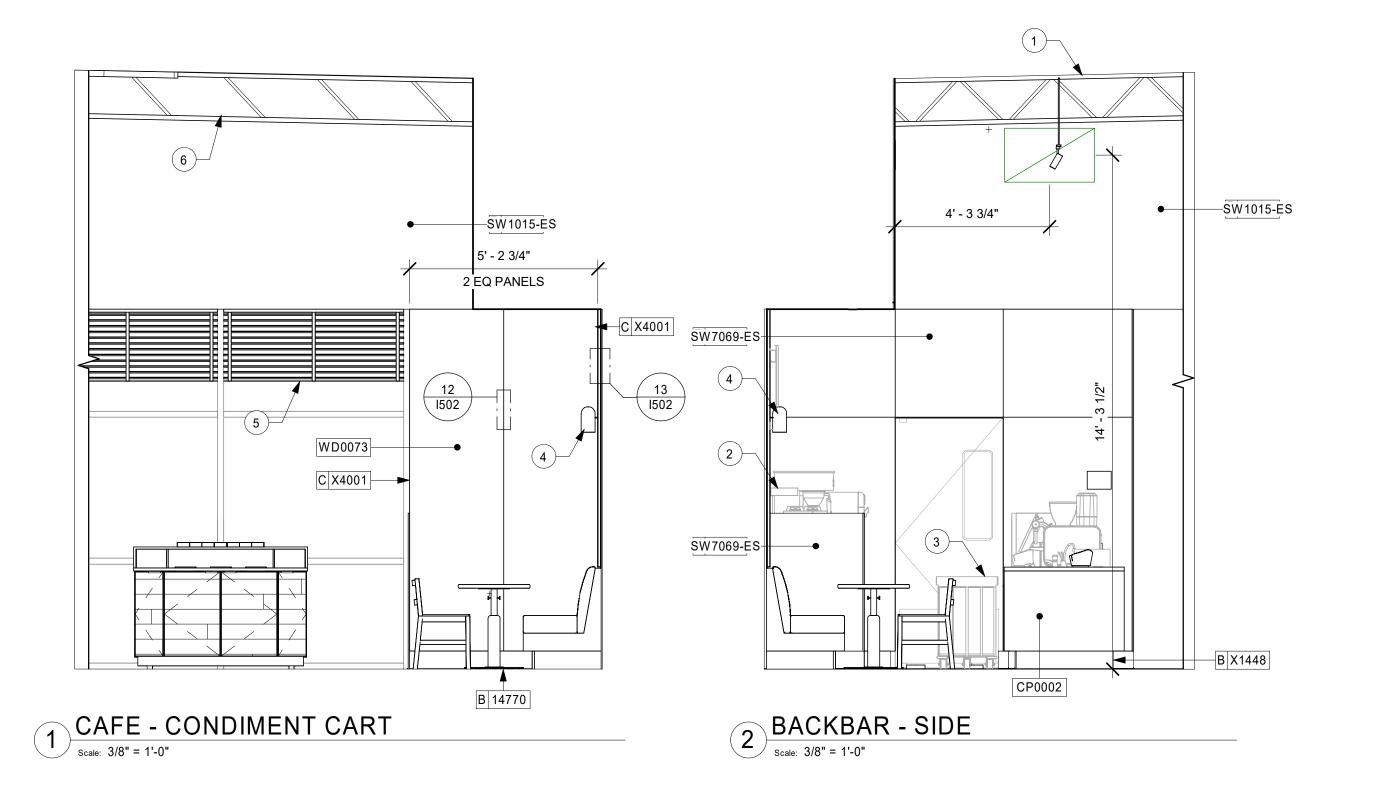

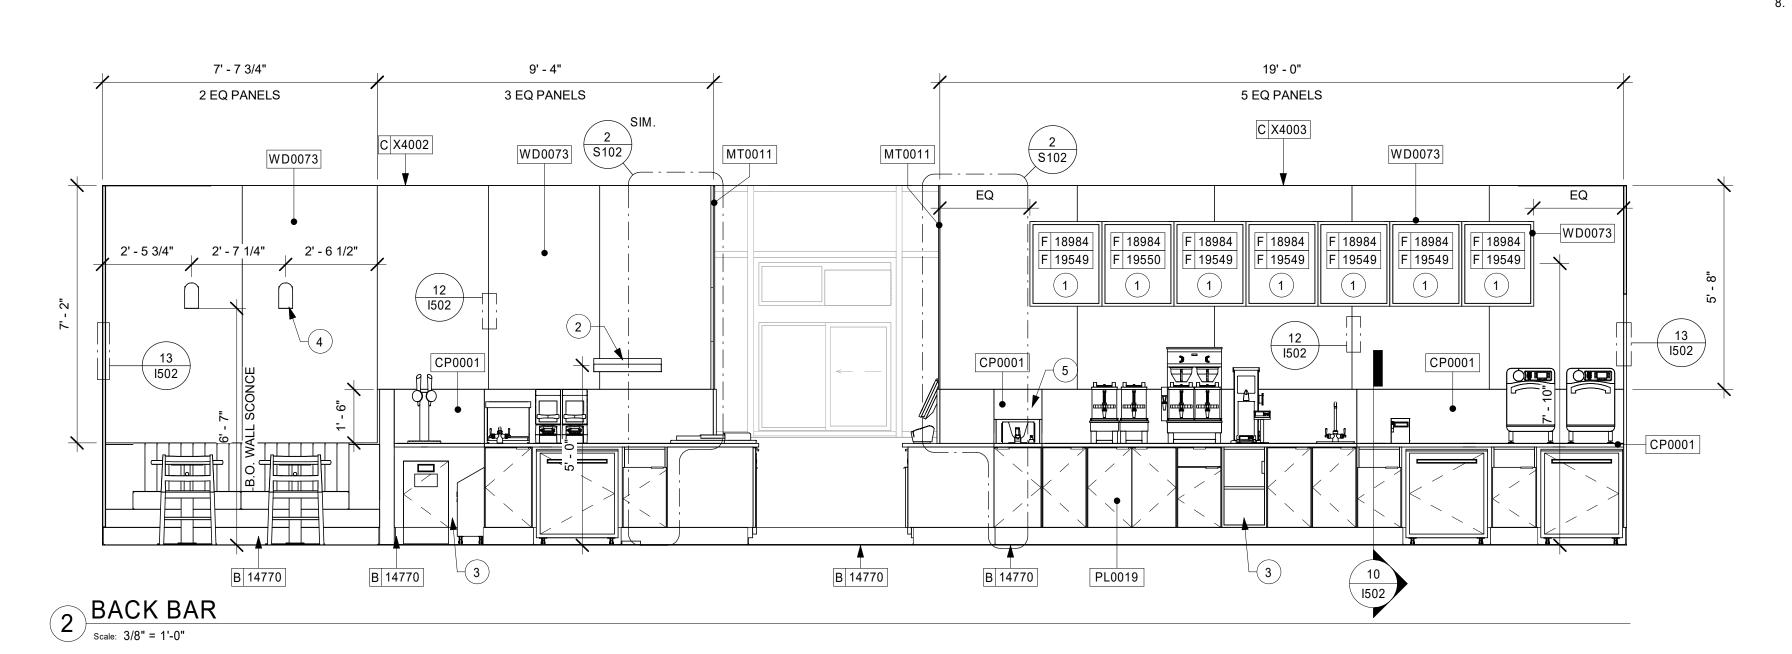

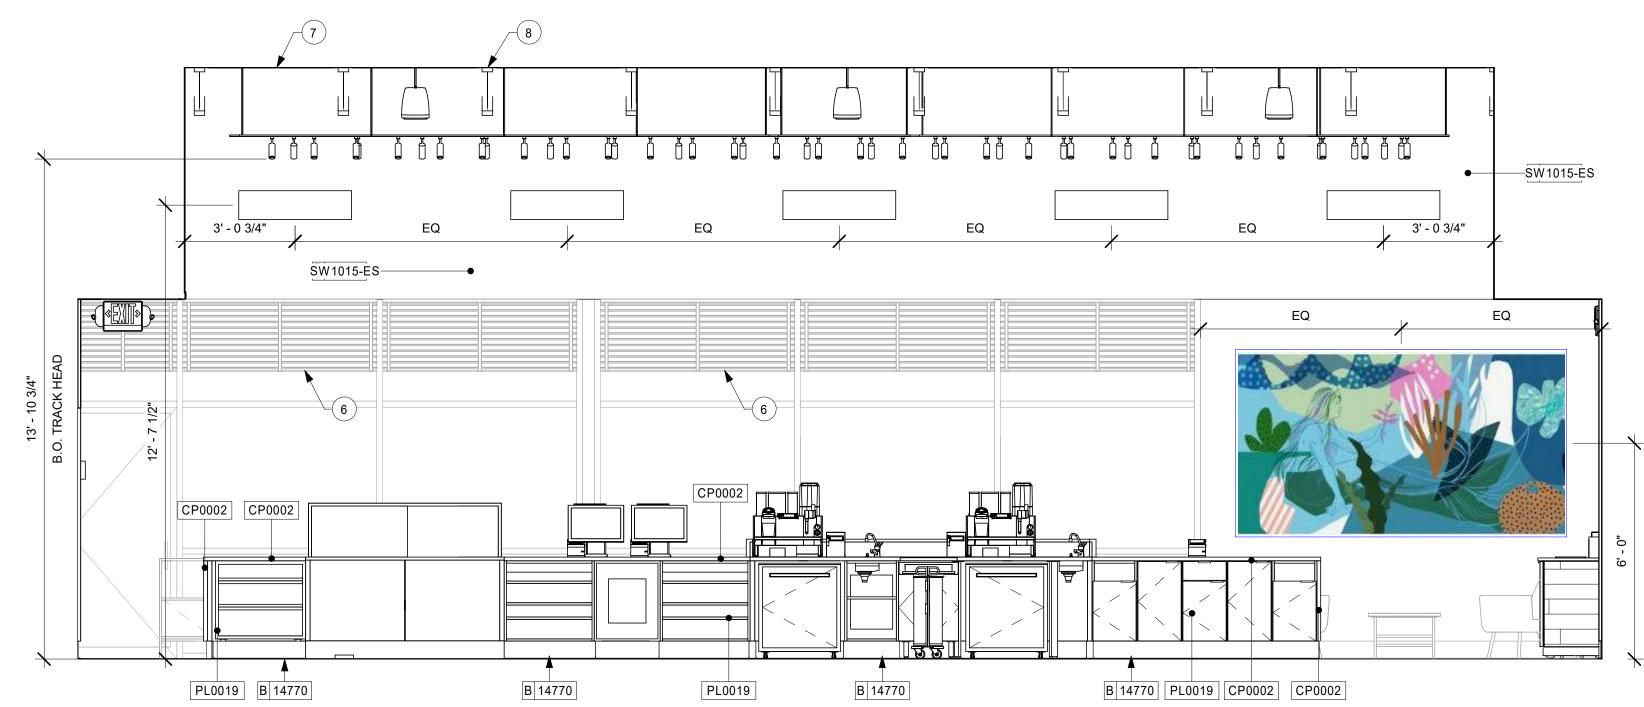

1 FRONT BAR PARTNERS SIDE

KEYED NOTES

- 1. ATTACH MENU BOARDS PER INSTALLATION DETAILS.
- 2. SHELVING FOR CBE STATION AS SHOWN. G.C. TO PROVIDE WALL BLOCKING FOR FASTENERS.
- 3. WALL FINISH BEHIND EXPOSED CABINETRY AND BELOW UNDERSIDE OF COUNTERTOP SUBSTRATE TO BE FRP.
- 4. WALL SCONCE (SEE REFLECTED CEILING PLAN ON SHEET I103 AND LIGHTING PLAN ON SHEET E102 FOR ADDITIONAL INFORMATION).
- 5. PROVIDE 6" (150MM) MIN. INTEGRAL SPLASHGUARD AT HAND SINK PER JURISDICTIONAL REQUIREMENTS.
- 6. WINDOW SHADES. TYP.
- 7. ACOUSTIC PANEL, ATTACHED TO DECKING, PAINTED SW9140-ES. PANEL NOT TO EXTEND PAST FACE OF BAR
- 8. EXPOSED STRUCTURE TO BE PAINTED AS SCHEDULED

GENERAL NOTES

- A. FOR GRAPHICS SCHEDULE, REFER TO THE FURNITURE, FIXTURES, AND EQUIPMENT (FF & E) SCHEDULES ON SHEET I601.
- B. REFER TO MANUFACTURER'S INSTRUCTIONS INCLUDED WITH ARTWORK/GRAPHICS FOR PROPER INSTALLATION.
- C. CHANGE PAINT COLOR ONLY AT INSIDE CORNERS UNLESS OTHERWISE INDICATED.
- D. PAINT FINISHES SHALL BE APPLIED AS FOLLOWS, UNLESS NOTED OTHERWISE: 1) WOODS AND METAL SURFACES SHALL BE
- SEMI-GLOSS OR EQUAL. 2) ACCENT AND TRIM PAINTS TO BE SEMI-GLOSS OR
 - EQUAL. a. WALL AND CEILING PAINTS TO BE EGGSHELL OR
- EQUAL. 3) PAINTS IN BOH, RESTROOM(S) OR CAFE BAR SHALL BE SEMI-GLOSS OR EQUAL.
- E. PAINT SUBSTITUTIONS ARE NOT ALLOWED. USE STARBUCKS NATIONAL ACCOUNT COLOR CODE WHEN ORDERING PAINTS.
- F. FLOORS, WALLS AND CEILING FINISHES IN FOOD PREPARATION AREAS SHALL BE SMOOTH, NON-TOXIC, NON-ABSORBENT, DURABLE AND EASILY CLEANABLE. PAINT SHALL BE WASHABLE; SEMI-GLOSS OR HIGH GLOSS FINISH.
- G. ALL WOOD SURFACES (DOORS, TRIM, SHELVES, CABINETRY) SHALL BE SEALED.
- H. REFER TO CASEWORK FINISH SCHEDULE ON THE CASEWORK FINISH PLAN ON SHEET I102 FOR CASEWORK FINISH MATERIAL INFORMATION.
- I. ALIGN TILE TRANSITIONS ON WHOLE TILES AS SHOWN.
- J. ALL FLOOR AND WALL JUNCTIONS IN STORAGE AND FOOD PREPARATION AREAS SHALL HAVE A 6" COVED
- K. ALL FOOD STORAGE SHALL BE 6" (150MM) A.F.F.
- L. INSTALL BLOCKING AND HANGERS FOR WALL SHELVING BEFORE INSTALLING BACK BAR TILE.
- M. GENERAL CONTRACTOR TO PROVIDE AND INSTALL WORKROOM WALL FINISHES.



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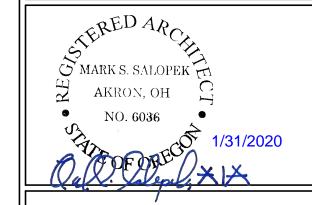
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STARBUCKS TEMPLATE VERSION: i2019-10-25



520 SOUTH MAIN ST, SUITE 2531 AKRON, OH 44311 P: 330-572-2100 F: 330-572-2101

GPD PROJECT NO: 2019355.20



PROJECT ADDRESS: 101, COOS BAY COOS BAY OR 9

DESIGN MANAGER: RYAN WONG PRODUCTION DESIGNER: GPD CHECKED BY: **Revision Schedule**

60983

84073-001

01-29-20 - 100 percent

INTERIOR FINISH ELEVATIONS

SCALE: AS SHOWN SHEET NUMBER:

STORE #:

ISSUE DATE:

PROJECT #:

SW7069-ES

6.0

1502

[WD0073] MAD101-V

VESTIBULEScale: 3/8" = 1'-0"

KEYED NOTES


- 1. WALL FINISH BEHIND EXPOSED CABINETRY AND BELOW UNDERSIDE OF COUNTERTOP SUBSTRATE TO BE FRP.
- 2. PENDANT LIGHT FIXTURE (SEE REFLECTED CEILING PLAN ON SHEET I103 AND LIGHTING PLAN ON SHEET E102 FOR ADDITIONAL INFORMATION). DRAWINGS).


GENERAL NOTES


- A. FOR GRAPHICS SCHEDULE, REFER TO THE FURNITURE. FIXTURES, AND EQUIPMENT (FF & E) SCHEDULES ON SHEET I601.
- B. REFER TO MANUFACTURER'S INSTRUCTIONS INCLUDED WITH ARTWORK/GRAPHICS FOR PROPER INSTALLATION.
- C. CHANGE PAINT COLOR ONLY AT INSIDE CORNERS
- D. PAINT FINISHES SHALL BE APPLIED AS FOLLOWS, UNLESS NOTED OTHERWISE: 1) WOODS AND METAL SURFACES SHALL BE


UNLESS OTHERWISE INDICATED.

- SEMI-GLOSS OR EQUAL. 2) ACCENT AND TRIM PAINTS TO BE SEMI-GLOSS OR
- EQUAL. a. WALL AND CEILING PAINTS TO BE EGGSHELL OR EQUAL.
- 3) PAINTS IN BOH, RESTROOM(S) OR CAFE BAR SHALL BE SEMI-GLOSS OR EQUAL.
- E. PAINT SUBSTITUTIONS ARE NOT ALLOWED. USE STARBUCKS NATIONAL ACCOUNT COLOR CODE WHEN ORDERING PAINTS.
- F. FLOORS, WALLS AND CEILING FINISHES IN FOOD PREPARATION AREAS SHALL BE SMOOTH, NON-TOXIC, NON-ABSORBENT, DURABLE AND EASILY CLEANABLE. PAINT SHALL BE WASHABLE; SEMI-GLOSS OR HIGH GLOSS FINISH.
- G. ALL WOOD SURFACES (DOORS, TRIM, SHELVES, CABINETRY) SHALL BE SEALED.
- H. REFER TO CASEWORK FINISH SCHEDULE ON THE CASEWORK FINISH PLAN ON SHEET 1102 FOR CASEWORK FINISH MATERIAL INFORMATION.
- I. ALIGN TILE TRANSITIONS ON WHOLE TILES AS SHOWN.
- J. ALL FLOOR AND WALL JUNCTIONS IN STORAGE AND FOOD PREPARATION AREAS SHALL HAVE A 6" COVED

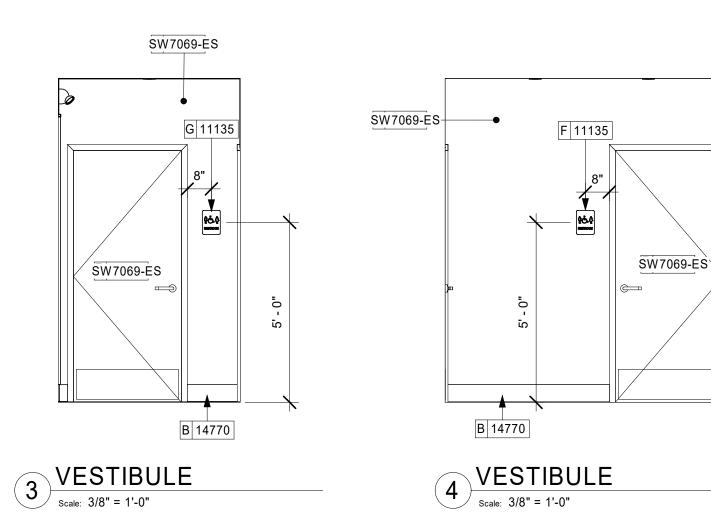

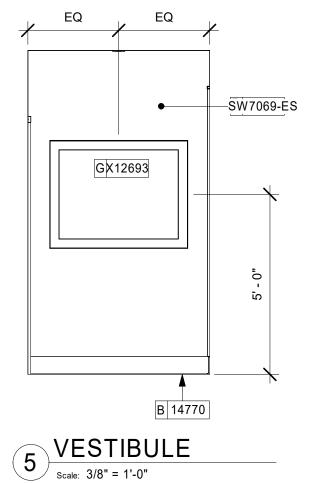

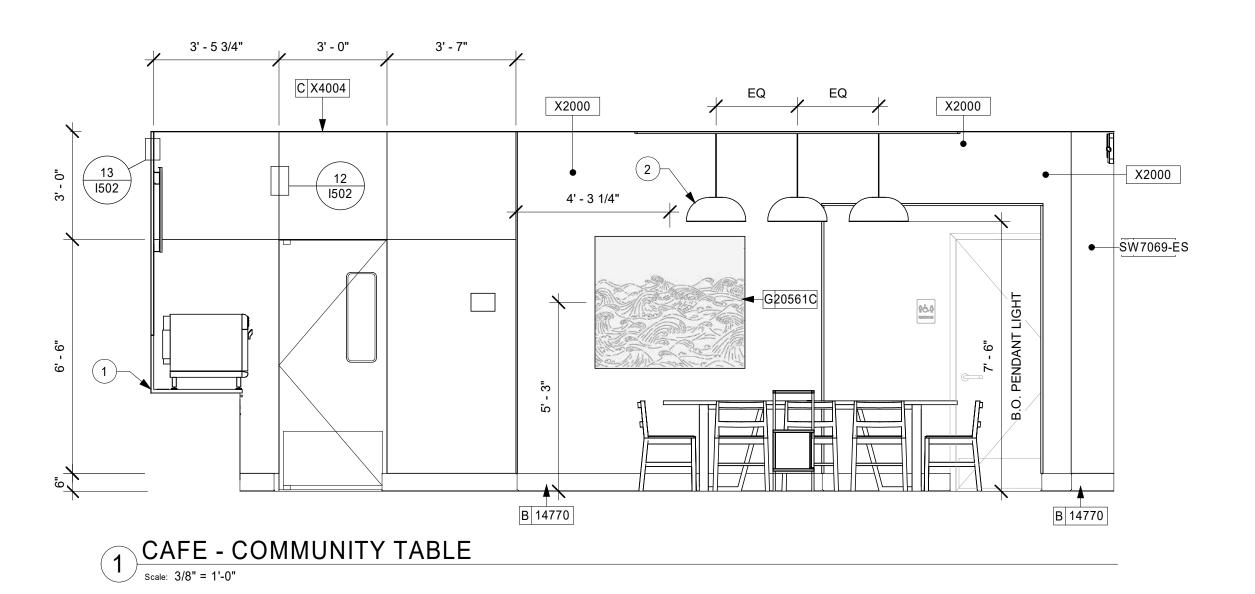

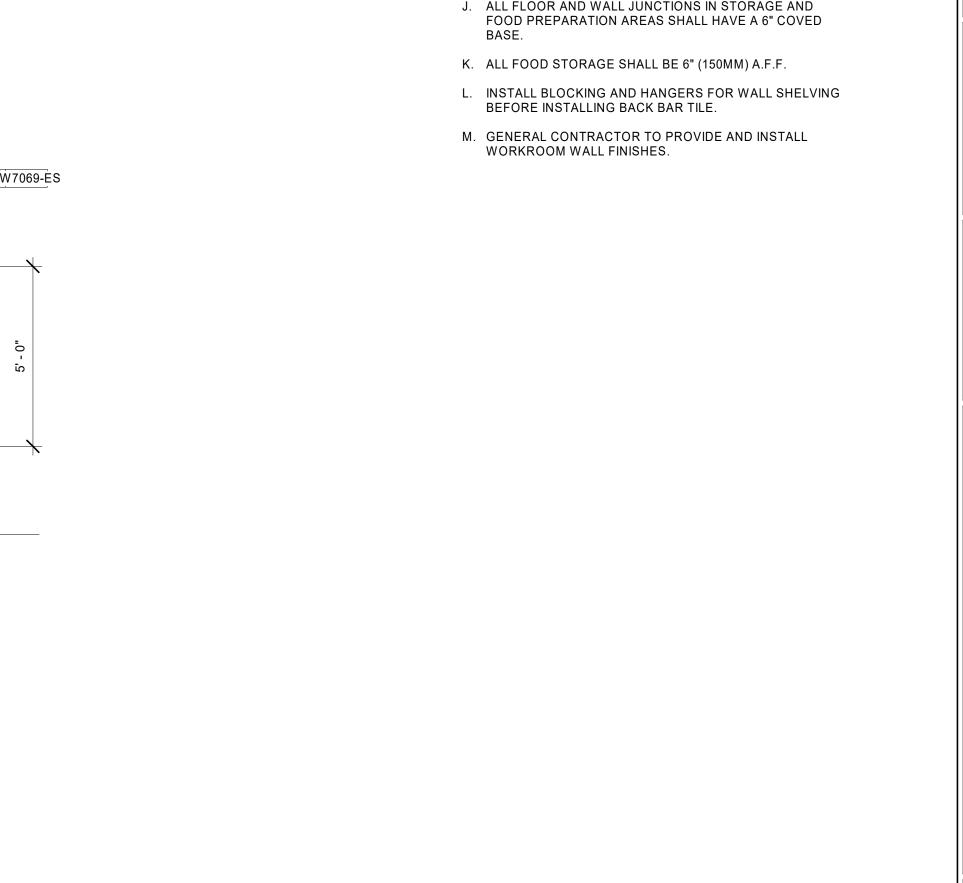



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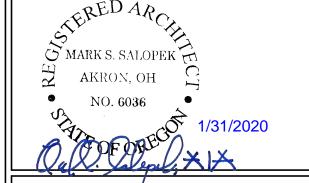
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STARBUCKS TEMPLATE VERSION: i2019-10-25



520 SOUTH MAIN ST, SUITE 2531 AKRON, OH 44311 P: 330-572-2100 F: 330-572-2101

GPD PROJECT NO: 2019355.20



PROJECT ADDRESS: 101, COOS BAY VILLAGE COOS BAY, OR 97420 PROJE HW

STORE #: 60983 PROJECT #: 84073-001 ISSUE DATE: 01-29-20 - 100 percent DESIGN MANAGER: RYAN WONG

PRODUCTION DESIGNER: GPD CHECKED BY: TC **Revision Schedule**


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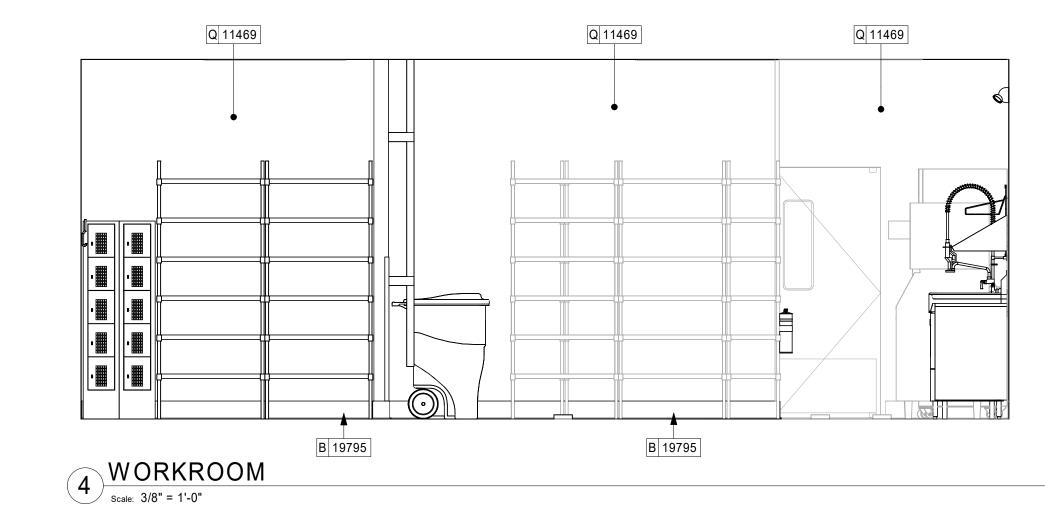
ELEVATIONS SCALE: AS SHOWN


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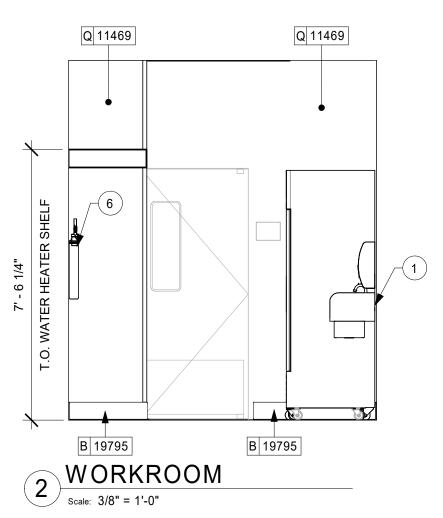
- WALL MOUNT HAND SINK WITH SOAP AND PAPER TOWEL DISPENSER. G.C. TO PROVIDE BLOCKING FOR FASTENERS.
- 2. ICE MACHINE (SEE PLUMBING AND ELECTRICAL DRAWINGS FOR ADDITIONAL INFORMATION).
- 3. MOP SINK. FULL HEIGHT FRP AT ENCLOSURE (SEE PLUMBING PLANS FOR MORE INFORMATION).
- 4. WATER HEATER ABOVE (SEE PLUMBING DRAWINGS).
- 5. MANAGER'S DESK (SEE ENLARGED DETAILS).
- 6. WATER FILTRATION EQUIPMENT (SEE PLUMBING DRAWINGS).
- 7. ELECTRICAL PANELS

- A. FOR GRAPHICS SCHEDULE, REFER TO THE FURNITURE, FIXTURES, AND EQUIPMENT (FF & E) SCHEDULES ON SHEET 1601.
- B. REFER TO MANUFACTURER'S INSTRUCTIONS INCLUDED WITH ARTWORK/GRAPHICS FOR PROPER INSTALLATION.
- C. CHANGE PAINT COLOR ONLY AT INSIDE CORNERS UNLESS OTHERWISE INDICATED.
- D. PAINT FINISHES SHALL BE APPLIED AS FOLLOWS,
 UNLESS NOTED OTHERWISE:
 1) WOODS AND METAL SURFACES SHALL BE
- WOODS AND METAL SURFACES SHALL BE SEMI-GLOSS OR EQUAL.
 ACCENT AND TRIM PAINTS TO BE SEMI-GLOSS OR
- WALL AND CEILING PAINTS TO BE EGGSHELL OR EQUAL.
- 3) PAINTS IN BOH, RESTROOM(S) OR CAFE BAR SHALL BE SEMI-GLOSS OR EQUAL.
- E. PAINT SUBSTITUTIONS ARE NOT ALLOWED. USE STARBUCKS NATIONAL ACCOUNT COLOR CODE WHEN ORDERING PAINTS.
- F. FLOORS, WALLS AND CEILING FINISHES IN FOOD PREPARATION AREAS SHALL BE SMOOTH, NON-TOXIC, NON-ABSORBENT, DURABLE AND EASILY CLEANABLE. PAINT SHALL BE WASHABLE; SEMI-GLOSS OR HIGH GLOSS FINISH.
- G. ALL WOOD SURFACES (DOORS, TRIM, SHELVES, CABINETRY) SHALL BE SEALED.
- H. REFER TO CASEWORK FINISH SCHEDULE ON THE CASEWORK FINISH PLAN ON SHEET I102 FOR CASEWORK FINISH MATERIAL INFORMATION.
- I. ALIGN TILE TRANSITIONS ON WHOLE TILES AS SHOWN.
- J. ALL FLOOR AND WALL JUNCTIONS IN STORAGE AND FOOD PREPARATION AREAS SHALL HAVE A 6" COVED BASE.
- K. ALL FOOD STORAGE SHALL BE 6" (150MM) A.F.F.
- L. INSTALL BLOCKING AND HANGERS FOR WALL SHELVING BEFORE INSTALLING BACK BAR TILE.
- M. GENERAL CONTRACTOR TO PROVIDE AND INSTALL WORKROOM WALL FINISHES.






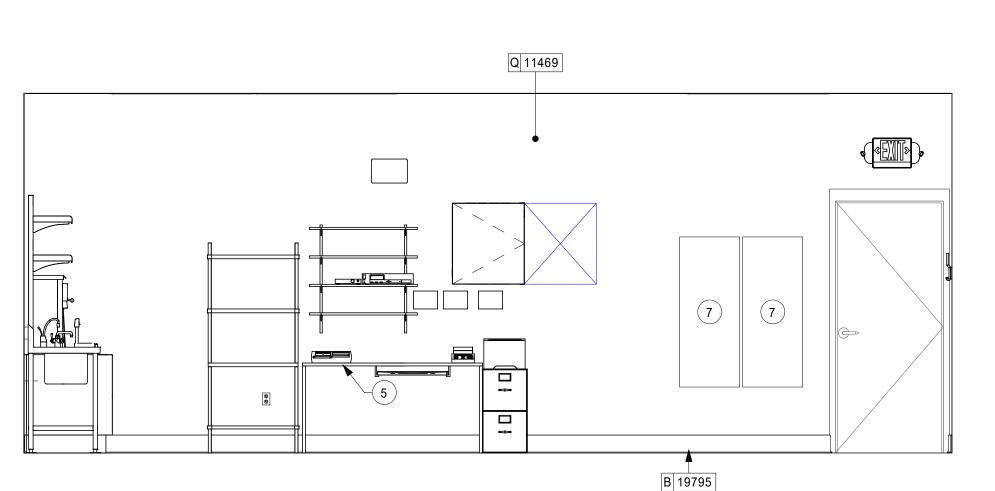

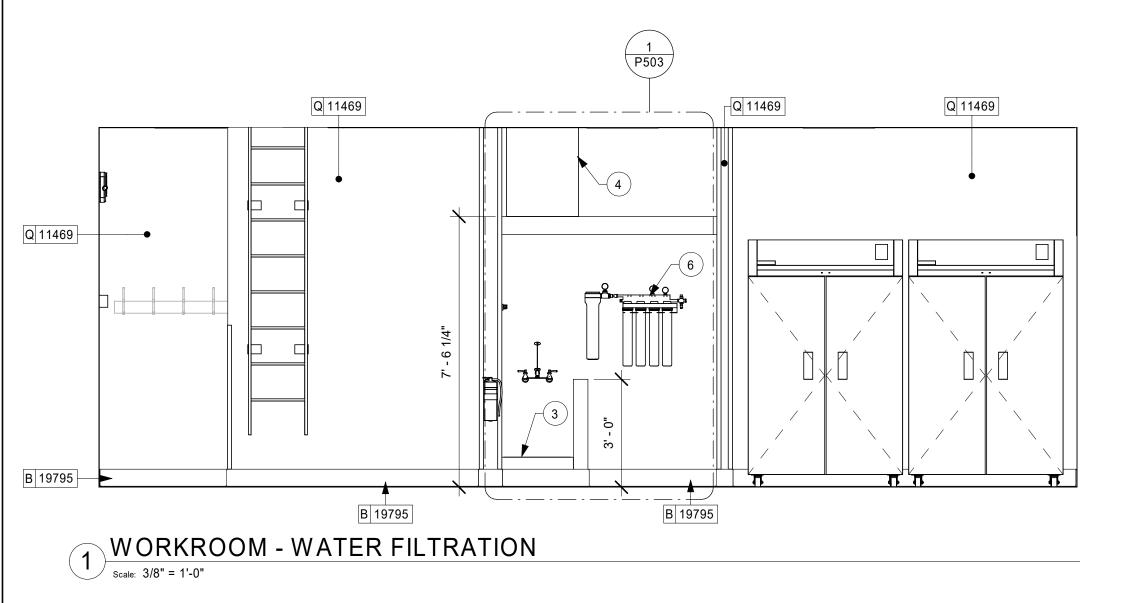

5 WORKROOM - MANAGERS STATION

Scale: 3/8" = 1'-0"

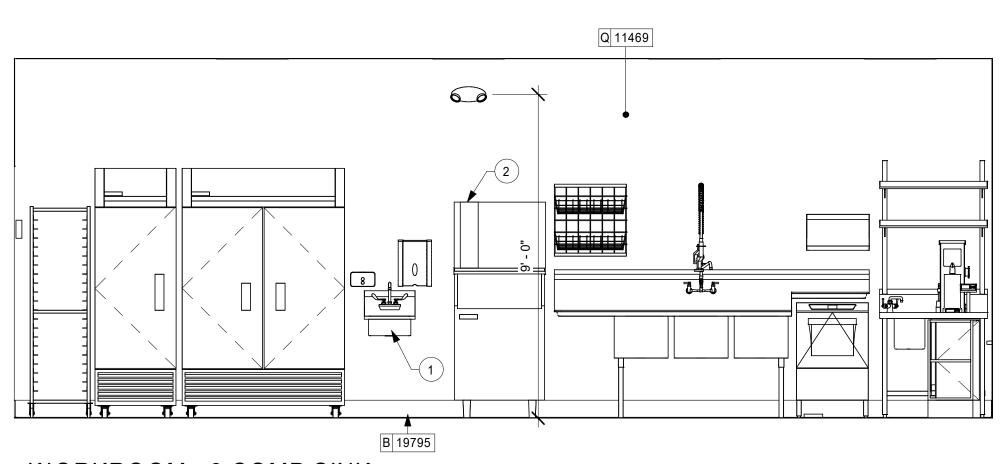

WORKROOM - 3 COMP SINK

Scale: 3/8" = 1'-0"

GENERAL NOTES



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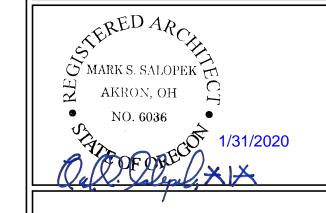
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STARBUCKS TEMPLATE VERSION: i2019-10-25



520 SOUTH MAIN ST, SUITE 2531 AKRON, OH 44311 P: 330-572-2100 F: 330-572-2101

GPD PROJECT NO: 2019355.20



HWY 101 - COOS BAY
PROJECT ADDRESS:
101, COOS BAY VILLAGE
COOS BAY, OR 97420

 STORE #:
 60983

 PROJECT #:
 84073-001

 ISSUE DATE:
 01-29-20 - 100


 DESIGN MANAGER:
 RYAN WONG


PRODUCTION DESIGNER: GPD CHECKED BY: TC

Revision Schedule					
Rev	Date	Ву	Description		

SHEET TITLE:
INTERIOR FINISH
ELEVATIONS
SCALE: AS SHOWN

SHEET NUMBER:

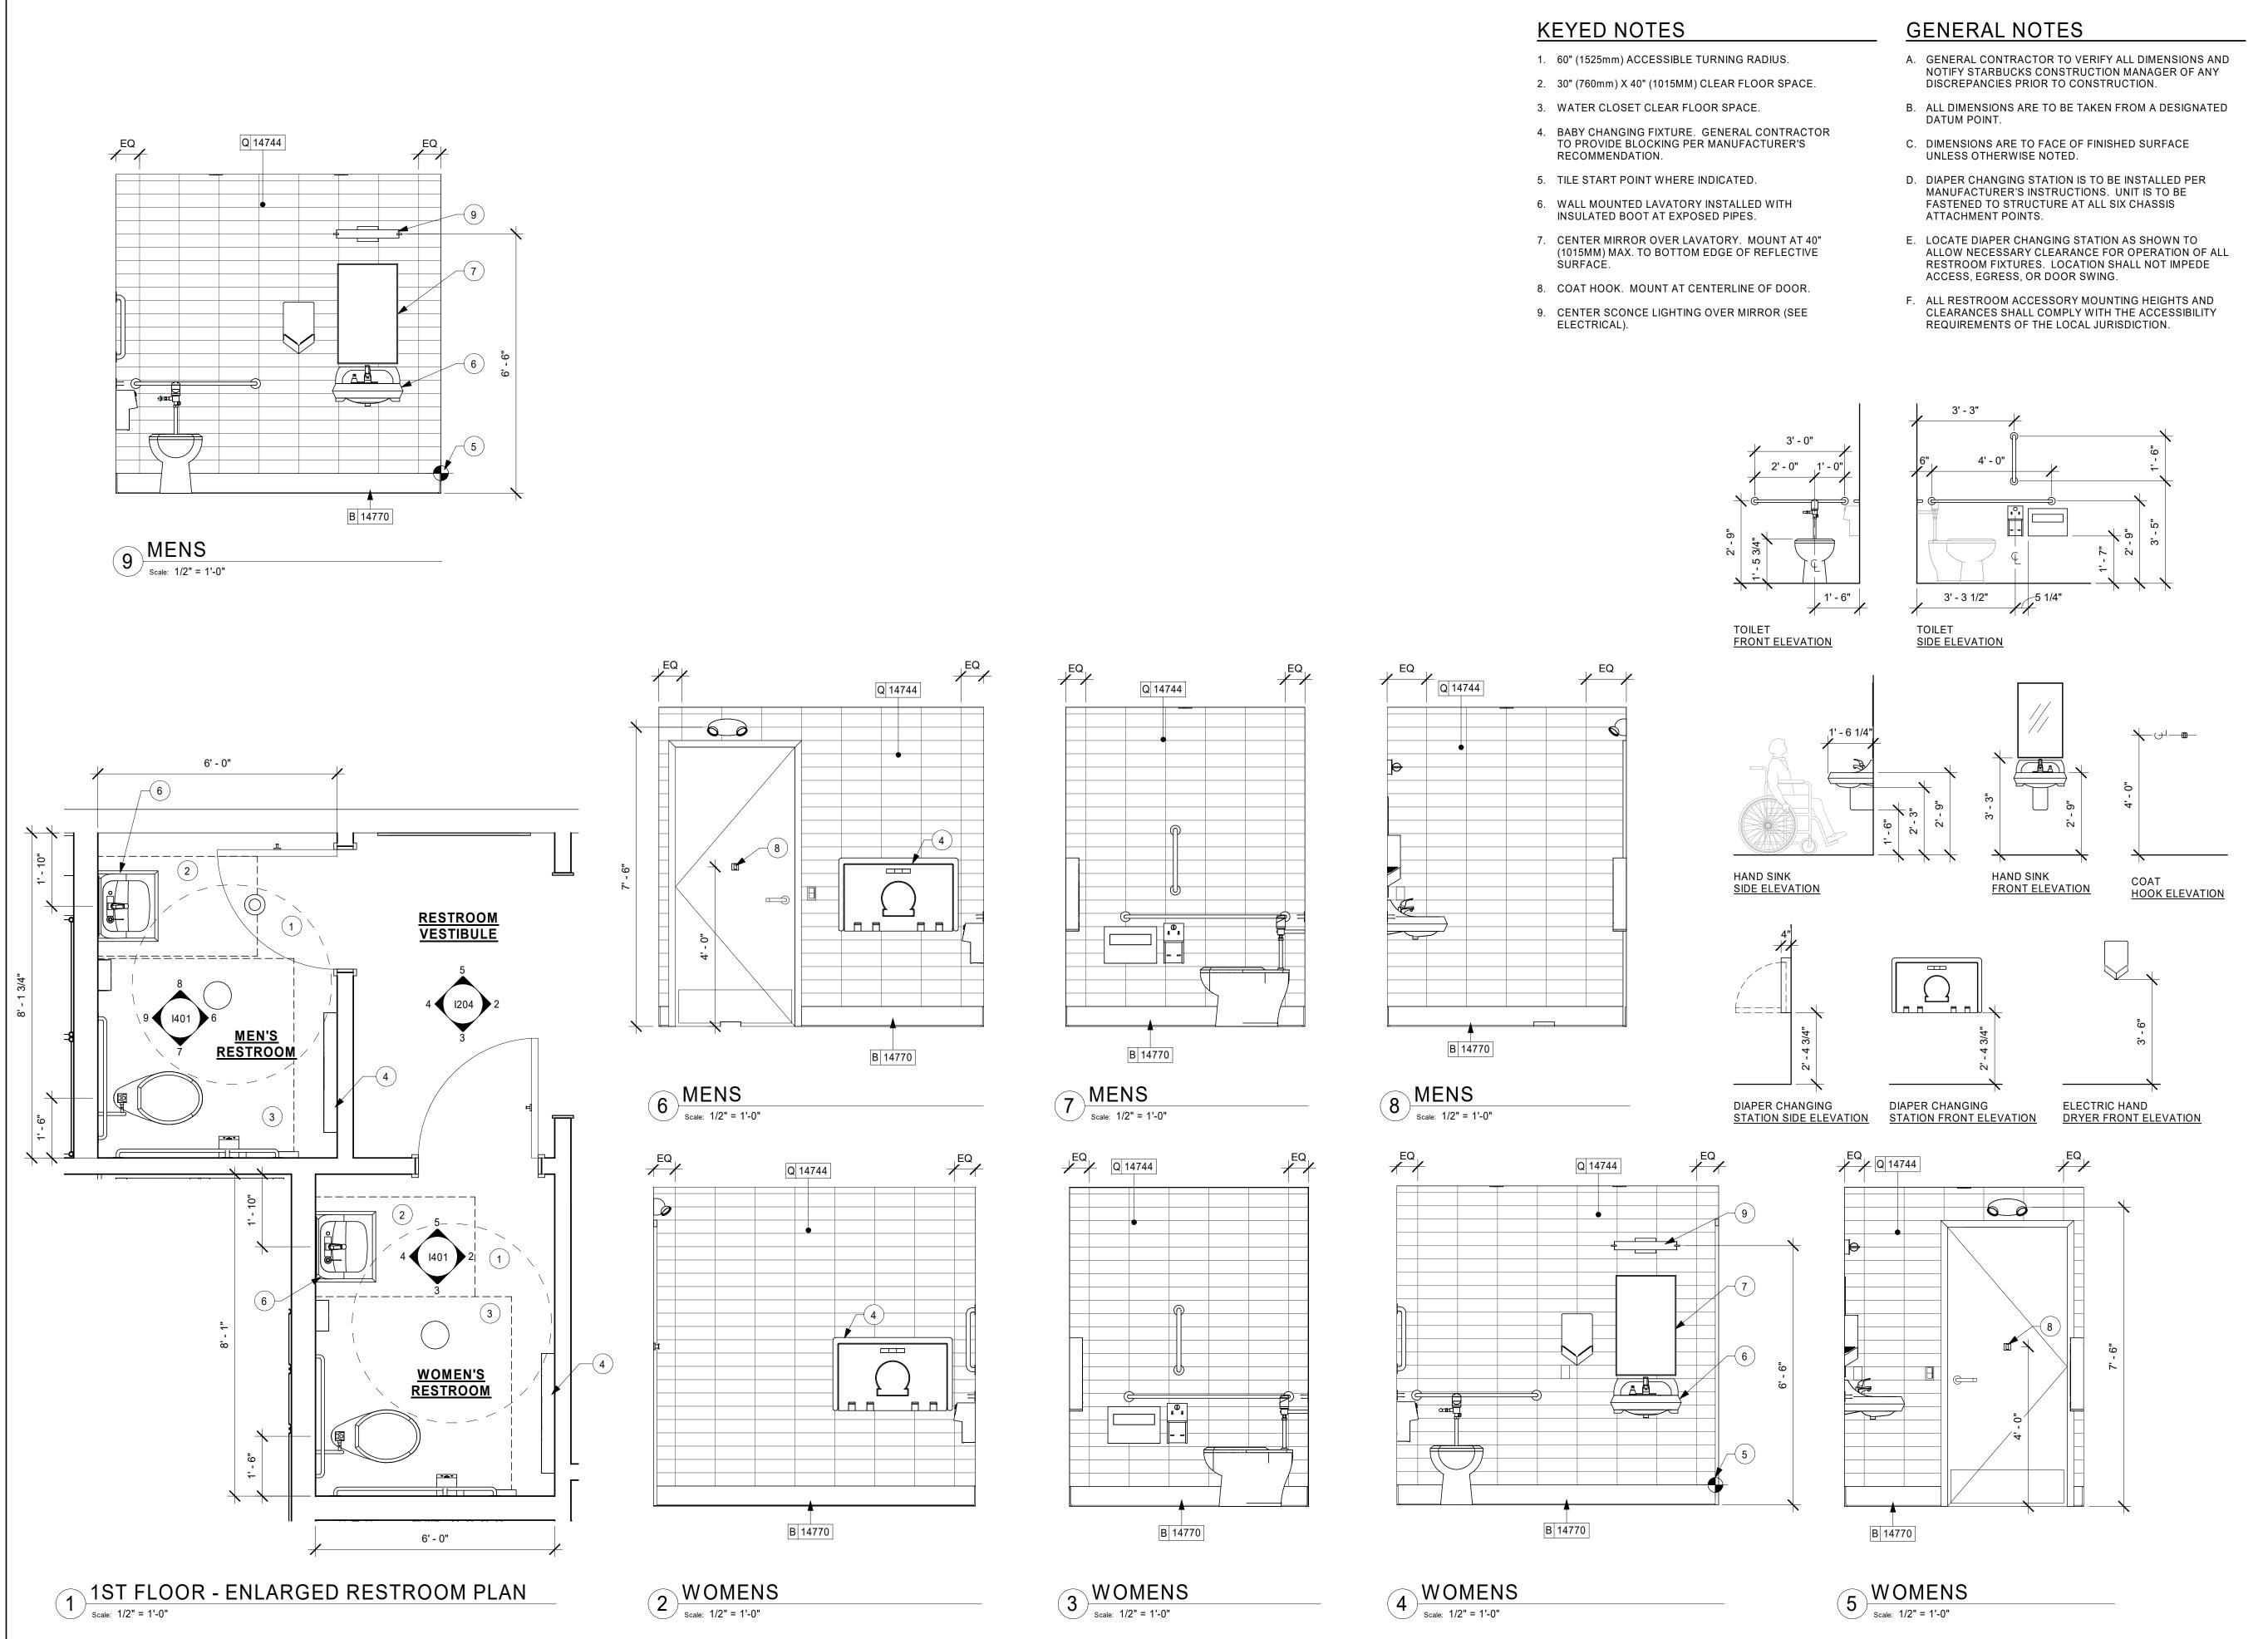

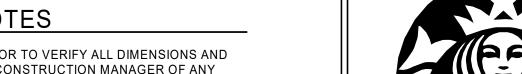



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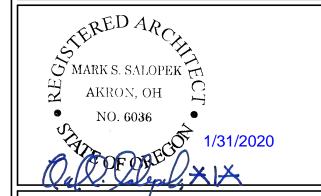
BOTH PARTIES. STARBUCKS TEMPLATE VERSION: i2019-10-25

WRITTEN AGREEMENT IS FULLY EXECUTED BY



520 SOUTH MAIN ST, SUITE 2531 AKRON, OH 44311 P: 330-572-2100 F: 330-572-2101

GPD PROJECT NO: 2019355.20



PROJECT ADDRESS: 101, COOS BAY VILLAGE COOS BAY, OR 97420

STORE #: 60983 PROJECT #: 84073-001 ISSUE DATE:

DESIGN MANAGER: RYAN WONG PRODUCTION DESIGNER: GPD CHECKED BY:

Revision Schedule

RESTROOM PLAN & ELEVATIONS SCALE: AS SHOWN

SHEET NUMBER: