BOH BACK OF HOUSE CAB CABINET

CENTER LINE

ARCH ARCHITECT

CEILING STARBUCKS CM CONSTRUCTION MANAGER CENTER

ABBREVIATIONS

CX COMMISSIONING CXA COMMISSIONING AGENT

DET DETAIL DIA DIAMETER DIMENSION STARBUCKS DESIGN MANAGER DN DOWN

EACH EΑ ELEVATION EQ EQUAL EXIST EXISTING EXT EXTERIOR

DEG DEGREE

FF&E FURNITURE. FIXTURE, AND EQUIPMENT FLR FLOOR

FOH FRONT OF HOUSE FOIC FURNISHED BY OWNER INSTALLED BY CONTRACTOR FOIO FURNISHED BY OWNER INSTALLED BY OWNER

FOOT/FEET GROUND GENERAL CONTRACTOR GWB GYPSUM WALLBOARD

HC HOLLOW CORE HDW HARDWARE HOLLOW METAL HORIZ HORIZONTAL HR HOUR

HT HEIGHT HVAC HEATING, VENTILATING AND AIR CONDITIONING

I.D. INSIDE DIAMETER

LEED LEADERSHIP IN ENERGY AND ENVIRONMENTAL DESIGN LANDLORD

LOW VOLTAGE MAX MAXIMUM

MIN MINIMUM

"MECHANICAL, ELECTRICAL AND PLUMBING' MFR MANUFACTURER

NIC NOT IN CONTRACT NIGHT LIGHT

NTS NOT TO SCALE

OC ON CENTER O.D. OUTSIDE DIAMETER

PLC PLACE RADIUS

REF REFERENCE REQ'D REQUIRED REV REVISION RND ROUND

STARBUCKS SOLID CORE SQUARE FEET SHEET SIM SIMILAR SPEC SPECIFICATION

SQ SQUARE TEMP TEMPORARY TYP TYPICAL


UC UNDER COUNTER UNO UNLESS NOTED OTHERWISE

VERT VERTICAL VIF VERIFY IN FIELD

RESPONSIBILITY LEGEND

GC GENERAL CONTRACTOR LL LANDLORD SB STARBUCKS

ARCHITECTURAL SYMBOL LEGEND

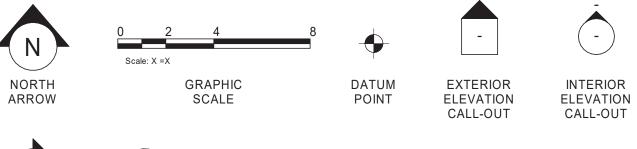

XXXX AFF (XX)DETAIL SHEET **ABOVE FINISH** FINISH FACE TO CALL-OUT CALL-OUT NOTE FLOOR FINISH FACE CALLOUT **HEIGHT TAG** DIMENSION

PXXX-ES XXXXXX DXXXXX (W|XXXXX) REVISION PAINT DESIGN ID DOOR WINDOW TAG TAG TAG TAG TAG

AERIAL MAP

VICINITY PLAN

SECTION



REVISION

CLOUD

PROPOSED INTERIOR TENANT IMPROVEMENT OF EXISTING STANDALONE SHELL BUILDING W/ DRIVE THRU.

SCOPE OF WORK TO INCLUDE PARTITIONS, FINISHES, FURNITURE. FIXTURES, EQUIPMENT, CASEWORK, LIGHTING, ETC.

SIGNAGE UNDER SEPARATE PERMIT BY OTHERS

SCOPE OF WORK

PROJECT CONTACTS

MAILING STARBUCKS COFFEE COMPANY ADDRESS: 2401 UTAH AVENUE SOUTH MS STOP: S-SD10 SEATTLE, WASHINGTON 98134 (206) 318-1575

NORIKO TANAKA DESIGN MANAGER: STARBUCKS COFFEE COMPANY 2401 UTAH AVENUE SOUTH

SEATTLE, WASHINGTON 98134 CONSTRUCTION CHERYL PARROTT MANAGER:

OF RECORD:

STARBUCKS COFFEE COMPANY 2401 UTAH AVENUE SOUTH SEATTLE, WASHINGTON 98134 (206) 573-8008

SN SUMNER, LLC LANDLORD: 14241 N.E. DUVALL ROAD, #135 DUVALL, WA 98072

ARCHITECT GPD GROUP, PROFESSIONAL CORPORATION OF RECORD: 520 S. MAIN STREET, SUITE 2531

> **AKRON, OH 44311** (330) 572-3561

MEP GPD GROUP, PROFESSIONAL CORPORATION CONSULTANT 520 S. MAIN STREET, SUITE 2531

> AKRON, OH 44311 (330) 572-3561

GPD GROUP, PROFESSIONAL CORPORATION STRUCTURAL 520 S. MAIN STREET, SUITE 2531 **CONSULTANT: AKRON, OH 44311**

(330) 572-3561

GENERAL NOTES

1. THE DRAWINGS AND PROJECT MANUAL TOGETHER CONSTITUTE THE CONTRACT DOCUMENTS FOR CONSTRUCTION. ALL GENERAL REQUIREMENTS ARE TO BE MET AND ALL MATERIALS, FINISHES AND SYSTEMS ARE TO BE INSTALLED AND PERFORM PER SPECIFICATIONS UNLESS OTHERWISE NOTED.

2. GENERAL CONTRACTOR SHALL VISIT THE SITE, REVIEW THE BUILDING SHELL DRAWINGS AS SUBMITTED BY THE LANDLORD OR STARBUCKS AND BECOME THOROUGHLY FAMILIAR WITH THE SITE CONDITIONS PRIOR TO CONSTRUCTION.

3. GENERAL CONTRACTOR SHALL CONSULT WITH STARBUCKS CONSTRUCTION MANAGER TO RESOLVE ANY CHANGES, OMISSIONS OR PLAN DISCREPANCIES PRIOR TO CONSTRUCTION.

4. ALL WORK SHALL BE PERFORMED IN STRICT COMPLIANCE WITH LOCAL, COUNTY, STATE AND FEDERAL CODES AND ORDINANCES.

5. GENERAL CONTRACTOR SHALL VERIFY THE LOCATION OF ALL UTILITIES.

6. GENERAL CONTRACTOR TO VERIFY ALL DIMENSIONS, INCLUDING CLEARANCES REQUIRED BY OTHER TRADES AND NOTIFY STARBUCKS CONSTRUCTION MANAGER OF ANY DISCREPANCIES PRIOR TO PROCEEDING WITH THE WORK. ALL DIMENSIONS ARE TO THE FACE OF THE FINISHED SURFACE UNLESS NOTED OTHERWISE. ALL DIMENSIONS TO BE TAKEN FROM DESIGNATED DATUM POINT. DO NOT SCALE DRAWINGS.

7. GENERAL CONTRACTOR SHALL PATCH AND REPAIR ALL EXISTING WALLS, FLOORS, CEILINGS, OR OTHER SURFACES IDENTIFIED TO REMAIN THAT MAY BECOME DAMAGED DURING THE COURSE OF THE

8. THE GENERAL CONTRACTOR IS RESPONSIBLE FOR OBTAINING PERMITS FOR FIRE PROTECTION, PLUMBING, MECHANICAL, AND ELECTRICAL SYSTEMS PRIOR TO INSTALLATION OF SUCH SYSTEMS.

9. GENERAL CONTRACTOR SHALL RETAIN ONE SET OF PERMIT PLANS ON-SITE TO DOCUMENT ALL CHANGES MADE DURING CONSTRUCTION. THE RECORD DRAWINGS SHALL BE ISSUED TO THE OWNER AT PROJECT CLOSE-OUT AS DESCRIBED IN THE GENERAL REQUIREMENTS OF THE PROJECT MANUAL

10. GENERAL CONTRACTOR IS RESPONSIBLE FOR COORDINATING DELIVERY OF MATERIALS FROM STARBUCKS CONTRACTED THIRD PARTY LOGISTICS DISTRIBUTION SERVICES AND VENDOR DIRECT SHIPMENTS. SEE THE PROJECT MANUAL FOR ADDITIONAL INFORMATION.

11. RESPONSIBILITY FOR SUPPLY AND DELIVERY OF MATERIALS AND EQUIPMENT IS IDENTIFIED IN THE DRAWING SCHEDULE SHEETS UNDER THE COLUMN LABELED "RESPONSIBILITY".

12. FOR THE PURPOSE OF THE DOCUMENTS, TO "INSTALL", SHALL MEAN TO PROVIDE ALL FASTENERS, MISCELLANEOUS HARDWARE, BLOCKING, ELECTRICAL CONNECTIONS, PLUMBING CONNECTIONS AND OTHER ITEMS REQUIRED FOR A COMPLETE AND OPERATIONAL INSTALLATION, UNLESS OTHERWISE NOTED.

13. ALL ITEM SUBSTITUTIONS MUST BE APPROVED BY THE STARBUCKS CONSTRUCTION MANAGER.

SITE INFORMATION

PLUMBING CODE

CODE AUTHORITIES: CITY OF SUMNER BUILDING CODE: 2015 INTERNATIONAL BUILDING CODE W/ WA STATE AMENDMENTS

W/ WA STATE AMENDMENTS MECHANICAL CODE: 2015 INTERNATIONAL MECHANICAL CODE W/WA STATE AMENDMENTS

2017 NATIONAL ELECTRIC CODE ELECTRICAL CODE: **ENERGY CODE:** 2015 WASHINGTON STATE ENERGY CODE FIRE CODE: 2015 INTERNATIONAL FIRE CODE

2015 UNIFORM PLUMBING CODE

W/ WA STATE AMENDMENTS **HEALTH CODE:** WASHINGTON RETAIL FOOD CODE

ACCESSIBILITY CODE: 2009 ICC/ANSI A117.1 ZONING: INTERCHANGE COMMERCIAL

PARCEL NUMBER: 0420127018 PERMITTED TYPE OF USE: RETAIL SALES AND SERVICES

SPRINKLED: Ν LEASABLE AREA: 2,187 S.F.

OCCUPANCY TYPE: ASSEMBLY GROUP A-2 RETAIL SALES AND SERVICES PROPOSED USE:

V-B

DEFERRED SUBMITTALS:

CONSTRUCTION TYPE:

FIRE ALARM SIGNAGE

OCCUPANCY CALCULATION: INDOOR SEATING: 458 SF / 15 = 31BEVERAGE PREP: 419 SF / 200 = 3 $558 \, \text{SF} / 30 = 19$ SALES:

WORKROOM / RR: 521 SF / 300 = 2

TOTAL INTERIOR OCCUPANT LOAD: **TOTAL INTERIOR SEATING:** 43 **TOTAL EXTERIOR SEATING:** TOTAL NET SQUARE FOOTAGE: 1,956

INDEX OF SHEETS

LEGEND: X - SHEET ISSUED R - SHEET ISSUED FOR REFERENCE AND COORDINATION ONLY SEE TITLEBLOCK FOR REVISION ISSUE DATE(S) SHEET SHEET TITLE

GENERAL G001 GENERAL INFORMATION G002 LIFE SAFETY ACCCESSIBILITY PLAN G003 HEALTH DEPARTMENT PLAN

ARCHITECTURAL A001 ARCHITECTURAL SITE PLAN A003 ARCHITECTURAL SITE DETAILS A004 ARCHITECTURAL SITE DETAILS A101 BUILDING FLOOR PLAN A102 FLOOR PENETRATION PLAN A103 BUILDING ROOF PLAN A201 BUILDING EXTERIOR ELEVATIONS A202 BUILDING EXTERIOR ELEVATIONS A601 WINDOW AND DOOR SCHEDULES & DETAILS

INTERIORS I101 FF & E PLAN I102 CASEWORK PLAN 1103 REFLECTED CEILING PLAN I103b LIGHTING PLAN I104 FINISH PLAN 1201 INTERIOR FINISH ELEVATIONS 1202 INTERIOR FINISH ELEVATIONS 1203 INTERIOR FINISH ELEVATIONS I401 RESTROOM PLAN & ELEVATIONS I501 DESIGN DETAILS 1502 DESIGN DETAILS 1503 DESIGN DETAILS 1504 DESIGN DETAILS I601 FF & E SCHEDULES I602 CASEWORK AND EQUIP. SCHEDULES

STRUCTURAL S001 STRUCTURAL GENERAL NOTES S102 SOFFIT DETAILS/ KEYPLAN

ELECTRICAL E001 ELECTRICAL NOTES E004 ELECTRICAL SITE PLAN E100 UNDERSLAB E101 POWER PLAN E102 LIGHTING PLAN E501 ELECTRICAL DETAILS E502 ELECTRICAL DETAILS E513 GENERAL ELECTRICAL - EMS - NO LIGHTING E601 ELECTRICAL PANEL SCHEDULES

MECHANICAL M001 MECHANICAL NOTES M101 MECHANICAL DESIGN PLAN M102 MECHANICAL ROOF PLAN M501 MECHANICAL DETAILS

PLUMBING

P001 PLUMBING NOTES P101 PLUMBING SUPPLY UNDERSLAB PLAN P102 PLUMBING SUPPLY PLAN P103 PLUMBING WASTE UNDERSLAB PLAN P104 PLUMBING WASTE & VENT PLAN P105 PLUMBING ISOMETRIC P501 PLUMBING DETAILS P502 PLUMBING DETAILS

(C) 2018 STARBUCKS COFFEE COMPANY

STARBUCKS 2401 UTAH AVENUE SOUTH

SEATTLE, WASHINGTON 98134 (206) 318-1575

THESE DRAWINGS AND THE PROJECT MANUAL ARE CONFIDENTIAL AND SHALL REMAIN THE SOLE PROPERTY OF STARBUCKS CORPORATION, WHICH IS THE OWNER OF THI COPYRIGHT IN THIS WORK. THEY SHALL NOT BE REPRODUCED (IN WHOLE OR IN PART), SHARED WITH THIRD PARTIES OR USED IN AN MANNER ON OTHER PROJECTS OR EXTENSIONS TO THIS PROJECT WITHOUT THE PRIOR WRITTEN CONSENT OF STARBUCKS CORPORATION. THESE DRAWINGS AND SPECIFICATIONS ARE INTENDED TO EXPRESS DESIGN INTENT FOR A PROTOTYPICAL STARBUCKS STORE (WHICH IS SUBJECT TO CHANGE AT ANYTIME) AND DO NOT REFLECT

ACTUAL SITE CONDITIONS. NEITHER PARTY

THE OTHER (EXCEPT STATED ABOVE) UNTIL A

WRITTEN AGREEMENT IS FULLY EXECUTED BY

BOTH PARTIES.


SHALL HAVE ANY OBLIGATION NOR LIABILITY T

STARBUCKS TEMPLATE VERSION i2019.05.31



520 SOUTH MAIN ST, SUITE 2531 AKRON, OH 44311 P: 330-572-2100 F: 330-572-2101

GPD PROJECT NO: 2019355.03

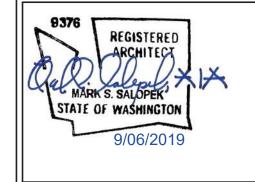

O တ . ⊙ M ВШ

STORE #: 59603 PROJECT #: 83746-001

ွှ ဟ

418 UMI

S 2 E

ISSUE DATE: SUBMITTAL 9.6.19 DESIGN MANAGER: NORIKO TANAKA PRODUCTION DESIGNER: GUY RIPLEY CHECKED BY: TOM CONNER

Revision Schedule

Rev Date Description

GENERAL INFORMATION

SCALE: AS SHOWN

SHEET NUMBER:

G001

OUTDOOR SEATING										
TYPE	DESCRIPTION	NUMBER OF ITEMS	TOTAL SEATS							
2 SEAT	TABLE TOP, ROUND	4	8							
4 SEAT	TABLE TOP, ROUND	1	4							
2 SEAT	TABLE TOP, SQUARE (ADA)	1	2							

EGRESS CALCULATION	
EXIT WIDTH REQUIRED - 55 OCC X .2	= 11 IN.
EXIT WIDTH PROVIDED (TOTAL)	= 144 IN.
EXITS	= 68 IN. PRIMARY ENTRY, 34 IN. SECONDARY ENTRY, 40 IN. WORKROOM
# EXITS REQUIRED	= 2
# EXITS PROVIDED	= 3
MAXIMUM ALLOWABLE TRAVEL DISTANCE	= 75'-0"
MAXIMUM TRAVEL DISTANCE PROVIDED	= 56'-1"
MINIMUM EXIT SEPARATION	= 37'-8" (MAXIMUM DIAGONAL 75'-3" / 2)
EXIT SEPARATION PROVIDED	= 41'-0"

TOTAL

55 OCC

URINALS

N/A

Scale: 1/4" = 1'-0"

LAVATORIES

1 PER 200 OCCUPANTS

01 LAV PER M 01 LAV PER F

01 LAV PER M 01 LAV PER F

PLUMBING FIXTURE CALCULATION

MALE

28 OCC

FEMALE

28 OCC

WATERCLOSETS

1 PER 75 OCCUPANTS

REQUIRED: 01 WC PER M 01 WC PER F

PROVIDED: 01 WC PER M 01 WC PER F

CHAPTER 29-29023 (FOR REFERNCE ONLY)

OCCUPANCY

FIXTURES

ROOM SCHEDULE

<u>NAME</u>	AREA
BACKBAR	419 SF
CAFE	1016 SF
MEN'S RR	45 SF
RR VESTIBULE	53 SF
WOMEN'S RR	45 SF
WORKROOM	378 SF
GRAND TOTAL	1956 SF

WATER FOUNTAIN

N/A

OCCUPANCY NOTES

REA	OCCUPANCY CLASSIFICATION:	A-2
9 SF	TOTAL OCCUPANTS:	55
6 SF 5 SF	OCC	CUPANCY
3 SF	INDOOR SEATING: 458 SQ. FT. / 1	5 SQ. FT. / OCC
5 SF 8 SF	SALES: 557 SQ. FT. / 30 SQ. FT. /	OCC
6 SF	BEVERAGE PREP: 419 SQ. FT. / 2	00 SQ. FT. / OC

TOTAL OCC LOAD:

ACCESSIBLE SEATING

INTERIOR SEATING: 43 SEATS X 5% = 3 ADA REQUIRED (3 PROVIDED)

WORKROOM / RR: 523 SQ. FT. / 300 SQ. FT. / OCC

EXTERIOR SEATING: 14 SEATS X 5% = 1 ADA REQUIRED (1 PROVIDED)

KEYED NOTES

31 OCC

19 OCC

3 OCC

2 OCC

55 OCC

- 1. THRESHOLDS TO BE BARRIER FREE COMPLIANT PER ALL APPLICABLE CODES.
- 2. BARRIER-FREE PATH OF TRAVEL.
- 3. 30" (160 MM) X 48" (1220 MM) CLEAR FOR WHEELCHAIR ACCESS.
- 4. 60" (1525 MM) DIAMETER MINIMUM TURN RADIUS FOR WHEELCHAIR ACCESS.
- 5. 32" (815 MM) MINIMUM CLEAR AT RESTROOM DOOR.
- 6. SEE ENLARGED RESTROOM PLAN AND ELEVATIONS SHEET(S) FOR ADDITIONAL INFORMATION ON ACCESSIBLE RESTROOM CLEARANCES.
- 7. POS TRANSACTION PLANE, CONDIMENT CART TOP AND HAND-OFF PLANE ARE 34 INCHES (860 MM) ABOVE THE FINISHED FLOOR FOR WHEELCHAIR ACCESSIBILITY.
- 8. PROVIDE BARRIER-FREE SIGNAGE AT ADA RESTROOMS PER ALL APPLICABLE CODES.
- 9. PROVIDE TACTILE "EXIT" SIGNAGE.
- 10. PROVIDE INTERNATIONAL SYMBOL OF ACCESSIBILITY SIGN.

MEANS OF EGRESS NOTES

- A. EVERY ROOM OR SPACE THAT IS ASSEMBLY OCCUPANCY SHALL HAVE THE OCCUPANT LOAD OF THE ROOM OR SPACE POSTED IN A CONSPICUOUS PLACE, NEAR THE MAIN EXIT ACCESS DOORWAY. POSTED SIGNS SHALL BE OF AN APPROVED LEGIBLE PERMANENT DESIGN AND SHALL BE MAINTAINED BY THE OWNER AUTHORIZED AGENT. (1004.3)
- B. EGRESS SHALL NOT PASS THROUGH KITCHENS, STORAGE ROOMS, CLOSETS OR SIMILAR SPACES. (1014.2)
- C. PANIC AND FIRE EXIT HARDWARE, WHERE INSTALLED ON DOORS IN THIS BUILDING SHALL SATISFY THE FOLLOWING (1008.1.10):
- a) THE ACTUATION PORTION OF THE RELEASING DEVICE SHALL EXTEND AT LEAST ONE-HALF OF THE DOOR LEAF WIDTH.
- b) THE MAXIMUM UNLATCHING FORCE DOES NOT EXCEED 15 POUNDS (6.8 KG).
- c) PIVOTED OR BALANCED DOORS SHALL BE OF THE PUSH-PAD TYPE WHERE PANIC HARDWARE IS REQUIRED AND THE PAD SHALL NOT EXTEND ACROSS MORE THAN ONE-HALF OF THE DOOR WIDTH, MEASURED FROM THE LATCH SIDE.
- d) PANIC HARDWARE LISTED IN ACCORDANCE WITH UL 305.
- e) FIRE EXIT HARDWARE LISTED IN ACCORDANCE WITH UL 10C AND UL 305.
- D. STRUCTURAL ELEMENTS, FIXTURES OR FURNISHINGS SHALL NOT PROJECT HORIZONTALLY FROM EITHER SIDE MORE THAN 4 INCHES (100 MM) OVER ANY WALKING SURFACE BETWEEN 27 INCHES (685 MM) AND 80 INCHES (2030 MM) ABOVE THE WALKING SURFACE. EXCEPTION: HANDRAILS SERVING STAIRS AND RAMPS ARE PERMITTED TO PROTRUDE 4 1/2 INCHES (115 MM) FROM THE WALL (1003.3.3)
- E. THE PATH OF EGRESS TRAVEL EXITS AND WITHIN EXITS IN THIS BUILDING SHALL BE IDENTIFIED BY EXIT SIGNS CONFORMING TO THE REQUIREMENTS OF SECTION 1011 AND AS NOTED BELOW:
- 1) EXIT SIGNS SHALL BE READILY VISIBLE FROM ANY DIRECTION OF EGRESS TRAVEL.
- 2) EXIT SIGNS SHALL BE LOCATED AS NECESSARY TO CLEARLY INDICATE THE DIRECTION OF EGRESS TRAVEL.
- 3) NO POINT IN A CORRIDOR SHALL BE MORE THAN 100 FT (30.5 M) OR THE LISTED VIEWING DISTANCE FOR THE SIGN, WHICHEVER IS LESS, FROM THE NEAREST VISIBLE EXIT SIGN.
- F. WHERE KEY OPERATED LOCKING DEVICES ARE USED, POST A SIGN ON OR ADJACENT TO THE REQUIRED MAIN EXIT DOOR WITH 1 INCH (25 MM) LETTERING STATING THAT "THIS DOOR TO REMAIN UNLOCKED WHEN BUILDING IS OCCUPIED". (1008.1.9.3)
- G. EGRESS DOORS OR GATES SHALL BE OPENABLE FROM THE EGRESS SIDE WITHOUT THE USE OF A KEY, SPECIAL KNOWLEDGE OR EFFORT. DOOR HANDLES, PULLS, LATCHES, LOCKS AND OTHER OPERATING DEVICES SHALL BE INSTALLED 34 INCHES (860 MM) TO 48 INCHES (1220 MM) ABOVE FINISHED FLOOR. MANUALLY OPERATED FLUSH BOLTS OR SURFACE BOLTS ARE NOT PERMITTED. THE UNLATCHING OF ANY DOOR OR LEAF SHALL NOT REQUIRE MORE THAN ONE OPERATION. (1008.1.9)
- H. LANDINGS SHALL BE PROVIDED ON EACH SIDE OF DOORS AND SUCH LANDING SHALL BE AT THE SAME ELEVATION ON EACH SIDE OF THE DOOR LANDINGS SHALL HAVE A WIDTH NOT LESS THAN THE WIDTH OF THE DOOR AND LENGTH MEASURED IN THE DIRECTION OF TRAVEL OF NOT LESS THAN 44 INCHES (11120 MM). (1008.1.5, 1008.1.6)



© 2018 STARBUCKS COFFEE COMPANY

STARBUCKS® 2401 UTAH AVENUE SOUTH SEATTLE, WASHINGTON 98134

(206) 318-1575 THESE DRAWINGS AND THE PROJECT MANUAL ARE CONFIDENTIAL AND SHALL REMAIN THE SOLE PROPERTY OF STARBUCKS CORPORATION, WHICH IS THE OWNER OF THE COPYRIGHT IN THIS WORK. THEY SHALL NOT BE REPRODUCED (IN WHOLE OR IN PART), SHARED WITH THIRD PARTIES OR USED IN ANY

MANNER ON OTHER PROJECTS OR

EXTENSIONS TO THIS PROJECT WITHOUT THE PRIOR WRITTEN CONSENT OF STARBUCKS CORPORATION. THESE DRAWINGS AND SPECIFICATIONS ARE INTENDED TO EXPRESS DESIGN INTENT FOR A PROTOTYPICAL STARBUCKS STORE (WHICH IS SUBJECT TO CHANGE AT ANYTIME) AND DO NOT REFLECT ACTUAL SITE CONDITIONS. NEITHER PARTY SHALL HAVE ANY OBLIGATION NOR LIABILITY TO THE OTHER (EXCEPT STATED ABOVE) UNTIL A

WRITTEN AGREEMENT IS FULLY EXECUTED BY

BOTH PARTIES.


STARBUCKS TEMPLATE VERSION i2019.05.31



Professional Corporation 520 SOUTH MAIN ST, SUITE 2531

AKRON, OH 44311 P: 330-572-2100 F: 330-572-2101

GPD PROJECT NO: 2019355.03

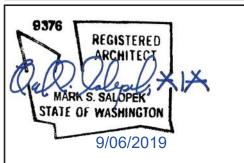


STORE #: PROJECT #: 83746-001

SUBMITTAL 9.6.19 ISSUE DATE: **DESIGN MANAGER:** NORIKO TANAKA PRODUCTION DESIGNER: GUY RIPLEY TOM CONNER CHECKED BY:

LIFE SAFETY ACCCESSIBILITY PLAN

SHEET NUMBER:

SCALE: AS SHOWN

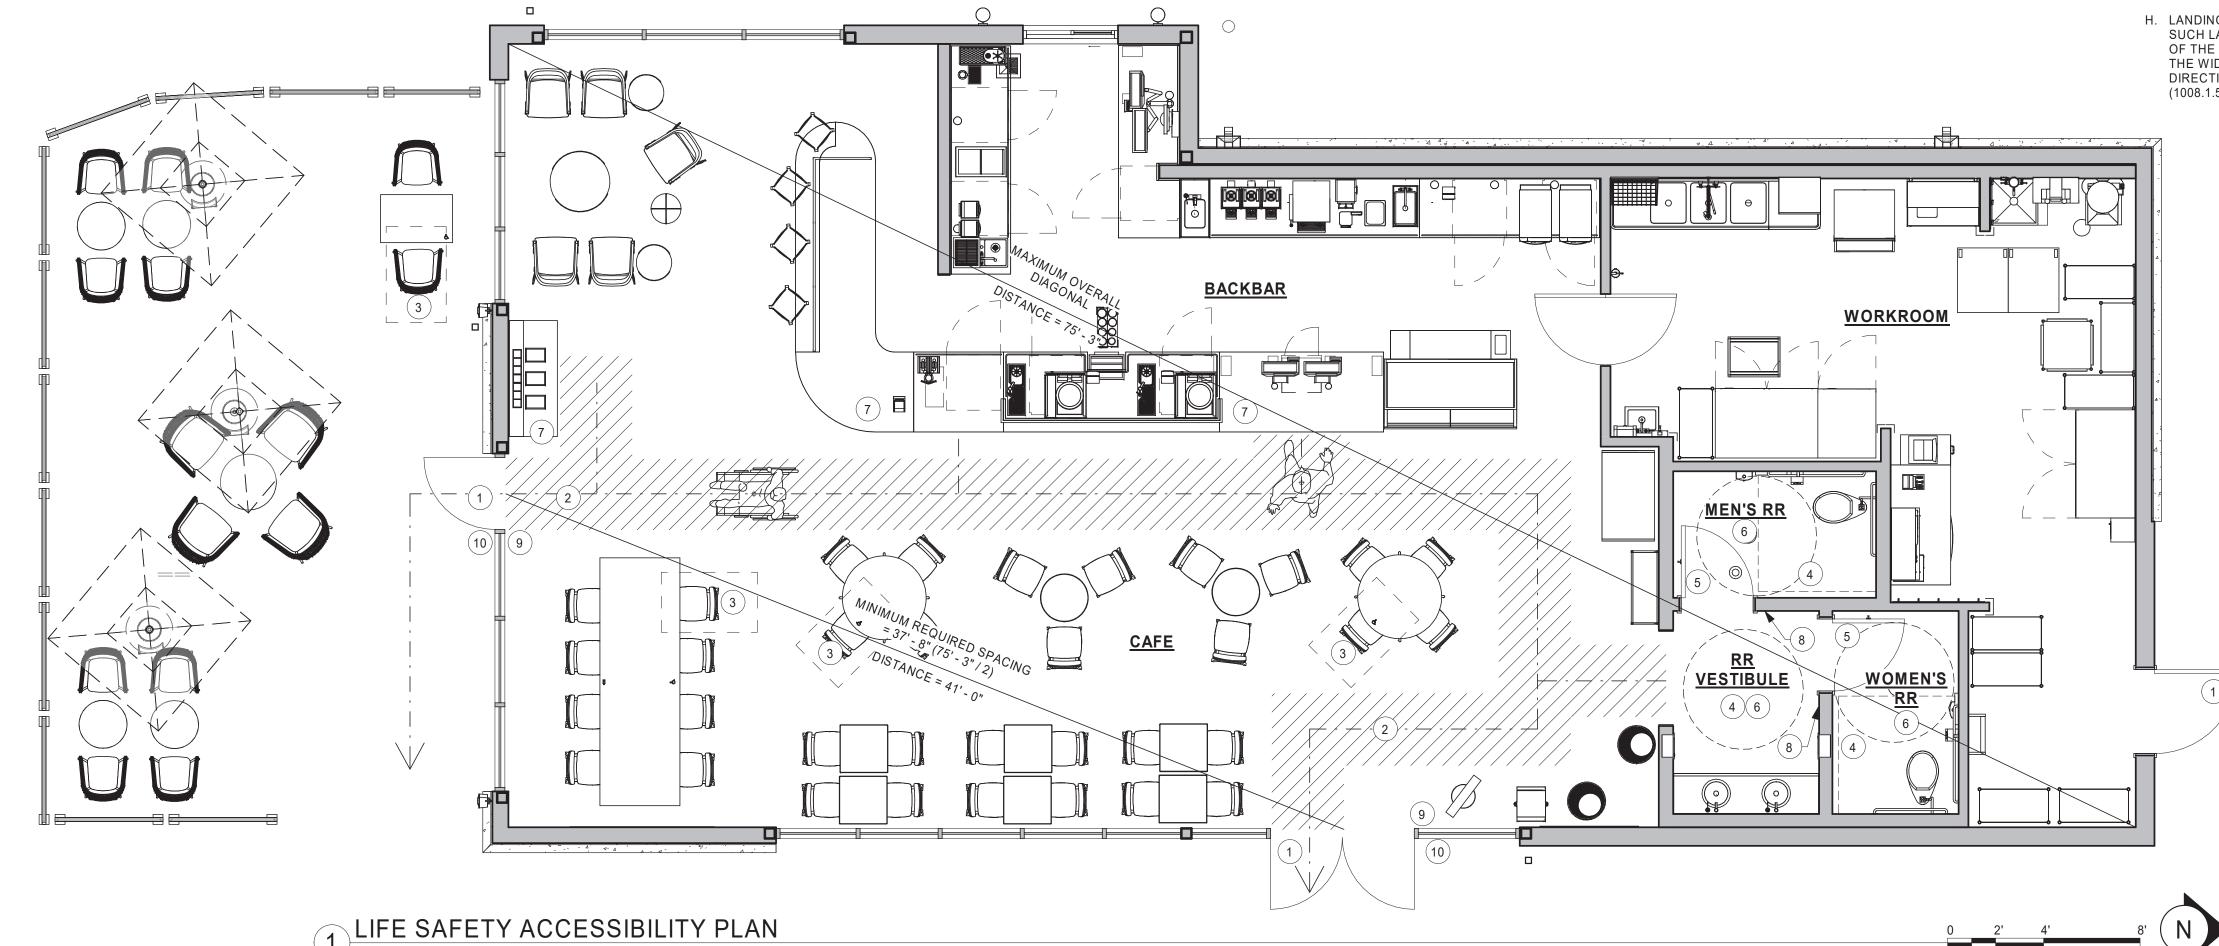

	(

DESIGN ID	COUNT	PLUMBING FIXTURE SCHEDULE - "P" DESCRIPTION	COMMENTS
DRAIN			
10294	5	DRAIN - FLOOR SINK SQUARE - 12IN 305MM	ZURN FD2372-H, A.R.E. FLOOR SINK WITH 6" SUPM DEPTH AND 1/2 GRATE
10726 GI	5 1	FLOOR SINK - GRATE HALF SQUARE - 12IN 305MM HYDROMECHANICAL GREASE INTERCEPTOR	ZURN FD2372-H, A.R.E. FLOOR SINK WITH 6" SUPM DEPTH AND 1/2 GRATE SCHIER GB3
X0101	6	FLOOR CLEANOUT	ZURN CO2449, ADJUSTABLE FLOOR CLEANOUT, NICKEL BRONZE FRAME AND COVER.
X0102	3	FLOOR DRAIN	ZURN FD2209, ADJUSTABLE FLOOR DRAIN, 3" HUB OUTLET, NICKLE BRONZE TOP.
AUCET 10152	1	FAUCET - DOUBLE LABORATORY WITH BENT RISER	
10153	1	SPOUT FAUCET - WATER TOWER - 12IN 305MM	
10215	2	FAUCET - DOUBLE LABORATORY WITH SWING SPOUT	
10447 10597	1	FAUCET - PRE RINSE SPRAYER WALL MOUNTED FAUCET - SINGLE HANDLE	
10804 10874	1	FAUCET - PRE RINSE SWING SPOUT FAUCET - HOT WATER DISPENSER GOOSENECK	
10974	1	FAUCET - MOP SINK WALL MOUNTED	
11003 11003	2	FAUCET - DIPPERWELL FAUCET - METERED	
13588	1	FAUCET - METERED FAUCET - HAND SINK WALL MOUNTED	
15749	2	FAUCET - HOT AND COLD WATER DISPENSER GOOSENECK	
17569	1	FAUCET - WARE RINSER IN COUNTER - 24X9IN	
		SPECIALTY EQUIPMENT SCHEDULE - "E	HD
DESIGN ID	COUNT	DESCRIPTION	COMMENTS
10267	5	FRIDGE UNDERCOUNTER 1 DOOR - 27IN 685MM	
10970	1	FRIDGE REACH IN 1 DOOR LH - 29IN 735MM	
11083 12618	2	FRIDGE REACH IN 2 DOOR - 51X35IN 1295X890MM FRIDGE UNDERCOUNTER 1 DOOR WITH SHELF -	
13682	1	27IN 685MM FREEZER REACH IN 2 DOOR - 54IN 1370MM	
17773	1	KEG DISPENSING SYSTEM - 27IN 685MM - WITH PLUMBED DRAIN TRAY	KIT INCLUDES UNDERCOUNTER FRIDGE, TAPS, TRAY, AND TUBING
EQUIPMENT			
10312 10746	3 1	BREWER SOFT HEAT WARMING STAND SINGLE BREWER DUAL SOFT HEAT	
10808	1	GRINDER DITTING KR1203	
10856 10907	5 1	BREWER SERVER SOFT HEAT DISHWASHER LEGS AND SKIRT	
12407	2	OVEN TURBOCHEF NEXT GENERATION	
12508 12508	1	BLENDER QUIET MODEL ON COUNTER BLENDER QUIET MODEL ON COUNTER - BACK-UP	TO BE STORED IN BACK OF HOUSE UNLESS NEEDED
12694	2	ESPRESSO MACHINE MASTRENA	
15186 16623	1	DISHWASHER HOT LOW STEAM SCALE DIGITAL WITH ADJUSTABLE DISPLAY MOUNT SMALL	
17564	1	BLENDER PITCHER RINSER WITH SENSOR	
19559 X18303	2	NITROGEN GENERATOR ELEMENT RECESSED COMBINATION TOWEL AND WASTE UNIT	BOBRICK B-3803
FOOD CASE 16238	1	FOOD CASE - ZEPHYR - 66IN 1675MM	
18702	1	FOOD CASE - FREESTANDING SELF SERVE CHILLED TALL	
CE			
10102 10344	<u>1</u> 1	ICE - BIN B55 ICE - BIN DROP IN 90LB 40KG	
18837	1	ICE - MACHINE CIM0530HA AIR COOLED	
19278 OTHER	1	ICE - BIN DROP IN 45LB 20KG HORIZONTAL	
10091	1	CUP DISPENSER TALL HOT VERTICAL	
10099 10172	2	RESTROOM TOILET PAPER HOLDER RESTROOM SEAT COVER DISPENSER	
10305	1	TRASH DROP RING LINER SQUARE - BLACK	
10396 10467	1	CUP DISPENSER SHORT HOT VERTICAL FILE CABINET 2 DRAWER	
10501	1	FIRE EXTINGUISHER	
10769 10791	2	RESTROOM GRAB BAR VERTICAL - 18IN 455MM CUP DISPENSER GRANDE VENTI COLD VERTICAL	
10829	7	CORNER GUARD - 1.25IN 30MM - PEWTER	
10855	2	CUP DISPENSER GRANDE VENTI HOT VERTICAL	
10858	1	CUP DISPENSER TALL COLD VERTICAL	
10859	2	RESTROOM GRAB BAR - 48IN 1220MM	
10859 10862	2	RESTROOM GRAB BAR - 48IN 1220MM RESTROOM GRAB BAR - 36IN 915MM SOAP DISPENSER WALL MOUNTED PAPER TOWEL DISPENSER FULL SIZE -	
10859 10862 10947	2 2 1	RESTROOM GRAB BAR - 48IN 1220MM RESTROOM GRAB BAR - 36IN 915MM SOAP DISPENSER WALL MOUNTED	
10859 10862 10947 10977 11115 13330	2 2 1 1	RESTROOM GRAB BAR - 48IN 1220MM RESTROOM GRAB BAR - 36IN 915MM SOAP DISPENSER WALL MOUNTED PAPER TOWEL DISPENSER FULL SIZE - TRANSLUCENT GRAY SOAP DISPENSER SINK MOUNTED MOBILE CUP DISPENSER CADDY	
10859 10862 10947 10977	2 2 1 1 1	RESTROOM GRAB BAR - 48IN 1220MM RESTROOM GRAB BAR - 36IN 915MM SOAP DISPENSER WALL MOUNTED PAPER TOWEL DISPENSER FULL SIZE - TRANSLUCENT GRAY SOAP DISPENSER SINK MOUNTED	
10859 10862 10947 10977 11115 13330 13584 20081 X03923	2 2 1 1 1 1 1 2 16	RESTROOM GRAB BAR - 48IN 1220MM RESTROOM GRAB BAR - 36IN 915MM SOAP DISPENSER WALL MOUNTED PAPER TOWEL DISPENSER FULL SIZE - TRANSLUCENT GRAY SOAP DISPENSER SINK MOUNTED MOBILE CUP DISPENSER CADDY CUP DISPENSER TRENTA COLD VERTICAL SHARPS CONTAINER ACOUSTIC PANELS	SOUNDSCAPES BLADES BY ARMSTRONG - WHITE
10859 10862 10947 10977 11115 13330 13584 20081 X03923	2 2 1 1 1 1 1 2	RESTROOM GRAB BAR - 48IN 1220MM RESTROOM GRAB BAR - 36IN 915MM SOAP DISPENSER WALL MOUNTED PAPER TOWEL DISPENSER FULL SIZE - TRANSLUCENT GRAY SOAP DISPENSER SINK MOUNTED MOBILE CUP DISPENSER CADDY CUP DISPENSER TRENTA COLD VERTICAL SHARPS CONTAINER ACOUSTIC PANELS ROOF ACCESS LADDER	ARMSTRONG - WHITE
10859 10862 10947 10977 11115 13330 13584 20081 X03923	2 2 1 1 1 1 1 2 16	RESTROOM GRAB BAR - 48IN 1220MM RESTROOM GRAB BAR - 36IN 915MM SOAP DISPENSER WALL MOUNTED PAPER TOWEL DISPENSER FULL SIZE - TRANSLUCENT GRAY SOAP DISPENSER SINK MOUNTED MOBILE CUP DISPENSER CADDY CUP DISPENSER TRENTA COLD VERTICAL SHARPS CONTAINER ACOUSTIC PANELS	ARMSTRONG - WHITE MT0011 FINISH - FULL PERIMETER OF OPENING. GC TO VERIFY DIMENSION MT0011 FINISH - FULL HEIGHT OF
10859 10862 10947 10977 11115 13330 13584 20081 X03923 X07403 X10001	2 2 1 1 1 1 2 16	RESTROOM GRAB BAR - 48IN 1220MM RESTROOM GRAB BAR - 36IN 915MM SOAP DISPENSER WALL MOUNTED PAPER TOWEL DISPENSER FULL SIZE - TRANSLUCENT GRAY SOAP DISPENSER SINK MOUNTED MOBILE CUP DISPENSER CADDY CUP DISPENSER TRENTA COLD VERTICAL SHARPS CONTAINER ACOUSTIC PANELS ROOF ACCESS LADDER METAL WALL TRIM	ARMSTRONG - WHITE MT0011 FINISH - FULL PERIMETER OF OPENING. GC TO VERIFY DIMENSION
10859 10862 10947 10977 11115 13330 13584 20081 X03923 X07403 X10001 X10002	2 2 1 1 1 1 2 16 1 1	RESTROOM GRAB BAR - 48IN 1220MM RESTROOM GRAB BAR - 36IN 915MM SOAP DISPENSER WALL MOUNTED PAPER TOWEL DISPENSER FULL SIZE - TRANSLUCENT GRAY SOAP DISPENSER SINK MOUNTED MOBILE CUP DISPENSER CADDY CUP DISPENSER TRENTA COLD VERTICAL SHARPS CONTAINER ACOUSTIC PANELS ROOF ACCESS LADDER METAL WALL TRIM METAL WALL END CAP SOAP DISPENSER SINK MOUNTED	ARMSTRONG - WHITE MT0011 FINISH - FULL PERIMETER OF OPENING. GC TO VERIFY DIMENSION MT0011 FINISH - FULL HEIGHT OF WALL END. GC TO VERIFY DIMENSIONS ZURN Z6953-SD DECK MOUNTED BATTERY OPERATED SOAP
10859 10862 10947 10977 11115 13330 13584 20081 X03923 X07403 X10001 X10002 X11115	2 2 1 1 1 1 2 16 1 1	RESTROOM GRAB BAR - 48IN 1220MM RESTROOM GRAB BAR - 36IN 915MM SOAP DISPENSER WALL MOUNTED PAPER TOWEL DISPENSER FULL SIZE - TRANSLUCENT GRAY SOAP DISPENSER SINK MOUNTED MOBILE CUP DISPENSER CADDY CUP DISPENSER TRENTA COLD VERTICAL SHARPS CONTAINER ACOUSTIC PANELS ROOF ACCESS LADDER METAL WALL TRIM METAL WALL END CAP WIRE SHELF GRID AT SINK	ARMSTRONG - WHITE MT0011 FINISH - FULL PERIMETER OF OPENING. GC TO VERIFY DIMENSION MT0011 FINISH - FULL HEIGHT OF WALL END. GC TO VERIFY DIMENSIONS ZURN Z6953-SD DECK MOUNTED BATTERY OPERATED SOAP
10859 10862 10947 10977 11115 13330 13584 20081 X03923 X07403 X10001 X10002 X11115 STORAGE 10222 10416 10462	2 2 1 1 1 1 1 2 16 1 1 1 2	RESTROOM GRAB BAR - 48IN 1220MM RESTROOM GRAB BAR - 36IN 915MM SOAP DISPENSER WALL MOUNTED PAPER TOWEL DISPENSER FULL SIZE - TRANSLUCENT GRAY SOAP DISPENSER SINK MOUNTED MOBILE CUP DISPENSER CADDY CUP DISPENSER TRENTA COLD VERTICAL SHARPS CONTAINER ACOUSTIC PANELS ROOF ACCESS LADDER METAL WALL TRIM METAL WALL END CAP SOAP DISPENSER SINK MOUNTED WIRE SHELF GRID AT SINK WORKROOM SHELVING - 36IN 915MM WORKROOM SHELVING POSTS	ARMSTRONG - WHITE MT0011 FINISH - FULL PERIMETER OF OPENING. GC TO VERIFY DIMENSION MT0011 FINISH - FULL HEIGHT OF WALL END. GC TO VERIFY DIMENSIONS ZURN Z6953-SD DECK MOUNTED BATTERY OPERATED SOAP
10859 10862 10947 10977 11115 13330 13584 20081 X03923 X07403 X10001 X10002 X11115	2 2 1 1 1 1 2 16 1 1 2	RESTROOM GRAB BAR - 48IN 1220MM RESTROOM GRAB BAR - 36IN 915MM SOAP DISPENSER WALL MOUNTED PAPER TOWEL DISPENSER FULL SIZE - TRANSLUCENT GRAY SOAP DISPENSER SINK MOUNTED MOBILE CUP DISPENSER CADDY CUP DISPENSER TRENTA COLD VERTICAL SHARPS CONTAINER ACOUSTIC PANELS ROOF ACCESS LADDER METAL WALL TRIM METAL WALL END CAP SOAP DISPENSER SINK MOUNTED WIRE SHELF GRID AT SINK WORKROOM SHELVING - 36IN 915MM	ARMSTRONG - WHITE MT0011 FINISH - FULL PERIMETER OF OPENING. GC TO VERIFY DIMENSION MT0011 FINISH - FULL HEIGHT OF WALL END. GC TO VERIFY DIMENSIONS ZURN Z6953-SD DECK MOUNTED BATTERY OPERATED SOAP
10859 10862 10947 10977 11115 13330 13584 20081 X03923 X07403 X10001 X10002 X11115 STORAGE 10222 10416 10462 10698 13578 13834	2 2 1 1 1 1 2 16 1 1 1 2	RESTROOM GRAB BAR - 48IN 1220MM RESTROOM GRAB BAR - 36IN 915MM SOAP DISPENSER WALL MOUNTED PAPER TOWEL DISPENSER FULL SIZE - TRANSLUCENT GRAY SOAP DISPENSER SINK MOUNTED MOBILE CUP DISPENSER CADDY CUP DISPENSER TRENTA COLD VERTICAL SHARPS CONTAINER ACOUSTIC PANELS ROOF ACCESS LADDER METAL WALL TRIM METAL WALL END CAP SOAP DISPENSER SINK MOUNTED WIRE SHELF GRID AT SINK WORKROOM SHELVING - 36IN 915MM WORKROOM SHELVING POSTS MOP RACK WITH 3 HOLDERS DISHWARE DRYING RACK - 21IN 535MM BASE - 24X18IN 610X455MM	ARMSTRONG - WHITE MT0011 FINISH - FULL PERIMETER OF OPENING. GC TO VERIFY DIMENSION MT0011 FINISH - FULL HEIGHT OF WALL END. GC TO VERIFY DIMENSIONS ZURN Z6953-SD DECK MOUNTED BATTERY OPERATED SOAP
10859 10862 10947 10977 11115 13330 13584 20081 X03923 X07403 X10001 X10002 X11115 STORAGE 10222 10416 10462 10698 13578	2 2 1 1 1 1 2 16 1 1 2 1 1 2	RESTROOM GRAB BAR - 48IN 1220MM RESTROOM GRAB BAR - 36IN 915MM SOAP DISPENSER WALL MOUNTED PAPER TOWEL DISPENSER FULL SIZE - TRANSLUCENT GRAY SOAP DISPENSER SINK MOUNTED MOBILE CUP DISPENSER CADDY CUP DISPENSER TRENTA COLD VERTICAL SHARPS CONTAINER ACOUSTIC PANELS ROOF ACCESS LADDER METAL WALL TRIM METAL WALL END CAP SOAP DISPENSER SINK MOUNTED WIRE SHELF GRID AT SINK WORKROOM SHELVING - 36IN 915MM WORKROOM SHELVING POSTS MOP RACK WITH 3 HOLDERS DISHWARE DRYING RACK - 21IN 535MM	ARMSTRONG - WHITE MT0011 FINISH - FULL PERIMETER OF OPENING. GC TO VERIFY DIMENSION MT0011 FINISH - FULL HEIGHT OF WALL END. GC TO VERIFY DIMENSIONS ZURN Z6953-SD DECK MOUNTED BATTERY OPERATED SOAP
10859 10862 10947 10977 11115 13330 13584 20081 X03923 X07403 X10001 X10002 X11115 STORAGE 10222 10416 10462 10698 13578 13834	2 2 1 1 1 1 2 16 1 1 1 2	RESTROOM GRAB BAR - 48IN 1220MM RESTROOM GRAB BAR - 36IN 915MM SOAP DISPENSER WALL MOUNTED PAPER TOWEL DISPENSER FULL SIZE - TRANSLUCENT GRAY SOAP DISPENSER SINK MOUNTED MOBILE CUP DISPENSER CADDY CUP DISPENSER TRENTA COLD VERTICAL SHARPS CONTAINER ACOUSTIC PANELS ROOF ACCESS LADDER METAL WALL TRIM METAL WALL END CAP SOAP DISPENSER SINK MOUNTED WIRE SHELF GRID AT SINK WORKROOM SHELVING - 36IN 915MM WORKROOM SHELVING POSTS MOP RACK WITH 3 HOLDERS DISHWARE DRYING RACK - 21IN 535MM BASE - 24X18IN 610X455MM PASTRY TRAY CART - 60IN 1525MM	ARMSTRONG - WHITE MT0011 FINISH - FULL PERIMETER OF OPENING. GC TO VERIFY DIMENSION MT0011 FINISH - FULL HEIGHT OF WALL END. GC TO VERIFY DIMENSIONS ZURN Z6953-SD DECK MOUNTED BATTERY OPERATED SOAP

DESIGN ID	COUNT	DESCRIPTION	COMMENTS
17572	1	FAUCET - TAP SINGLE HANDLE	
FILTER			
12501	1	FILTER - RO SYSTEM 600GPD	
12507	1	FILTER - RO SYSTEM 40GAL STORAGE TANK	
12896	1	FILTER - BRINE TANK	
12899	2	FILTER - POLY GLASS VESSEL	
13076	1	FILTER - PREFILTRATION SYSTEM	
13082	1	FILTER - WATER SOFTENER TWIN	
13149	1	FILTER - PRESSURE GAUGE	
OTHER			1
13384	1	WATER HEATER TANK GAS	AO SMITH BTH 120, 60 GALLON, 120,000 BTU/H INPUT. PROVIDE WITH CONCENTRIC VENT KIT AND CONDENSATE NEUTRALIZER.
X0103	1	RECIRCULATING PUMP	BELL AND GOSSET MODEL NBF-18S, 120V, 100 WATT, WITH AQUASTAT
SINK			
10549	1	SINK - RINSE DROP IN SST - 12X20IN 305X510MM	
10995	1	SINK - MOP - 24X24IN 610X610MM	
13700	1	SINK - 3 COMP WORK SST - 105IN 2665MM	
14688	1	SINK - HAND WITH SIDE SPLASH WALL MOUNTED SST	
17565	1	SINK - RINSE WITH DRAINBOARD - 15X27IN 380X685MM	
17632	1	SINK - STACKED DRAINBOARD - 15IN 380MM	
17650	1	SINK - DRAIN TRAY - 9X6IN 230X150MM	
18743	1	SINK - WATER FILLING STATION - 36X24IN 915X610MM	
19277	2	SINK - COUNTERTOP RINSER WITH DRAIN TROUGH - 26X9IN 660X235MM	
X10237	2	SINK - RR VESTIBULE ROUND SST - 12IN 305MM	ELKAY ASANA - MODEL ELUH12
TOILET		•	•
12951	2	TOILET - TANKLESS EFFICIENT SINGLE FLUSH	
13040	2	TOILET - FLUSH VALVE AUTOMATIC EFFICIENT SINGLE FLUSH	

SHEET NOTES

- 1. REFER TO PENETRATION PLAN FOR FLOOR SINK LOCATIONS.
- 2. ADA COMPLIANT RESTROOM AND ACCESSORIES
- 3. 3-COMP SINK.
- 4. HAND SINK.
- WORK SINK.
- MOP SINK.
- 7. WATER HEATER ON SHELF ABOVE.

HEALTH DEPT. FINISH SCHEDULE

FLOOR: ECO-GRIP FLOORING WALL: WALL TILE, BACKSPLASH, WITH 6" ECO-GRIP BASE CEILING: GYPSUM CEILING

CAFE:

FLOOR: SEALED CONCRETE WITH WALK OFF MATS WALL: STOREFRONT, PAINTED GYPSUM WALL BOARD WITH 6" COVE TILE BASE

CEILING: GYPSUM CEILING & EXPOSED STRUCTURE

FLOOR: ECO-GRIP FLOORING WALL: FRP AND WITH 6" ECO-GRIP BASE CEILING: ACOUSTICAL TILE CEILING

RESTROOMS:

WORKROOM:

FLOOR: SEALED CONCRETE WALL: WALL TILE CEILING: GYPSUM CEILING

HEALTH DEPT. PLAN NOTES

A. GENERAL CONTRACTOR TO SCHEDULE WITH LOCAL REFRIGERATION CONTRACTOR TO CONDUCT INITIAL FOOD CASE START-UP AND TESTING. FOR APPROVED CONTRACTOR, CONTACT

B. THE SPACE IS SERVED BY THE MUNICIPAL WATER AND SEWER SYSTEM UNLESS OTHERWISE NOTED.

C. ALL EQUIPMENT AND INSTALLATION WILL MEET NATIONAL SANITATION FOUNDATION STANDARDS OR EQUIVALENT.

D. EQUIPMENT UNITS SHALL CONTAIN NO EXPOSED THREADS, EMBELLISHMENTS OR OVERHANGING EDGES THAT SERVE AS PLACES FOR ACCUMULATION OF DUST, DIRT AND DEBRIS.

E. WARMING OVEN(S) SHOWN FOR PERMITTING PURPOSES. INSTALLATION AT STORE OPENING TO BE VERIFIED BY STARBUCKS CONSTRUCTION REPRESENTATIVE.

F. EACH HAND WASHING SINK WILL HAVE A SINGLE SERVICE TOWEL AND SOAP DISPENSER, AND ALL HAND SINKS TO HAVE A COMBINATION FAUCET OR PREMIXING FAUCET.

G. SEE SHEETS I-601 & I-602 FOR SCHEDULES.



2401 UTAH AVENUE SOUTH SEATTLE, WASHINGTON 98134 (206) 318-1575

THESE DRAWINGS AND THE PROJECT MANUAL ARE CONFIDENTIAL AND SHALL REMAIN THE SOLE PROPERTY OF STARBUCKS CORPORATION, WHICH IS THE OWNER OF THE COPYRIGHT IN THIS WORK. THEY SHALL NOT BE REPRODUCED (IN WHOLE OR IN PART),

SHARED WITH THIRD PARTIES OR USED IN ANY MANNER ON OTHER PROJECTS OR EXTENSIONS TO THIS PROJECT WITHOUT THE PRIOR WRITTEN CONSENT OF STARBUCKS CORPORATION. THESE DRAWINGS AND SPECIFICATIONS ARE INTENDED TO EXPRESS DESIGN INTENT FOR A PROTOTYPICAL STARBUCKS STORE (WHICH IS SUBJECT TO CHANGE AT ANYTIME) AND DO NOT REFLECT ACTUAL SITE CONDITIONS. NEITHER PARTY SHALL HAVE ANY OBLIGATION NOR LIABILITY TO

BOTH PARTIES. STARBUCKS TEMPLATE VERSION i2019.05.31

THE OTHER (EXCEPT STATED ABOVE) UNTIL A


WRITTEN AGREEMENT IS FULLY EXECUTED BY



Professional Corporation

520 SOUTH MAIN ST, SUITE 2531 AKRON, OH 44311 P: 330-572-2100 F: 330-572-2101

GPD PROJECT NO: 2019355.03

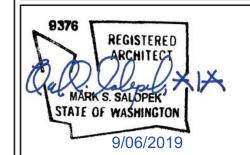

PROJECT ADDRESS:
2418 136TH COURT E
SUMNER, WA 98390


STORE #: PROJECT #: 83746-001

DESIGN MANAGER: NORIKO TANAKA PRODUCTION DESIGNER: GUY RIPLEY CHECKED BY: TOM CONNER

HEALTH DEPARTMENT PLAN SCALE: AS SHOWN

SHEET NUMBER:

G003

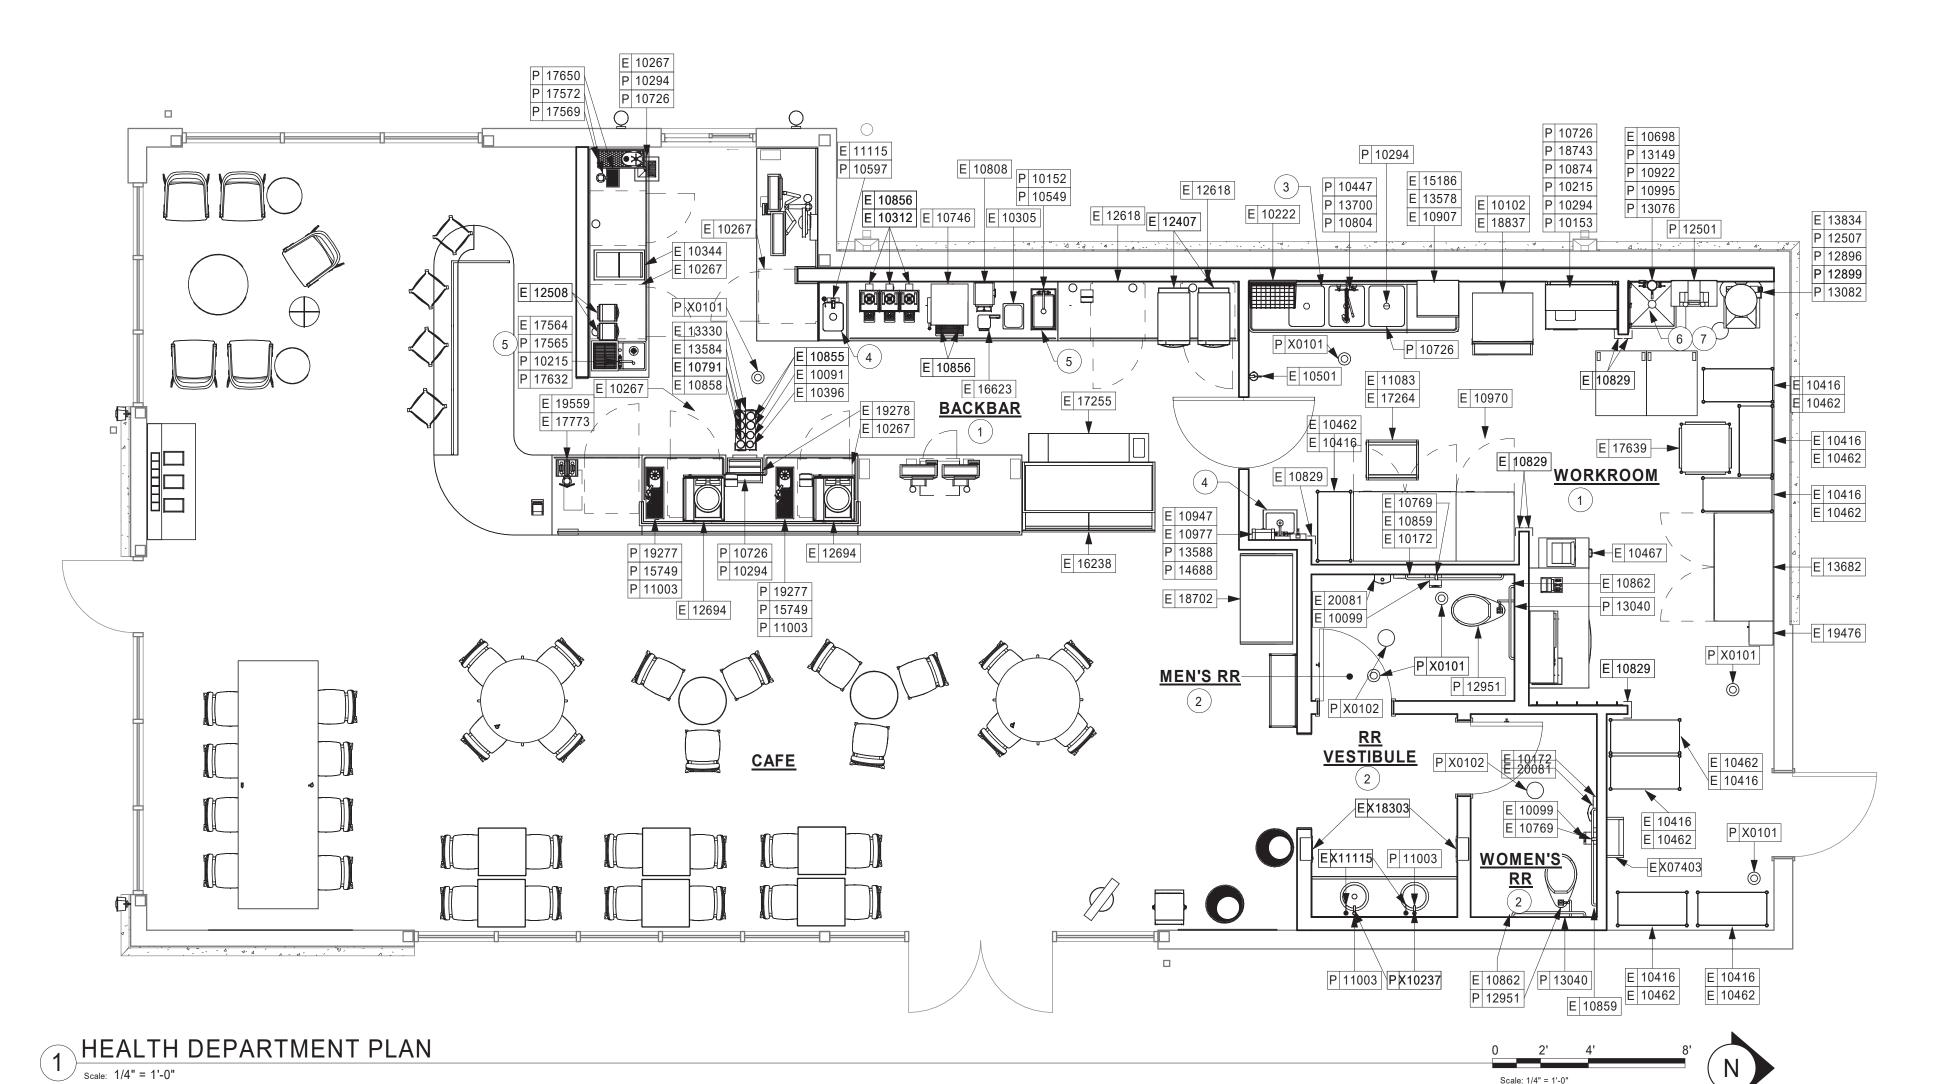

1 ARCHITECTURAL SITE PLAN

1. LANDSCAPED AREA BY LL.

.-+---

- 2. ACCESSIBLE PATH OF TRAVEL TO PUBLIC WAY BY LL.
- 3. SHARED MONUMENT SIGN BY OTHERS. FOOTINGS BY
- 4. CONCRETE PATIO AREA AND RAILINGS BY LL.
- 5. NEW BIKE RACKS BY LL, SEE 7/A004.
- 6. VEHICLE DETECTOR LOOP BY LL.
- 7. SITE DIRECTIONAL SIGN. SEE 1/A003. FOOTINGS BY LL.
- 8. LL TO APPLY ALL WAYFINDING AND PAINTED DIRECTIONAL ARROWS AS INDICATED.
- 9. CLEARANCE BAR. FOOTING BY LANDLORD
- 10. CONCRETE SIDEWALK BY LL.
- 11. ACCESSIBLE PARKING SPACES AND STRIPING BY LL.
- 12. DIGITAL ORDER SCREEN WITH CANOPY. SEE 1/A004. FOOTINGS BY LL.
- 13. 5-PANEL MENU BOARD. SEE 9/A003. FOOTING BY LL.
- 14. LL TO APPLY STAR PATTERN WAYFINDING GRAPHIC TO GROUND USING TRAFFIC PAINT AND THERMO-PLASTIC MATERIAL, ALIGN WITH CANOPY.
- 15. CONCRETE-FILLED STEEL BOLLARD BY LL, SEE 6/A003.
- 16. NON-ILLUMINATED BOLLARD, SEE 7/A003.
- 17. 6" CONCRETE PAVING BY LL.
- 18. POROUS PAVING BY LL
- 19. 12'-0" MIN. DT LANE BY LL. 25'-0" OUTSIDE RADIUS, 20' INSIDE RADIUS.
- 20. TRASH ENCLOSURE BY LL TO MEET SBUX REQUIREMENTS 9'-0" D X 18'-0" W X 7'-0" H, PROVIDE ADEQUATE LIGHTING AND HOSE BIBS.
- 21. ALL CROSSWALK STRIPING BY LL.


GENERAL NOTES

- A. REFER TO EXTERIOR ELEVATIONS ON SHEET A201 FOR BUILDING SIGNAGE LOCATION AND DESIGN ID. REFER TO ELECTRICAL PLANS FOR ELECTRICAL REQUIREMENTS.
- B. LANDSCAPING TO BE PROVIDED PER ZONING CODE AND SUSTAINABILITY REQUIREMENTS.
- C. DRIVE-THRU EQUIPMENT INCLUDING VEHICLE DETECTION LOOP, WIRELESS COMMUNICATION AND MONITORS SHALL BE COORDINATED BY STARBUCKS CONSTRUCTION MANAGER. REFER TO ELECTRICAL DRAWINGS FOR ADDITIONAL REQUIREMENTS.
- D. PROVIDE 6" (150MM) THICK CONCRETE PAVING THE LENGTH OF THE DRIVE-THRU LANE, EXTENT TO INCLUDE DRIVE-THRU ENTRY POINT THROUGH WINDOW STANDING PAD.
- E. GENERAL CONTRACTOR TO APPLY CONCRETE SEALER TO ALL EXTERIOR CONCRETE PATIO AND WALKWAY SURFACES.
- F. GENERAL CONTRACTOR TO VERIFY ALL EXISTING ELEVATIONS AND BUILDING CONDITIONS IN FIELD PRIOR TO START OF CONSTRUCTION.
- G. PROVIDE DETECTABLE WARNING (IF APPLICABLE PER LOCAL CODE) AT TRANSITION FROM SIDEWALK TO DRIVE AISLE.
- H. ACCESSIBLE PARKING SPACES AND ACCESS AISLES SHALL HAVE SURFACE SLOPE NOT TO EXCEED 2% IN ALL DIRECTIONS.
- I. REFER TO ELECTRICAL DRAWINGS FOR SITE RELATED ELECTRICAL WORK.
- J. SCRAPE AND REPAINT ALL EXISTING PAINTED SITE FEATURES, INCLUDING, BUT NOT LIMITED TO CURBS, BOLLARDS, RAILINGS AND SITE LIGHTING BASES.
- K. SEE SHEET A002 FOR ARCHITECTURAL SITE DETAILS.
- L. PROVIDE PROTECTIVE BOLLARDS ON BOTH SIDES OF EXTERIOR UTILITY SERVICES ADJACENT TO VEHICULAR TRAFFIC. EXAMPLES INCLUDE FIRE STAND PIPE, GAS AND ELECTRICAL METERS, SIT TRANSFORMERS, ETC
- M. LL TO ENSURE BARRIER-FREE PATH OF TRAVEL FROM ACCESSIBLE PARKING TO BUILDING ENTRANCE.
- N. ALL FOOTINGS FOR PREVIEW MENU BOARD, ORDER MENU BOARD, SPEAKER POST/ ORDER CONFIRMATION SYSTEM (OCS), DIRECTIONAL SIGNAGE, DT ENTRY SIGN, CLEARANCE BAR, TENANT'S DEDICATED MONUMENT SIGN/PYLON SIGN AND ORDER MENU BOARD CANOPY BY LL.
- O. LL TO PROVIDE PARKING LOT LIGHTING AND ALL UNDER CANOPY MOUNTED LIGHTING.





STARBUCKS FENCE

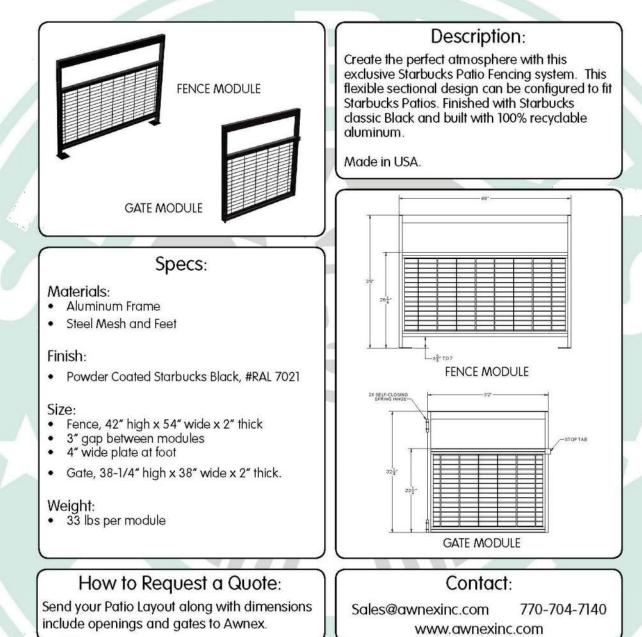

260 Valley Street, Suite 100, Ball Ground, GA 30107

MODULAR RAILING INFO - FOR REFERENCE ONLY scale: N.T.S.



© 2018 STARBUCKS COFFEE COMPANY

STARBUCKS[®] 2401 UTAH AVENUE SOUTH

SEATTLE, WASHINGTON 98134 (206) 318-1575 THESE DRAWINGS AND THE PROJECT MANUAL ARE CONFIDENTIAL AND SHALL REMAIN THE

SOLE PROPERTY OF STARBUCKS CORPORATION, WHICH IS THE OWNER OF THE COPYRIGHT IN THIS WORK. THEY SHALL NOT BE REPRODUCED (IN WHOLE OR IN PART), SHARED WITH THIRD PARTIES OR USED IN ANY MANNER ON OTHER PROJECTS OR EXTENSIONS TO THIS PROJECT WITHOUT THE PRIOR WRITTEN CONSENT OF STARBUCKS CORPORATION. THESE DRAWINGS AND SPECIFICATIONS ARE INTENDED TO EXPRESS


DESIGN INTENT FOR A PROTOTYPICAL STARBUCKS STORE (WHICH IS SUBJECT TO CHANGE AT ANYTIME) AND DO NOT REFLECT ACTUAL SITE CONDITIONS. NEITHER PARTY SHALL HAVE ANY OBLIGATION NOR LIABILITY TO THE OTHER (EXCEPT STATED ABOVE) UNTIL A WRITTEN AGREEMENT IS FULLY EXECUTED BY BOTH PARTIES.

STARBUCKS TEMPLATE VERSION i2019.05.31



520 SOUTH MAIN ST, SUITE 2531 AKRON, OH 44311 P: 330-572-2100 F: 330-572-2101

GPD PROJECT NO: 2019355.03

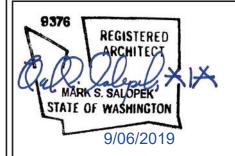

PROJECT ADDRESS:
2418 136TH COURT E
SUMNER, WA 98390

59603 STORE #: PROJECT #: 83746-001 SUBMITTAL 9.6.19 ISSUE DATE:

DESIGN MANAGER: NORIKO TANAKA PRODUCTION DESIGNER: GUY RIPLEY TOM CONNER CHECKED BY:


Revision Schedule


Rev Date


ARCHITECTURAL SITE PLAN SCALE: AS SHOWN

SHEET NUMBER:

0 0

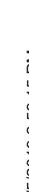

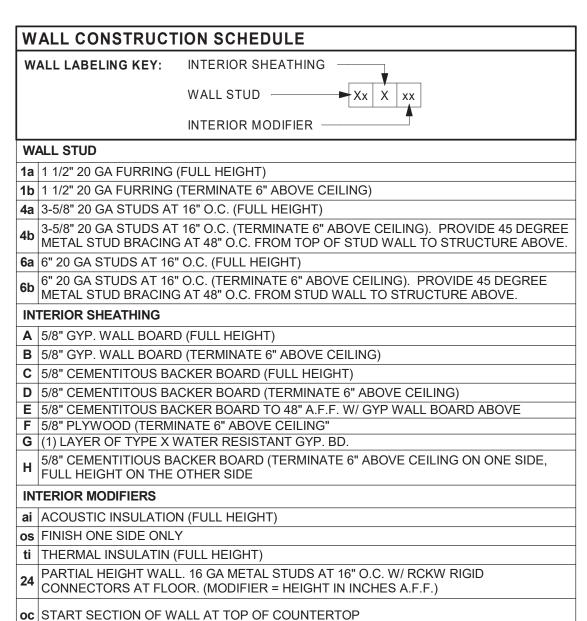

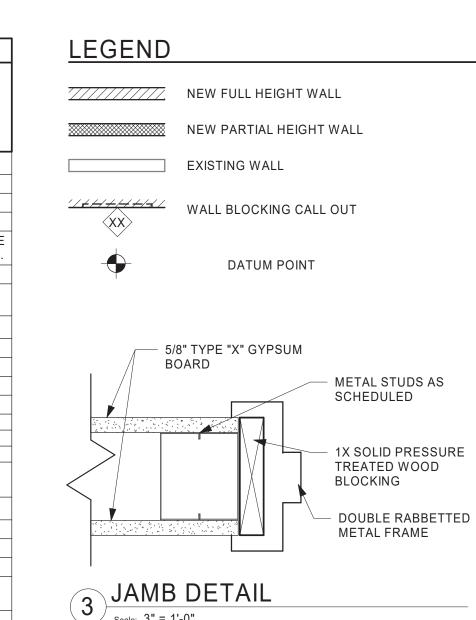

/ Scale: 3" = 1'-0"

BOARD

5/8" TYPE "X" GYPSUM

METAL STUDS AS SCHEDULED

1X SOLID PRESSURE TREATED WOOD BLOCKING

NO RABBET FRAME

SYMBOL ITEM HEIGHT AFF APPROX. WIDTH FULL WIDTH OF WALL MERCHANDISE BAYS AT 300 LBS 1'-4" TO 6'-0" | 3'-0" TO 3'-4" | 2'-4" BEHIND SINK WORKROOM HANDSINK 250 LBS 3'-0" CENTERED **3-COMPARTMENT** 300 LBS 4'-6" TO 7'-0" ABOVE 3-COMP SINK SHELVES 3'-0" CENTERED ABOVE SHELVES AND DATA 300 LBS 3/4" AC PLYWOOD MANAGERS DESK AND RACK (SIAB) DATA RACK 1'-0" AROUND WC 2'-4" TO 3'-0" RR GRAB BARS 300 LBS 2'-4" BEHIND SINK RR HAND SINK 3'-0" TO 3'-4" 300 LBS 50 LBS VARIES 1'-4" BEHIND ARTWORK MOUNTING BRACKET DRIVE THRU 100 LBS 4'-0" TO 6'-4" 6'-4" AT DT WINDOW COMMUNICATIONS EQUIPMENT TEA SHELVES 250 LBS 4'-6" TO 5'-6" 8'-0" SEE DETAILS ON I-5002 FOR MORE INFORMATION

WALL BLOCKING KEY

KEYED NOTES


- 1. 275 SERIES M.O.E.R. DRIVE THRU WINDOW (WITH INTEGRATED TRANSOM) AND HEATED AIR CURTAIN.
- 2. SLAB ON GRADE BY LL. REFER TO SHEET A/102 FOR PENETRATION PLAN
- 3. INSTALL NEW DOORS AS INDICATED. SEE SHEET A601 FOR DOOR AND HARDWARE TYPE.
- 4. OUTLINE OF BAR PER CASEWORK MANUFACTURER.
- 5. FIRE EXTINGUISHER LOCATION.
- 6. ELECTRICAL PANEL LOCATIONS. MAINTAIN MINIMUM CLEARANCE AS REQUIRED BY CODE.
- 7. 36" (915 MM) CLEAR FOR ROOF LADDER ACCESS.
- 8. FURR OUT INTERIOR FACE OF WALL.
- 9. SHELF FOR WATER HEATER ABOVE.

GENERAL NOTES

- A. GENERAL CONTRACTOR TO VERIFY ALL DIMENSIONS AND NOTIFY STARBUCKS CONSTRUCTION MANAGER OF ANY DISCREPANCIES PRIOR TO CONSTRUCTION. ALL DIMENSIONS TO BE TAKEN FROM DESIGNATED DATUM POINT.
- B. GENERAL CONTRACTOR TO PROVIDE FIRE TREATED WOOD STUD BLOCKING, OR EQUIVALENT TO SUPPORT ANY WALL ATTACHMENT AND/OR SIGNAGE.
- C. IF EXISTING EXTERIOR ENTRANCE THRESHOLD EXCEEDS MINIMUM BARRIER FREE PROVISION OF THE CODE. REMOVE AND REPLACE WITH ACCESSIBLE THRESHOLD. RAISED THRESHOLDS AND FLOOR LEVEL CHANGES AT ACCESSIBLE DOORWAYS TO BE BEVELED WITH A SLOPE NO GREATER THAN 1:12.
- D. ALL DIMENSIONS ARE TO FINISHED FACE UNLESS SHOWN OR NOTED OTHERWISE.
- E.. INSTALL MOISTURE RESISTANT GREEN BOARD ON BACKBAR WALL PER PROJECT MANUAL.
- F. ALL DOORS SHALL BE 32" (815MM) MINIMUM CLEAR OPENING WHEN OPENED TO 90 DEGREE POSITION UNLESS OTHERWISE NOTED.
- G. SEE SHEET A601 FOR EXTERIOR DOOR AND WINDOW SCHEDULES.
- H. STARBUCKS VENDOR TO PROVIDE DOOR HARDWARE COMPONENTS AND GC TO INSTALL.
- I. VERIFY ALL EXISTING DOORS, HARDWARE AND FRAMES MEET STARBUCKS AND/OR CODE REQUIREMENTS.
- J. PROVIDE FIRE EXTINGUISHERS AS NOTED ON THE
- APPROVED PLANS FROM THE CITY.
- K. SEE STRUCTURAL FOR KNEE WALL BRACING.
- L. SEE SHEET A501 FOR BUILDING DETAILS.
- M. REFER TO SHEET I104 FOR FLOOR FINISHES.

WALL TYPE LEGEND

WALL FRAMING AND EXTERIOR SUBSTRATE PER LL, 5/8" GYPSUM **BOARD ON INTERIOR BY GC** (MOISTURE RESISTANT ON RR, WORKROOM, AND BACKBAR WALLS

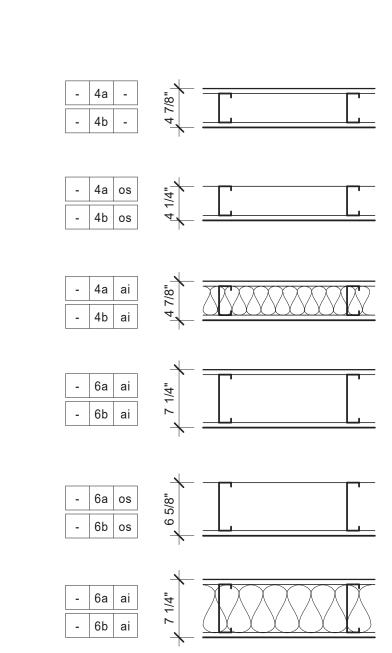



2401 UTAH AVENUE SOUTH SEATTLE, WASHINGTON 98134 (206) 318-1575

THESE DRAWINGS AND THE PROJECT MANUAL ARE CONFIDENTIAL AND SHALL REMAIN THE SOLE PROPERTY OF STARBUCKS CORPORATION, WHICH IS THE OWNER OF THE COPYRIGHT IN THIS WORK. THEY SHALL NOT

BE REPRODUCED (IN WHOLE OR IN PART), SHARED WITH THIRD PARTIES OR USED IN ANY MANNER ON OTHER PROJECTS OR EXTENSIONS TO THIS PROJECT WITHOUT THE PRIOR WRITTEN CONSENT OF STARBUCKS CORPORATION. THESE DRAWINGS AND SPECIFICATIONS ARE INTENDED TO EXPRESS


DESIGN INTENT FOR A PROTOTYPICAL STARBUCKS STORE (WHICH IS SUBJECT TO CHANGE AT ANYTIME) AND DO NOT REFLECT ACTUAL SITE CONDITIONS. NEITHER PARTY SHALL HAVE ANY OBLIGATION NOR LIABILITY TO THE OTHER (EXCEPT STATED ABOVE) UNTIL A WRITTEN AGREEMENT IS FULLY EXECUTED BY **BOTH PARTIES.**

STARBUCKS TEMPLATE VERSION i2019.05.31



Professional Corporation 520 SOUTH MAIN ST, SUITE 2531 AKRON, OH 44311 P: 330-572-2100 F: 330-572-2101

GPD PROJECT NO: 2019355.03

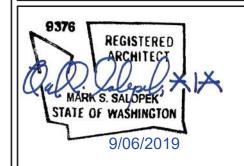

STORE #: 59603 PROJECT #: 83746-001 ISSUE DATE:


DESIGN MANAGER: NORIKO TANAKA PRODUCTION DESIGNER: GUY RIPLEY CHECKED BY: TOM CONNER


Revision Schedule


Rev	Date	Ву	Description


BUILDING FLOOR PLAN


SCALE: AS SHOWN SHEET NUMBER:

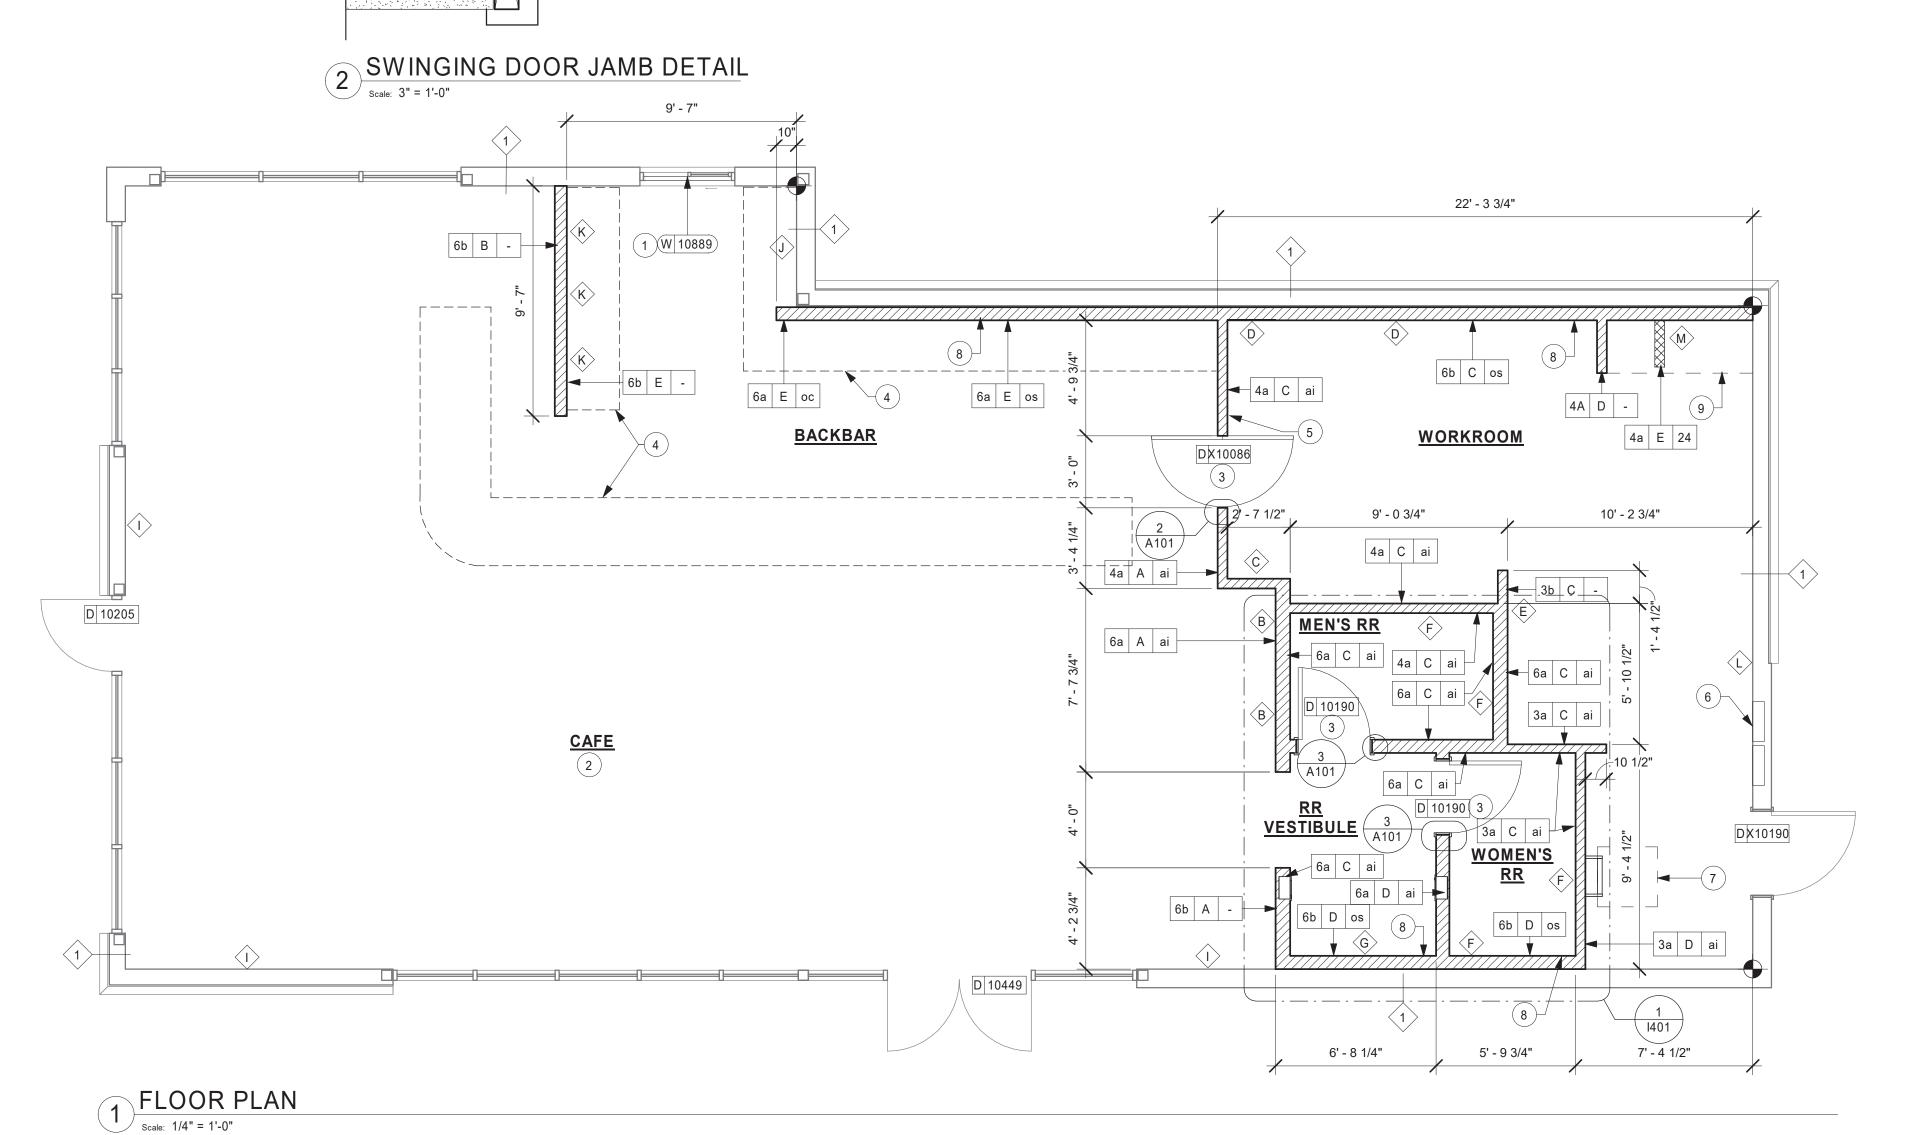

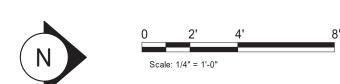

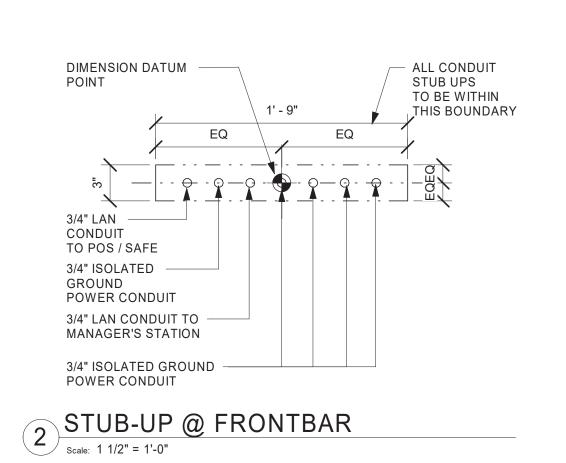

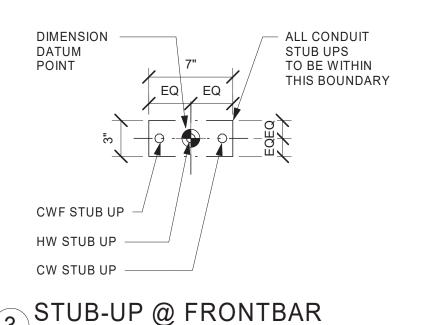

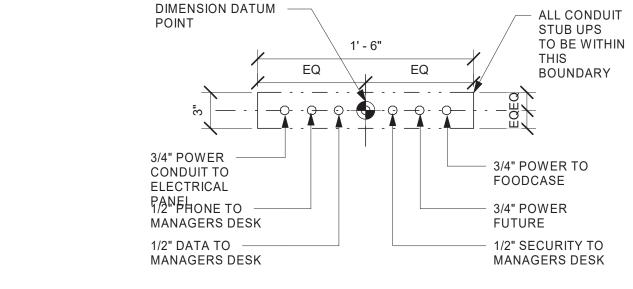

STUB-UP @ POS/SAFE

KEYED NOTES

- 1. FLOOR SINK, SEE PLUMBING DRAWINGS.
- 2. ELECTRICAL PENETRATION AREA, SEE ELECTRICAL DRAWINGS.
- 3. PLUMBING PENETRATION AREA, SEE PLUMBING DRAWINGS.
- 4. WASTE DRAIN FOR MOP SINK.
- 5. WASTE DRAIN FOR TOILET
- 6. DATUM POINT.
- 7. OUTLINE OF CASEWORK
- 8. CLEAN OUT, SEE PLUMBING DRAWINGS.
- 9. FLOOR DRAIN, SEE PLUMBING DRAWINGS.
- 10. ELECTRICAL PANELS BY LL.
- 11. RECESSED CONCRETE AREA FOR WALK OFF MAT. COORDINATE WITH FINISH PLAN 1104.
- 12. GREASE INTERCEPTOR IN FLOOR. SEE PLUMBING DRAWINGS.

GENERAL NOTES

- A. ALL STUB-UP DIMENSIONS ARE RELATIVE TO FINISHED WALL LOCATIONS (SHOWN AS OUTLINES ON THIS PLAN). REFER TO FLOOR PLAN FOR WALL PLACEMENT.
- B. FLOOR SINK: REFER TO CUT SHEETS FOR COMPONENT SPECIFICATIONS AND CUTOUT REQUIREMENTS.
- C. WASTE LINE PENETRATIONS: REFER TO PLUMBING PLANS FOR INDIVIDUAL LINE LOCATIONS.
- D. STUB-UP PENETRATIONS: REFER TO ELECTRICAL AND PLUMBING PLANS FOR INDIVIDUAL STUB-UP LOCATIONS.
- E. TOILET FLOOR PENETRATION: REFER TO CUT SHEETS FOR STUB-UP LOCATION RELATIVE TO FINISHED WALL.
- F. PENETRATION TO BE LOCATED ON CENTERLINE OF
- WALL OR AS REQUIRED PER CONDITIONS.
- G. TRENCHING OUTLINE FOR GUIDELINE USE ONLY. GENERAL CONTRACTOR TO COORDINATE WITH SPECIFIC TRADES AND SITE CONDITIONS TO DETERMINE ACTUAL LAYOUT.
- H. REFER TO SHEET I101 FOR FLOOR FINISHES.



Professional Corporation

© 2018 STARBUCKS COFFEE COMPANY

STARBUCKS[®]

2401 UTAH AVENUE SOUTH

SEATTLE, WASHINGTON 98134

(206) 318-1575

THESE DRAWINGS AND THE PROJECT MANUAL

ARE CONFIDENTIAL AND SHALL REMAIN THE

SOLE PROPERTY OF STARBUCKS

CORPORATION, WHICH IS THE OWNER OF THE

COPYRIGHT IN THIS WORK. THEY SHALL NOT

SHARED WITH THIRD PARTIES OR USED IN AN'

MANNER ON OTHER PROJECTS OR EXTENSIONS TO THIS PROJECT WITHOUT THE PRIOR WRITTEN CONSENT OF STARBUCKS CORPORATION. THESE DRAWINGS AND SPECIFICATIONS ARE INTENDED TO EXPRESS DESIGN INTENT FOR A PROTOTYPICAL STARBUCKS STORE (WHICH IS SUBJECT TO CHANGE AT ANYTIME) AND DO NOT REFLECT

ACTUAL SITE CONDITIONS. NEITHER PARTY

THE OTHER (EXCEPT STATED ABOVE) UNTIL A

WRITTEN AGREEMENT IS FULLY EXECUTED BY

BOTH PARTIES.

STARBUCKS TEMPLATE VERSION i2019.05.31

SHALL HAVE ANY OBLIGATION NOR LIABILITY TO

BE REPRODUCED (IN WHOLE OR IN PART),

520 SOUTH MAIN ST, SUITE 2531 AKRON, OH 44311 P: 330-572-2100 F: 330-572-2101

GPD PROJECT NO: 2019355.03



STORE #: PROJECT #:

CHECKED BY:

83746-001 ISSUE DATE: DESIGN MANAGER: NORIKO TANAKA PRODUCTION DESIGNER: GUY RIPLEY


59603

TOM CONNER

FLOOR PENETRATION PLAN

SCALE: AS SHOWN SHEET NUMBER:

A102

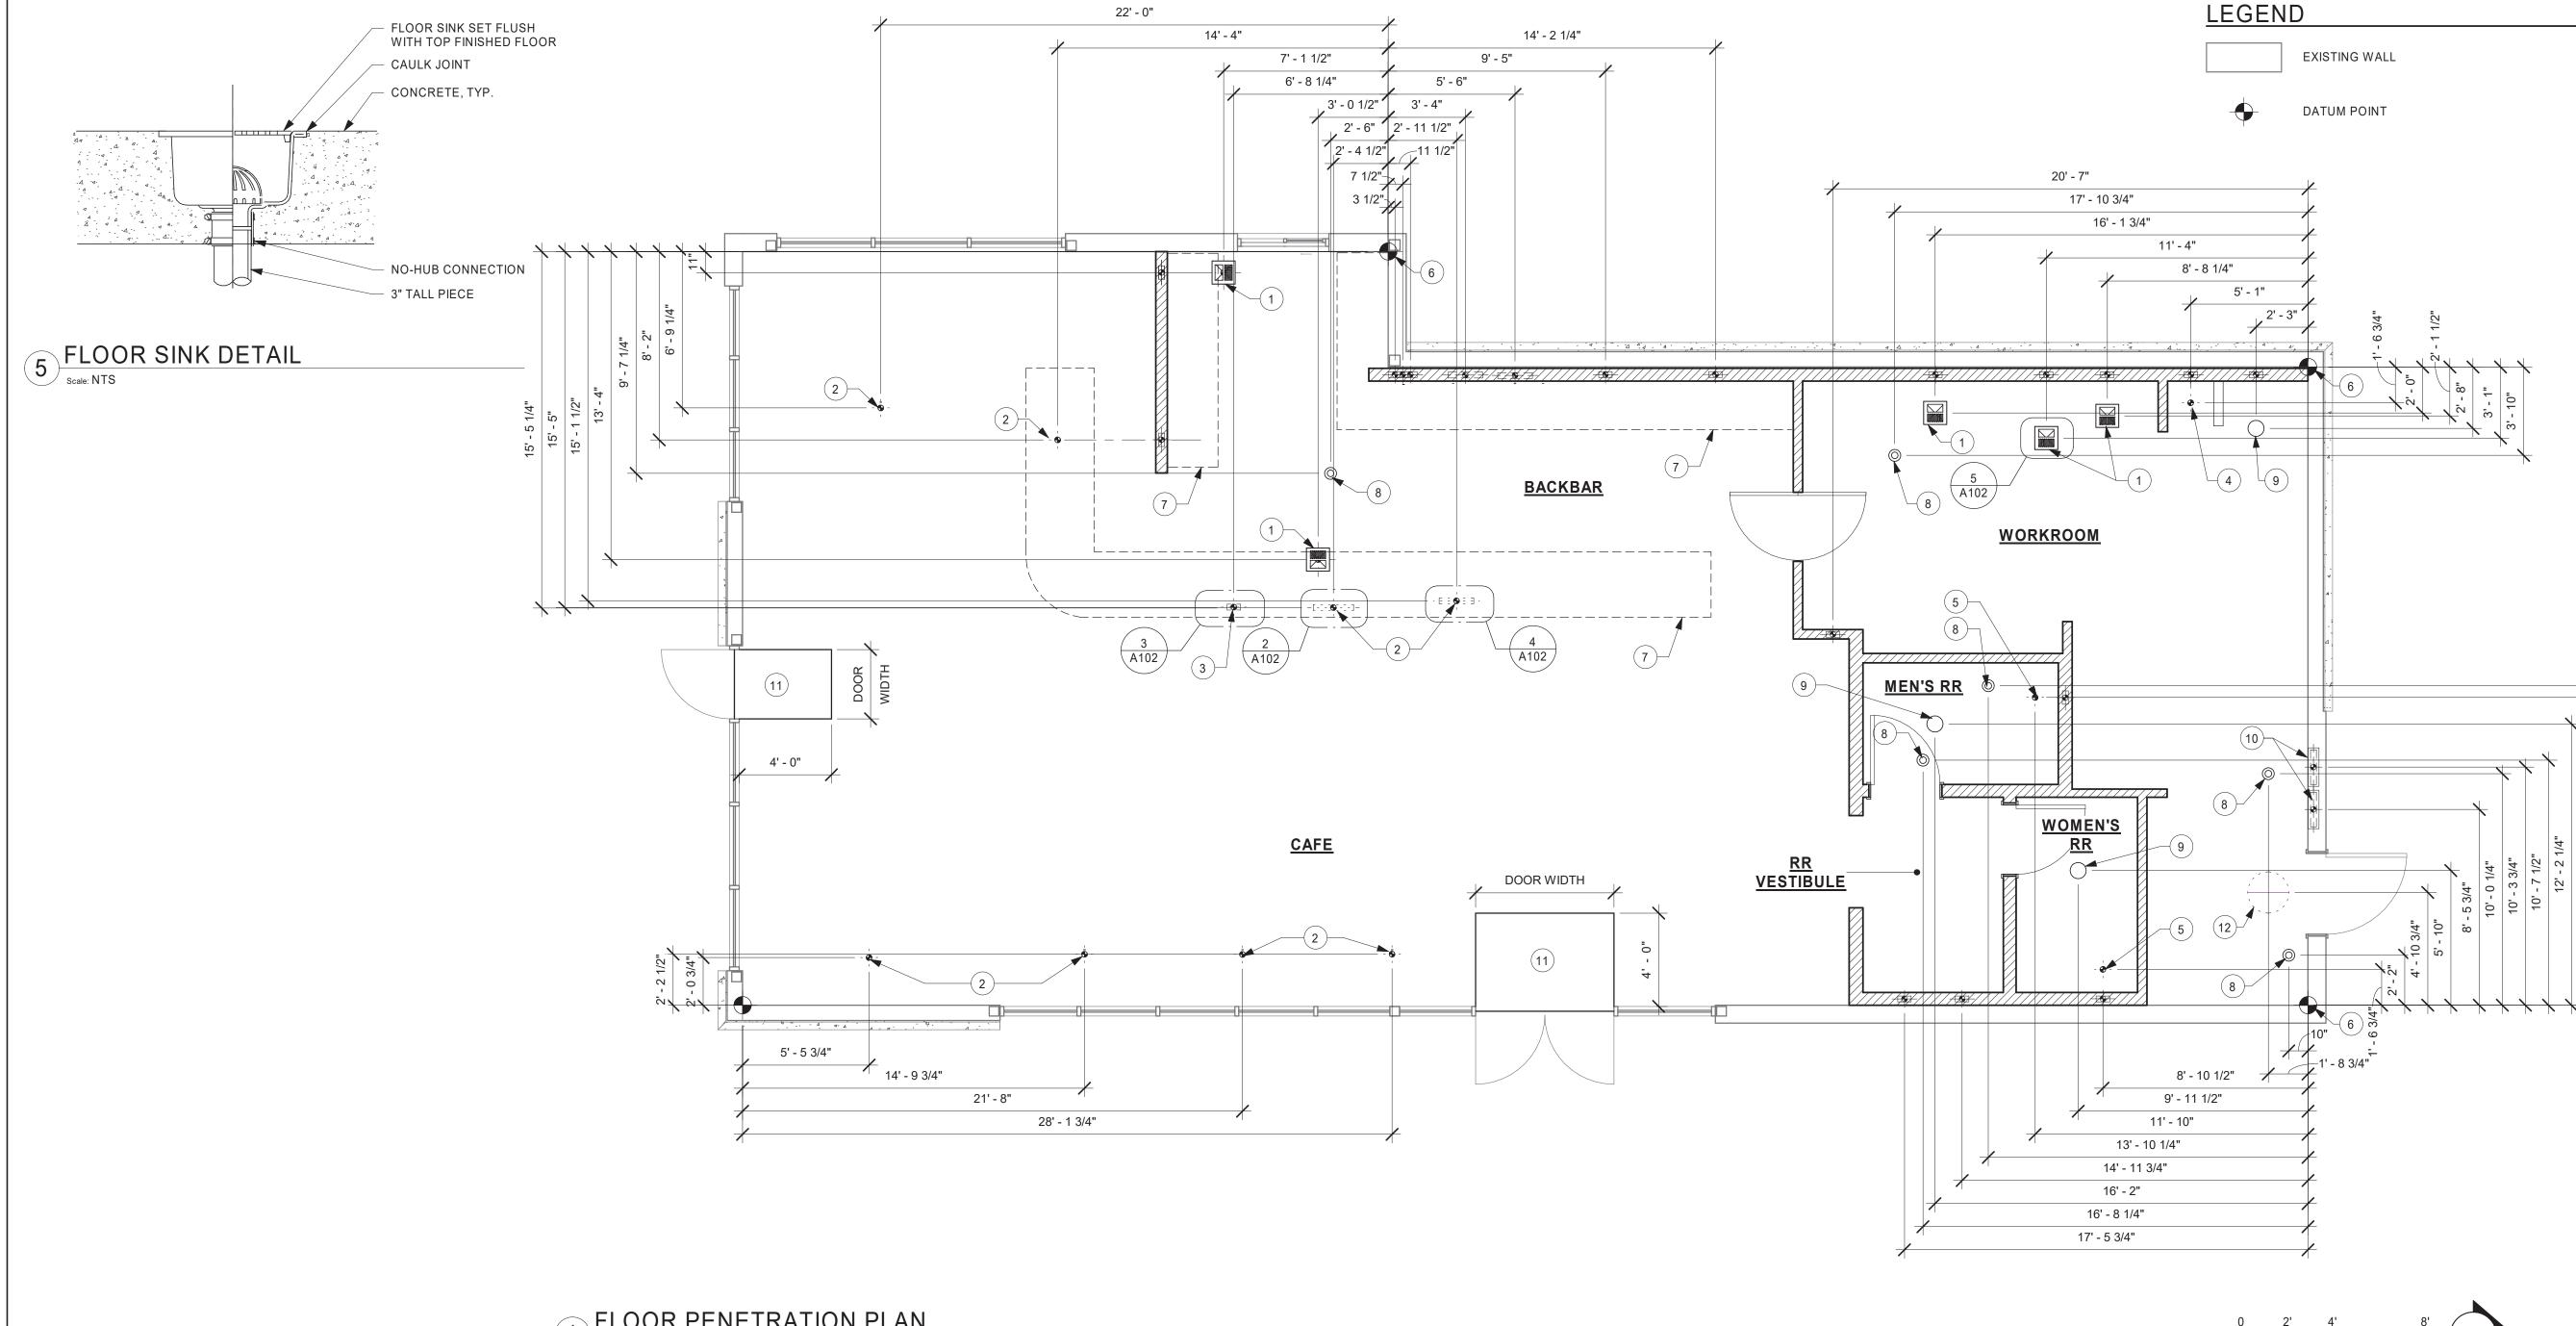

1 FLOOR PENETRATION PLAN

| Scale: 1/4" = 1'-0"

KEYED NOTES

- 1. AWNING BELOW. SEE ELEVATIONS.
- 2. SCUPPER AND DOWN SPOUT CONNECTED TO STORM SEWER SYSTEM BY LL.
- 3. WATER HEATER FLUE. SEE MECHANICAL.
- 4. ROOF ACCESS HATCH BY LL.
- 5. PRE-FINISHED METAL COPING (TYP.) BY LL.
- 6. MEMBRANE ROOFING SLOPE MINIMUM 1/4" PER FOOT (TYP.) BY LL.
- 7. ROOF CRICKET BY LL.
- 8. ROOF TOP EQUIPMENT. SEE MECHANICAL. LL TO ENSURE INSTALLATION IS COMPLIANT WITH ALL CODES AND REGULATIONS.
- 9. RESTROOM EXHAUST FAN BY LL. SEE MECHANICAL.
- 10. ICE MACHINE CONDENSER. SEE MECHANICAL.

GENERAL NOTES

- A. GENERAL CONTRACTOR TO VERIFY ALL DIMENSIONS AND NOTIFY STARBUCKS CONSTRUCTION MANAGER OF ANY DISCREPANCIES PRIOR TO CONSTRUCTION. ALL DIMENSIONS TO BE TAKEN FROM DESIGNATED DATUM POINT.
- B. IN FREEZE-THAW CLIMATES ONLY: INSTALL SELF-REGULATING HEAT TAPE IN ALL DOWNSPOUTS. SEE ELECTRICAL FOR FURTHER INFORMATION.
- C. ROOF TOP PLUMBING VENTS ARE NOT SHOWN FOR CLARITY. REFER TO PLUMBING DRAWINGS FOR VTR LOCATIONS AND FURTHER INFORMATION.
- D. INSTALL SECOND LAYER OF ROOF MEMBRANE FOR 36" (915MM) PERIMETER AROUND ROOF TOP EQUIPMENT AND ROOF HATCH (TYP.).



© 2018 STARBUCKS COFFEE COMPANY

STARBUCKS®

2401 UTAH AVENUE SOUTH SEATTLE, WASHINGTON 98134 (206) 318-1575

THESE DRAWINGS AND THE PROJECT MANUAL

ARE CONFIDENTIAL AND SHALL REMAIN THE SOLE PROPERTY OF STARBUCKS CORPORATION, WHICH IS THE OWNER OF THE COPYRIGHT IN THIS WORK. THEY SHALL NOT BE REPRODUCED (IN WHOLE OR IN PART), SHARED WITH THIRD PARTIES OR USED IN ANY MANNER ON OTHER PROJECTS OR EXTENSIONS TO THIS PROJECT WITHOUT THE PRIOR WRITTEN CONSENT OF STARBUCKS


CORPORATION. THESE DRAWINGS AND SPECIFICATIONS ARE INTENDED TO EXPRESS DESIGN INTENT FOR A PROTOTYPICAL STARBUCKS STORE (WHICH IS SUBJECT TO CHANGE AT ANYTIME) AND DO NOT REFLECT ACTUAL SITE CONDITIONS. NEITHER PARTY SHALL HAVE ANY OBLIGATION NOR LIABILITY TO THE OTHER (EXCEPT STATED ABOVE) UNTIL A WRITTEN AGREEMENT IS FULLY EXECUTED BY BOTH PARTIES.

STARBUCKS TEMPLATE VERSION i2019.05.31



520 SOUTH MAIN ST, SUITE 2531 AKRON, OH 44311 P: 330-572-2100 F: 330-572-2101

GPD PROJECT NO: 2019355.03

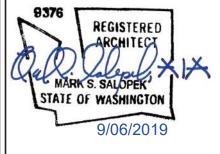

STORE #: PROJECT #:

59603 83746-001

DESIGN MANAGER: NORIKO TANAKA PRODUCTION DESIGNER: GUY RIPLEY CHECKED BY: TOM CONNER

Revision Schedule

R	ev	Date	Ву	Description
ΙГ				
Ш				
Ш				
Ш				
Ш				

BUILDING ROOF PLAN

SCALE: AS SHOWN

SHEET NUMBER: A103

7 4' - 8" 10' - 8" 23' - 7 1/2" 10' - 8 1/4"

1 ROOF PLAN

| Scale: 1/4" = 1'-0"

DIMENSIONS OF BUILDING SHELL FOR REFERENCE ONLY

SIGNAGE TO BE SUBMITTED UNDER

- 2. LL TO PROVIDE 3" (75MM) HIGH BLACK ACRYLIC STORE ADDRESS ON GLAZING OR PER LOCAL JURISDICTIONAL CODE REQUIREMENTS.
- 3. SIGNAGE PERMITTED BY OTHERS UNDER SEPARATE PERMIT, SEE ELECTRICAL DRAWINGS
- 4. LIGHTING MOUNTED UNDER CANOPY BY LL.
- 5. EXTERIOR LIGHTING BY LL, TYP.
- 6. MODULAR PATIO RAILING BY LL. SECURE TO CONCRETE WITH (4) 1/4" X 4" TITANS @ EACH LEG PER MANUFÁCTURER INSTRUCTIONS.
- 7. BIKE RACK BY LL.
- 8. LL TO PROVIDE SLEEVE FOR SPEAKER WIRING AT 9'-6" A.F.F.
- 9. EXTERIOR FURNITURE.

KEYED NOTES

1. STOREFRONT ENTRY DOOR BY LL

- 10. PRE-FINISHED METAL COPING BY LL.
- 11. OUTLINE OF PARAPET BEYOND.
- 12. ROOF SCUPPER AND OVERFLOW. 13. METAL CANOPY BY LL.

GENERAL NOTES

- A. GENERAL CONTRACTOR TO COORDINATE AND SCHEDULE SIGNAGE INSTALLATION WITH THE SIGNAGE CONTRACTOR PROVIDING A MINIMUM SCHEDULING NOTICE OF 4 WEEKS AND 1 WEEK PRIOR TO SCHEDULED DATE OF INSTALLATION. CONSTRUCTION MANAGER TO PROVIDE GENERAL CONTRACTOR WITH SIGNAGE CONTRACTOR CONTACT INFORMATION.
- B. GENERAL CONTRACTOR SHALL COORDINATE WITH ELECTRICAL CONTRACTOR TO FURNISH AND INSTALL ELECTRICAL CIRCUITS INCLUDING ALL CONDUIT, WIRE, CONNECTIONS AND BREAKER AT PANEL BOARD NECESSARY TO SERVE SIGNAGE.
- C. GENERAL CONTRACTOR TO PROVIDE FIRE TREATED WOOD STUD BLOCKING OR EQUIVALENT TO SUPPORT
- D. SIGNAGE CONTRACTOR SHALL VERIFY SIZE AND LOCATION OF ANY AND ALL ALLOWABLE MONUMENT OR POLE SIGNAGE AND PROVIDE SHOP DRAWING(S) PRIOR TO FABRICATION TO THE STARBUCKS DESIGNER FOR
- E. SIGNAGE CONTRACTOR TO INSTALL SIGNAGE IN COMPLIANCE WITH LOCAL CODES AND OBTAIN PERMIT.
- F. SIGNAGE CONTRACTOR TO SUPPLY SHOP DRAWINGS TO CONSTRUCTION MANAGER AND TO THE GENERAL CONTRACTOR AS NEEDED. GENERAL CONTRACTOR TO NOTIFY CONSTRUCTION MANAGER IMMEDIATELY IF SHOP DRAWINGS OR INSTALLATION IS IN DISCREPANCY WITH ARCHITECTURAL DRAWINGS.
- G. GENERAL CONTRACTOR TO CLEAN, PATCH AND REPAIR EXISTING EXTERIOR AS REQUIRED.
- H. GC TO PROVIDE J-BOX W/ PULL STRING FOR FUTURE BUILDING SIGNAGE.
- I. 3/4" MARINE GRADE PLYWOOD BLOCKING FOR EXTERIOR SIGNAGE. EXTEND BLOCKING 8" (205MM) MIN. BEYOND EDGE OF SIGNAGE.
- J. LL TO PROVIDE PENETRATIONS, SLEEVES AND WHIPS FOR ALL BUILDING SIGNAGE. COORDINATE RACEWAY LOCATIONS AS NECESSARY.



(C) 2018 STARBUCKS COFFEE COMPANY

STARBUCKS® 2401 UTAH AVENUE SOUTH SEATTLE, WASHINGTON 98134

(206) 318-1575

THESE DRAWINGS AND THE PROJECT MANUAL ARE CONFIDENTIAL AND SHALL REMAIN THE SOLE PROPERTY OF STARBUCKS CORPORATION, WHICH IS THE OWNER OF THE COPYRIGHT IN THIS WORK. THEY SHALL NOT BE REPRODUCED (IN WHOLE OR IN PART), SHARED WITH THIRD PARTIES OR USED IN ANY

MANNER ON OTHER PROJECTS OR

EXTENSIONS TO THIS PROJECT WITHOUT THE PRIOR WRITTEN CONSENT OF STARBUCKS CORPORATION. THESE DRAWINGS AND SPECIFICATIONS ARE INTENDED TO EXPRESS DESIGN INTENT FOR A PROTOTYPICAL STARBUCKS STORE (WHICH IS SUBJECT TO CHANGE AT ANYTIME) AND DO NOT REFLECT ACTUAL SITE CONDITIONS. NEITHER PARTY SHALL HAVE ANY OBLIGATION NOR LIABILITY TO THE OTHER (EXCEPT STATED ABOVE) UNTIL A WRITTEN AGREEMENT IS FULLY EXECUTED BY

STARBUCKS TEMPLATE VERSION i2019.05.31


BOTH PARTIES.



Professional Corporation

520 SOUTH MAIN ST, SUITE 2531 AKRON, OH 44311 P: 330-572-2100 F: 330-572-2101

GPD PROJECT NO: 2019355.03

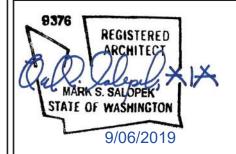

59603

STORE #: PROJECT #:


PRO.


83746-001 SUBMITTAL 9.6.19 ISSUE DATE: DESIGN MANAGER: NORIKO TANAKA

PRODUCTION DESIGNER: GUY RIPLEY CHECKED BY: TOM CONNER

BUILDING EXTERIOR ELEVATIONS SCALE: AS SHOWN

SHEET NUMBER:

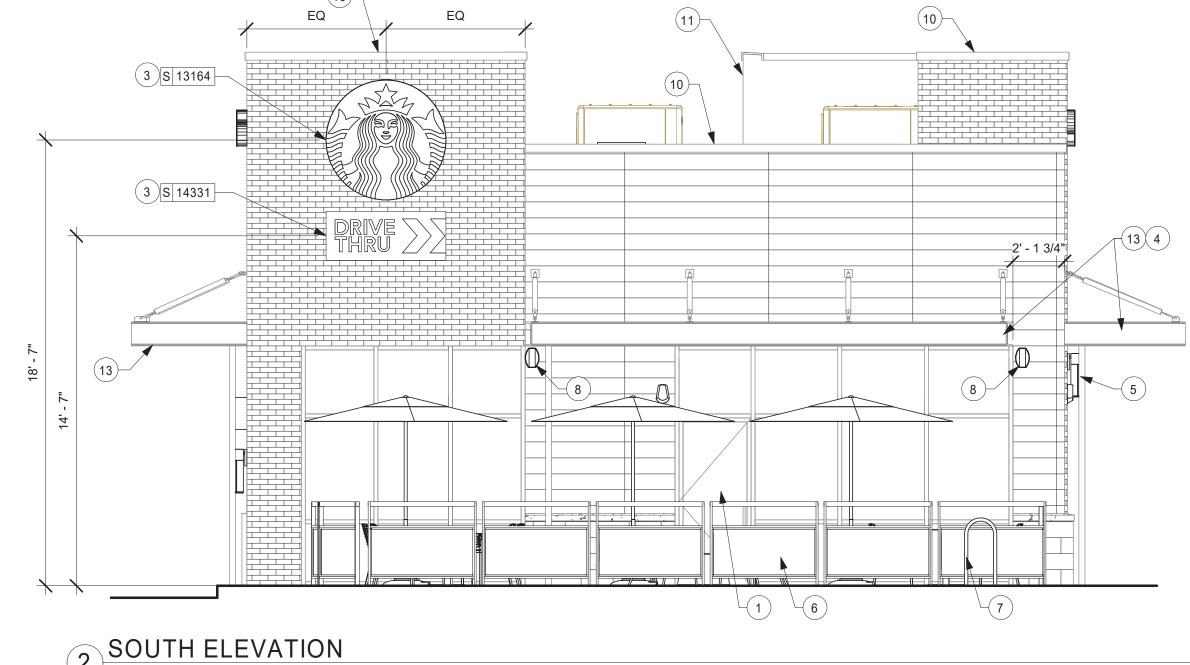

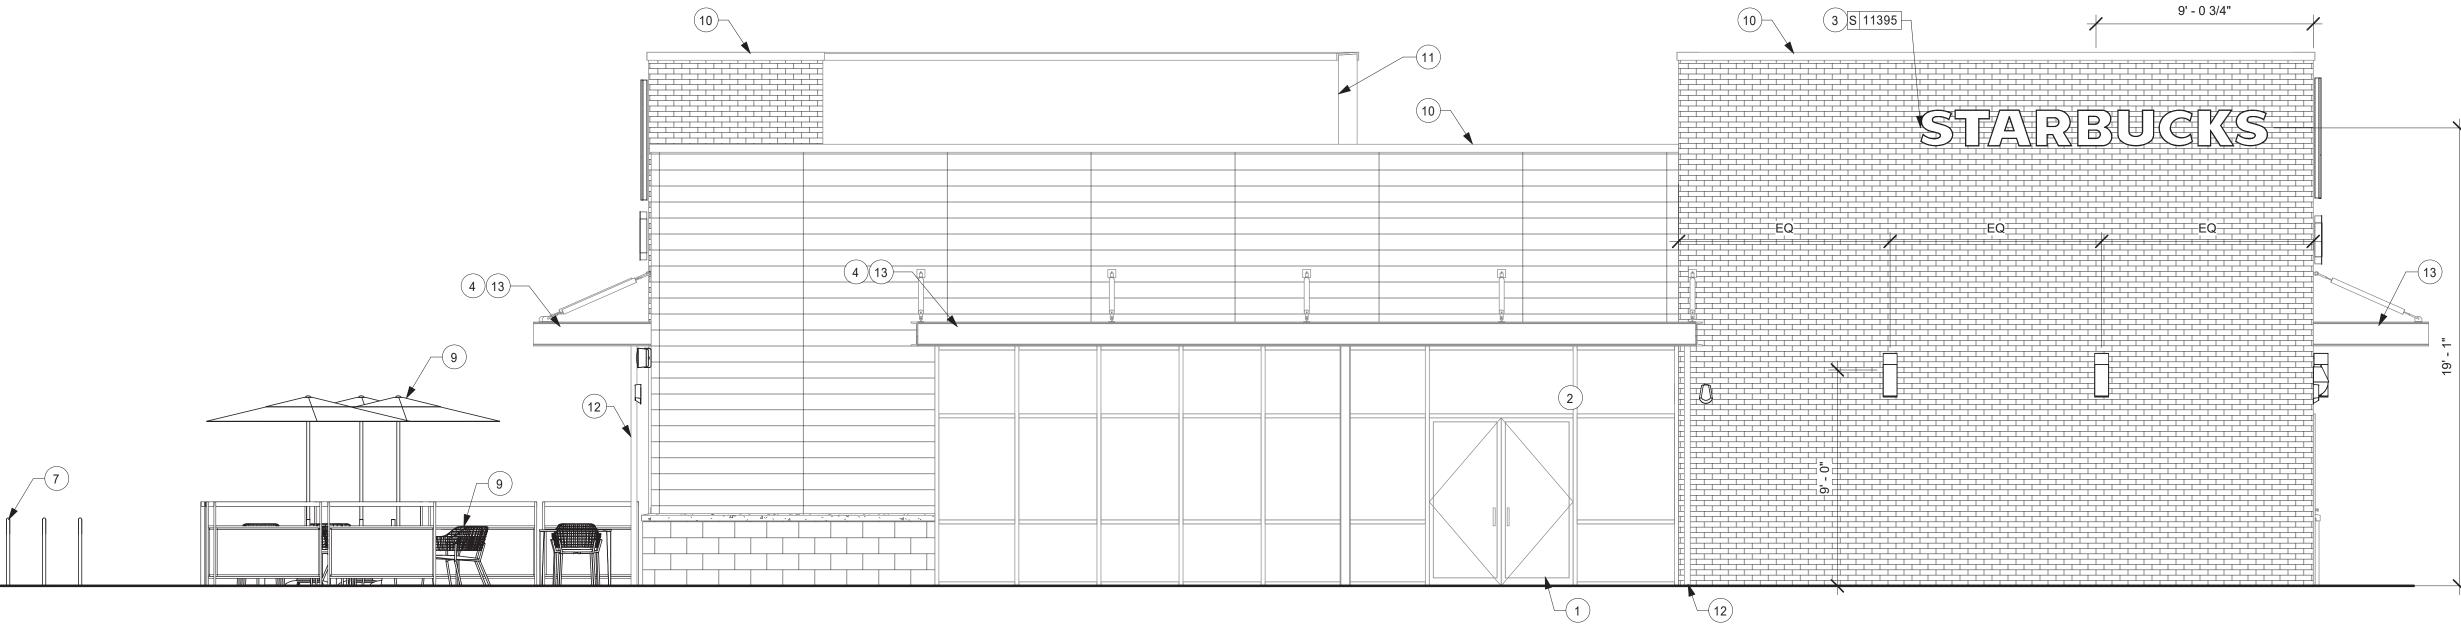


1 EAST ELEVATION


Scale: 1/4" = 1'-0"

SIGNAGE TO BE SUBMITTED UNDER SEPARATE PERMIT BY OTHERS -SHOWN FOR REFERENCE ONLY.

DIMENSIONS OF BUILDING SHELL FOR REFERENCE ONLY

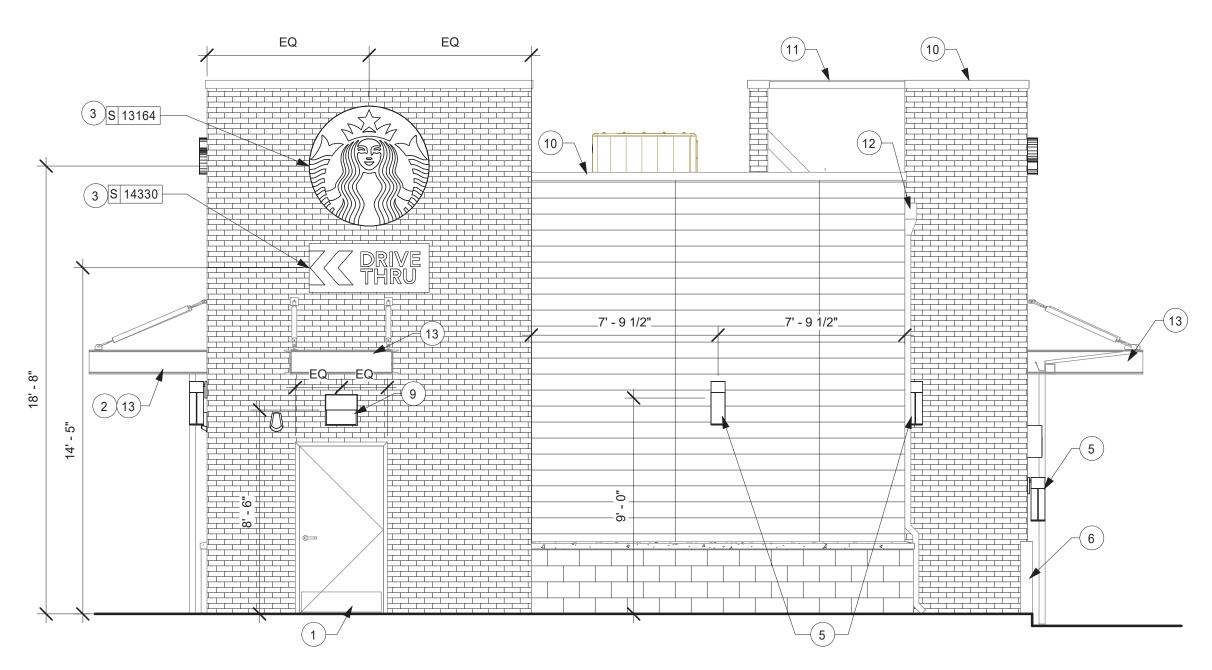

NORTH ELEVATION

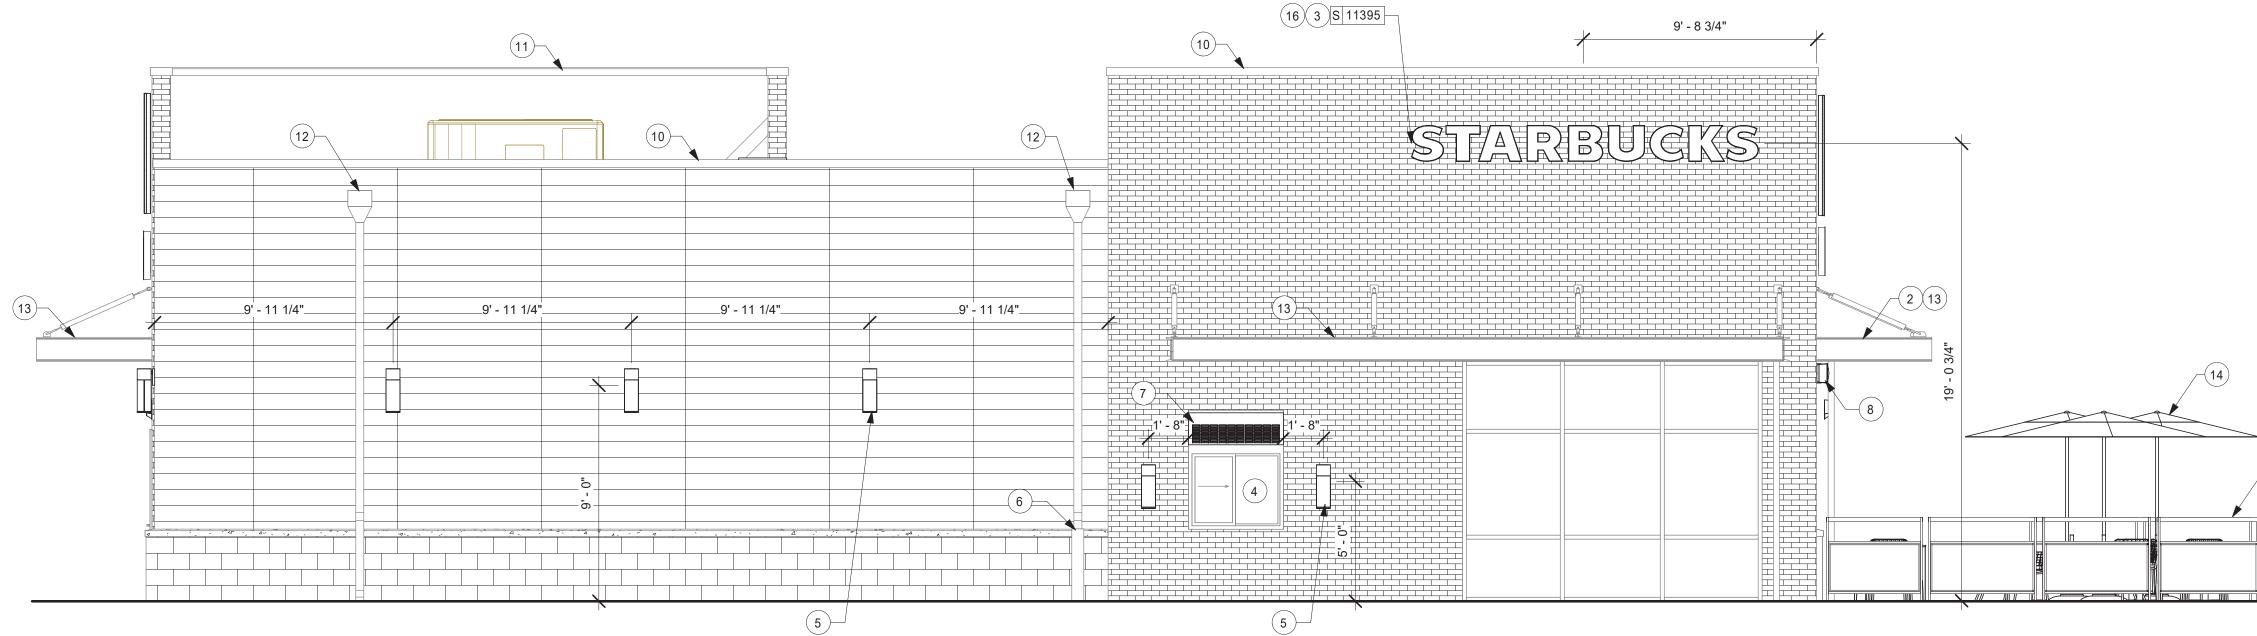



KEYED NOTES

- 1. HOLLOW METAL SERVICE DOOR BY LL.
- 2. LIGHTING MOUNTED UNDER CANOPY BY LL.
- 3. SIGNAGE PERMITTED BY OTHERS UNDER SEPARATE PERMIT, SEE ELECTRICAL DRAWINGS
- 4. LL TO FURNISH AND INSTALL TENANT SPECIFIED DRIVE THRU SERVICE WINDOW WITH ALL CONNECTIONS.
- 5. EXTERIOR LIGHTING BY LL, TYP.
- 6. BOLLARD BY LL.
- 7. HEATED AIR CURTAIN AT DRIVE THRU WINDOW TO BE HARDWIRED BY LL.
- 8. LL TO PROVIDE SLEEVE FOR SPEAKER WIRING AT 9'-6" A.F.F.
- 9. SECURITY LIGHT ABOVE ENTRY DOOR BY LL.
- 10. PRE-FINISHED METAL COPING BY LL.
- 11. OUTLINE OF ROOF BEYOND.
- 12. ROOF SCUPPER AND OVERFLOW BY LL.
- 13. METAL CANOPY BY LL.
- 14. EXTERIOR FURNITURE
- 15. MODULAR PATIO RAILING BY LL. SECURE TO CONCRETE WITH (4) 1/4" X 4" TITANS @ EACH LEG PER MANUFACTURER INSTRUCTIONS

GENERAL NOTES

- A. GENERAL CONTRACTOR TO COORDINATE AND SCHEDULE SIGNAGE INSTALLATION WITH THE SIGNAGE CONTRACTOR PROVIDING A MINIMUM SCHEDULING NOTICE OF 4 WEEKS AND 1 WEEK PRIOR TO SCHEDULED DATE OF INSTALLATION. CONSTRUCTION MANAGER TO PROVIDE GENERAL CONTRACTOR WITH SIGNAGE CONTRACTOR CONTACT INFORMATION.
- B. GENERAL CONTRACTOR SHALL COORDINATE WITH ELECTRICAL CONTRACTOR TO FURNISH AND INSTALL ELECTRICAL CIRCUITS INCLUDING ALL CONDUIT, WIRE, CONNECTIONS AND BREAKER AT PANEL BOARD NECESSARY TO SERVE SIGNAGE.
- C. GENERAL CONTRACTOR TO PROVIDE FIRE TREATED WOOD STUD BLOCKING OR EQUIVALENT TO SUPPORT SIGNAGE.
- D. SIGNAGE CONTRACTOR SHALL VERIFY SIZE AND LOCATION OF ANY AND ALL ALLOWABLE MONUMENT OR POLE SIGNAGE AND PROVIDE SHOP DRAWING(S) PRIOR TO FABRICATION TO THE STARBUCKS DESIGNER FOR
- E. SIGNAGE CONTRACTOR TO INSTALL SIGNAGE IN COMPLIANCE WITH LOCAL CODES AND OBTAIN PERMIT.
- F. SIGNAGE CONTRACTOR TO SUPPLY SHOP DRAWINGS TO CONSTRUCTION MANAGER AND TO THE GENERAL CONTRACTOR AS NEEDED. GENERAL CONTRACTOR TO NOTIFY CONSTRUCTION MANAGER IMMEDIATELY IF SHOP DRAWINGS OR INSTALLATION IS IN DISCREPANCY WITH ARCHITECTURAL DRAWINGS.
- G. GENERAL CONTRACTOR TO CLEAN, PATCH AND REPAIR EXISTING EXTERIOR AS REQUIRED.
- H. GC TO PROVIDE J-BOX W/ PULL STRING FOR FUTURE BUILDING SIGNAGE COORDINATE LOCATIONS WITH SIGNAGE VENDOR PRIOR TO INSTALL
- I. 3/4" MARINE GRADE PLYWOOD BLOCKING FOR EXTERIOR SIGNAGE. EXTEND BLOCKING 8" (205MM) MIN. BEYOND EDGE OF SIGNAGE.
- J. LL TO PROVIDE PENETRATIONS, SLEEVES AND WHIPS FOR ALL BUILDING SIGNAGE. COORDINATE RACEWAY LOCATIONS AS NECESSARY.



© 2018 STARBUCKS COFFEE COMPANY

STARBUCKS[®] 2401 UTAH AVENUE SOUTH SEATTLE, WASHINGTON 98134

THESE DRAWINGS AND THE PROJECT MANUAL ARE CONFIDENTIAL AND SHALL REMAIN THE SOLE PROPERTY OF STARBUCKS CORPORATION, WHICH IS THE OWNER OF THE COPYRIGHT IN THIS WORK. THEY SHALL NOT BE REPRODUCED (IN WHOLE OR IN PART), SHARED WITH THIRD PARTIES OR USED IN ANY MANNER ON OTHER PROJECTS OR

(206) 318-1575

EXTENSIONS TO THIS PROJECT WITHOUT THE PRIOR WRITTEN CONSENT OF STARBUCKS CORPORATION. THESE DRAWINGS AND SPECIFICATIONS ARE INTENDED TO EXPRESS DESIGN INTENT FOR A PROTOTYPICAL STARBUCKS STORE (WHICH IS SUBJECT TO CHANGE AT ANYTIME) AND DO NOT REFLECT ACTUAL SITE CONDITIONS. NEITHER PARTY SHALL HAVE ANY OBLIGATION NOR LIABILITY TO THE OTHER (EXCEPT STATED ABOVE) UNTIL A WRITTEN AGREEMENT IS FULLY EXECUTED BY BOTH PARTIES.


STARBUCKS TEMPLATE VERSION i2019.05.31



Professional Corporation

520 SOUTH MAIN ST, SUITE 2531 AKRON, OH 44311 P: 330-572-2100 F: 330-572-2101

GPD PROJECT NO: 2019355.03

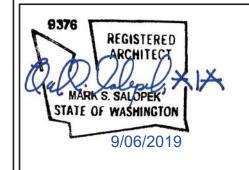

STORE #: PROJECT #:

83746-001

DESIGN MANAGER: NORIKO TANAKA CHECKED BY: TOM CONNER

BUILDING EXTERIOR ELEVATIONS

SCALE: AS SHOWN SHEET NUMBER:

A202

WEST ELEVATION


Scale: 1/4" = 1'-0"


WINDOW SCHEDULE - "W"									
DESIGN ID	COUNT	DESCRIPTION	FURN. BY	INST. BY	COMMENTS				
WINDOW			·	•					
10889	1	WINDOW - DT WITH TRANSOM - 48X60IN	LL	LL	USE IN CONJUNCTION WITH AA100				


	EXTERIOR DOOR SCHEDULE - "D"										
DESIGN ID	COUNT	DESCRIPTION	WIDTH	HEIGHT		HARDWARE TYPE	FRAME MATERIAL	FURNISHED BY	INSTALLED BY	COMMENTS	
DOOR							•				
10205	1	DOOR - STOREFRONT METAL FRAME SINGLE - TYPE B	3' - 0"	7' - 0"	В	2	ALUM	LL	LL		
10449	1	DOOR - STOREFRONT METAL FRAME DOUBLE - TYPE A	6' - 0"	7' - 0"	А	1	ALUM	LL	LL		
X10190	1	DOOR - HM SINGLE FLUSH - 42IN	3' - 6"	7' - 0"	E	3	НМ	LL	LL	MIN. R-VALUE 1.4 & PER NFRC 400 AIR LEAKAGE 0.4 CFM PER SF MAX.	


	INTERIOR DOOR SCHEDULE - "D"										
DESIGN ID	COUNT	DESCRIPTION	WIDTH	HEIGHT	DOOR TYPE	HARDWARE TYPE	FRAME MATERIAL	FURNISHED BY	INSTALLED BY	COMMENTS	
DOOR											
10190	2	DOOR - SINGLE FLUSH - 36IN	3' - 0"	7' - 0"	Е	5	HM	GC	GC		
X10086	1	DOOR - SINGLE IMPACT DOUBLE ACTING - 36IN 915MM	3' - 0"	7' - 0"	F	4	НМ	GC	GC	ORDER WITH DEADBOLT, SPECIFY WILSONART LAMINATE #4856 "CLOUD ZEPHYR"	

DOOR LEGEND

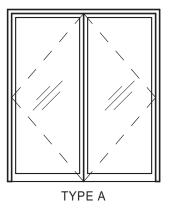

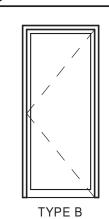

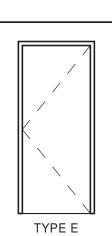

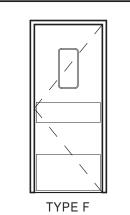

No.	Item	Description	Manufacturer	Finish
6	Hanging Devices	TH2314/MPB91	McKinney	630
1	Securing Devices (active leaf)	MS1850S Deadbolt	Adams RIte	626
1	Securing Devices (inactive leaf)	MS1880 Two-Point Flushbolt	Adams Rite	626
2	Securing Devices (active leaf)	C607 7-Pin Core Combinated "A" Keyway	Falcon Lock	626
1	Securing Devices (active leaf)	KB609-2 Cut Control Key "A" Keyway	Falcon Lock	
9	Securing Devices (active leaf)	KB632-2 Cut User Key "A" Keyway	Falcon Lock	
2	Securing Devices (active leaf)	C987 7-Pin Mortise Cylinder Housing w/AR Cam	Falcon Lock	626
2	Securing Devices (active leaf)	A08794-003 Adjustable Ring, Mortise Cyl. 5/16-13/32	Falcon Lock	626
2	Operating Trim	108 Door Pull Handle	Rockwood	630
2	Operating Trim	48 Push Bar x 31	Rockwood	630
2	Closing Devices	8916 Door Closer 8916 AF89P AL	Dorma	689
2	Stops and Holders	473 Door Stop w/Hook	Rockwood	626
2	Accessories	Door Sweep 18062CNB36	Pemko	A
1	Threshold	325 Half Saddle Threshold	National Guard	
1	Accessories	Vinyl Sign: "THIS DOOR MUST REMAIN UNLOCKED WHEN BUILDING IS OCCUPIED"	Seton	

No.	Item	Description	Manufacturer	Finish			
3	Hanging Devices	TH2314/MPB91	McKinney	630			
1	Securing Devices	CD35A-NL-OP Panic Device	Von Duprin	628/630			
2	Securing Devices	C607 7-Pin Core Combinated "A" Keyway	Falcon Lock	626			
1	Securing Devices	KB609-2 Cut Control Key "A" Keyway	KB609-2 Cut Control Key "A" Keyway Falcon Lock				
9	Securing Devices	KB632-2 Cut User Key "A" Keyway Falcon Lock					
1	Securing Devices	C953 7-Pin Rim Cylinder Housing	Falcon Lock	626			
1	Securing Devices	C987 7-Pin Mortise Cylinder Housing w/AR Cam	Falcon Lock	626			
1	Securing Devices	A08794-003 Adjustable Ring, Mortise Cyl. 516-13/32	Falcon Lock	626			
1	Operating Trim	108 Door Pull Handle	Rockwood	630			
1	Closing Devices	8916 Door Closer 8916 AF89P	Dorma	689			
1	Stops and Holders	473 Door Stop w/ Hook Rockwood 626					
1	Threshold	325 Half Saddle Threshold	National Guard				
1	Exit Indicator	Vinyl Sign: "THIS DOOR MUST REMAIN UNLOCKED WHEN BUILDING IS OCCUPIED"	Seton				

No.	Item	Item Description		Finish			
3	Hanging Devices	TH2314/MPB91 Hinge MacPro Bearing 4.5 x 4.5	McKinney	630			
1	Securing Devices	C607 7-Pin Core Combinated "A" Keyway	C607 7-Pin Core Combinated "A" Keyway Falcon Lock 6				
1	Securing Devices	I/O 2000L-03IC Auto Locking Door Alarm, IC; No CTR Includes Mortise Cylinder	Sur-Lock				
1	Closing Devices	8916 Door Closer 8916 AF89P	Dorma	689			
1	Protective Trim Units	K1050 B4E Kickplate 8" x 40"	630				
1	Accessories 137NA Weather Strip 17.5' 42" x 84" National Guard A						
1	Accessories C607A Door Sweep 42" National Guard A						
1	Miscellaneous Items	DS/1000 Door Scope	Security Products	Silver			
1	Miscellaneous Items	MCV309NWHGL Door Bell	Nutone	As Selected			

DOOR HARDWARE SET NO. 4 - For workroom door at backbar								
No.	Item	Description	Manufacturer	Finish				
1	Traffic Door Package	SCP8 36" x 84" with deadbolt	Eliason	WILSONART LAMINATE #4856 "CLOUD ZEPHYR"				

No.	Item	Description	Manufacturer	Finish	
3	Hanging Items	TA2714/MPB79 MacPro Bearing 4.5 x 4.5	McKinney	626	
1	Securing Devices	PB5425LN Lock, Shallow Coin Turn, Privacy PB5425LN-693-497 1-3/4	Yale Lock	626	
1	Closing Devices	8916 Door Closer 8916 AF89P	689		
2	Protective Trim Units	K1050 B4E Kickplate 8" x 34" each side 32D Rockwood 630		630	
3	Accessories	GJ64 Rubber Silencer Glynn Johnson Gray			
1	Stops and Holders	473 Door Stop w/ Hook Rockwood 626			

GENERAL NOTES

- A. STARBUCKS VENDOR TO PROVIDE DOOR HARDWARE COMPONENTS. GC TO INSTALL.
- B. SEE SHEET A101 FOR TAGGED LOCATION OF EXTERIOR DOORS AND WINDOWS.
- C. EGRESS SHALL NOT PASS THROUGH KITCHENS, STORAGE ROOMS, CLOSETS OR SIMILAR SPACES. (1014.2)
- D. PANIC AND FIRE EXIT HARDWARE, WHERE INSTALLED ON DOORS IN THIS BUILDING SHALL SATISFY THE FOLLOWING
- a) THE ACTUATION PORTION OF THE RELEASING DEVICE SHALL EXTEND AT LEAST ONE-HALF OF THE DOOR LEAF WIDTH.
- b) THE MAXIMUM UNLATCHING FORCE DOES NOT EXCEED 15 POUNDS (6.8 KG).
- c) PIVOTED OR BALANCED DOORS SHALL BE OF THE PUSH-PAD TYPE WHERE PANIC HARDWARE IS REQUIRED AND THE PAD SHALL NOT EXTEND ACROSS MORE THAN ONE-HALF OF THE DOOR WIDTH, MEASURED FROM THE LATCH SIDE.
- d) PANIC HARDWARE LISTED IN ACCORDANCE WITH UL 305.
- e) FIRE EXIT HARDWARE LISTED IN ACCORDANCE WITH UL 10C AND UL 305.



© 2018 STARBUCKS COFFEE COMPANY

STARBUCKS[®] 2401 UTAH AVENUE SOUTH

SEATTLE, WASHINGTON 98134 (206) 318-1575

ARE CONFIDENTIAL AND SHALL REMAIN THE SOLE PROPERTY OF STARBUCKS CORPORATION, WHICH IS THE OWNER OF THE COPYRIGHT IN THIS WORK. THEY SHALL NOT BE REPRODUCED (IN WHOLE OR IN PART), SHARED WITH THIRD PARTIES OR USED IN ANY MANNER ON OTHER PROJECTS OR EXTENSIONS TO THIS PROJECT WITHOUT THE PRIOR WRITTEN CONSENT OF STARBUCKS

THESE DRAWINGS AND THE PROJECT MANUAL


CORPORATION. THESE DRAWINGS AND SPECIFICATIONS ARE INTENDED TO EXPRESS DESIGN INTENT FOR A PROTOTYPICAL STARBUCKS STORE (WHICH IS SUBJECT TO CHANGE AT ANYTIME) AND DO NOT REFLECT ACTUAL SITE CONDITIONS. NEITHER PARTY SHALL HAVE ANY OBLIGATION NOR LIABILITY TO THE OTHER (EXCEPT STATED ABOVE) UNTIL A WRITTEN AGREEMENT IS FULLY EXECUTED BY BOTH PARTIES.

STARBUCKS TEMPLATE VERSION i2019.05.31



520 SOUTH MAIN ST, SUITE 2531 AKRON, OH 44311 P: 330-572-2100 F: 330-572-2101

GPD PROJECT NO: 2019355.03

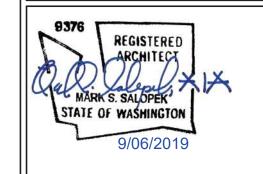

PROJECT ADDRESS:
2418 136TH COURT E
SUMNER, WA 98390

STORE #: 59603

PRO.

PROJECT #: 83746-001 SUBMITTAL 9.6.19 ISSUE DATE: DESIGN MANAGER:

NORIKO TANAKA PRODUCTION DESIGNER: GUY RIPLEY CHECKED BY: TOM CONNER

Revision Schedule

Rev	Date	Ву	Description

WINDOW AND DOOR SCHEDULES & DETAILS

SCALE: AS SHOWN SHEET NUMBER:


KEYED NOTES

- 1. INSTALL EXTERIOR FURNITURE THROUGHOUT AS
- 2. INSTALL CAFE FURNITURE THROUGHOUT AS SHOWN.
- 3. POWERED COMMUNITY TABLE. SEE FURNITURE SCHEDULE.
- 4. COMMUNITY BOARD. SEE INTERIOR FINISH ELEVATIONS.
- 5. CONDIMENT CART. SEE INTERIOR FINISH ELEVATIONS.
- 6. PLACE MERCHANDISE FIXTURES AND RETAIL FLOOR BASKETS PER PLAN. STORE OPERATORS TO ORDER RETAIL FLOOR BASKETS.
- 7. MANAGERS DESK. SEE MANAGER'S DESK/EQUIPMENT RACK ELECTRICAL DETAIL FOR ADDITIONAL INFORMATION.
- 8. DO NOT BLOCK FOOD CASE INTAKE/EXHAUST.
- 9. SAFE LOCATED AT POS CABINET. SEE ELECTRICAL FOR ADDITIONAL INFORMATION.
- 10. HAND SINK W/INTEGRAL SPLASH GUARD.
- 11. INSTALL CORNER GUARD AS INDICATED. SEE INTERIOR FINISH ELEVATIONS.
- 12. REFER TO ENLARGED RESTROOM PLANS AND ELEVATIONS (SHEET I401) FOR FIXTURE LOCATIONS AND MOUNTING HEIGHTŚ.
- 13 G.C. TO REVERSE HINGE ON U.C. REFRIGERATOR TO LEFT HAND SWING AS SHOWN.
- 14. SECURE LOCKERS TO WALL
- 15. VENDOR TO INSTALL WATER FILTRATION SYSTEM PER MANUFACTURER'S REQUIREMENTS. G.C. TO PROVIDE PLUMBING AND ELECTRICAL

- 17. MODULAR RAILING PROVIDED BY LL, SEE ARCHITECTURAL SITE PLAN.
- 18. PLACE FIRE EXTINGUISHER IN WORKROOM PER FIRE INSPECTORS REQUIREMENTS.
- 19. TRASH BIN.
- 20. ELECTRICAL PANELS.
- 21. REFER TO PENETRATION PLAN FOR FLOOR SINK LOCATION.


GENERAL NOTES

- A. GENERAL CONTRACTOR TO SCHEDULE WITH LOCAL REFRIGERATION CONTRACTOR TO CONDUCT INITIAL FOOD CASE START-UP AND TESTING. FOR LIST OF APPROVED START UP CONTRACTORS, CONTACT PROJECT CONSTRUCTION REPRESENTATIVE.
- B. THE SITE IS SERVED BY THE MUNICIPAL WATER AND SEWER SYSTEM UNLESS OTHERWISE NOTED.
- C. ALL FLOOR AND WALL JUNCTIONS IN STORAGE AND PREP. AREAS SHALL HAVE A 6" COVED BASE.
- D. ALL FOOD STORAGE SHALL BE 6" (150mm) A.F.F.
- E. ALL WOOD SURFACES (DOORS, TRIM, SHELVES. CABINETS) SHALL BE SEALED.
- F. FLOORS, WALLS AND CEILING FINISHES IN FOOD PREP. AREAS SHALL BE SMOOTH, NON-TOXIC, NON-ABSORBENT, DURABLE AND EASILY CLEANABLE. PAINT SHALL BE WASHABLE AND SEMI-GLOSS OR HIGH-GLOSS
- G. ALL EQUIPMENT AND INSTALLATION WILL MEET NATIONAL SANITATION FOUNDATION STANDARDS OR EQUIVALENT.
- H. ALL EQUIPMENT AND CABINETRY WILL BE FLUSH MOUNTED TO COUNTERS, WALLS OR FLOORS, OR BE RAISED TO ALLOW FOR CLEANING.
- I. CONFIRM ALL NECESSARY EQUIPMENT CLEARANCES PER PRODUCT CUT SHEET (E.G. ICE MACHINE).
- J. FOR LOCATION OF COUNTERTOP EQUIPMENT, REFER TO CASEWORK ELECTRICAL DETAILS.
- K. EQUIPMENT UNITS SHALL CONTAIN NO EXPOSED THREADS, EMBELLISHMENTS OR OVERHANGING EDGES THAT SERVE AS PLACES FOR ACCUMULATION OF DUST, DIRT AND DEBRIS.
- L. WARMING OVEN(S) SHOWN FOR PERMITTING PURPOSES. INSTALLATION AT STORE OPENING TO BE VERIFIED BY STARBUCKS CONSTRUCTION REPRESENTATIVE.
- M. EACH HAND WASHING SINK WILL HAVE A SINGLE SERVICE TOWEL AND SOAP DISPENSER, AND ALL HAND SINKS TO HAVE A COMBINATION FAUCET OR PREMIXING FAUCET.
- N. FOR PLUMBING FIXTURES, REFER TO THE PLUMBING DESIGN PLAN. FOR DATA DEVICE SCHEDULE, REFER TO THE ELECTRICAL DESIGN PLAN.
- O. SEE ELEVATIONS FOR DISTRIBUTION OF CUP DISPENSERS.
- P. GENERAL CONTRACTOR TO COORDINATE NEWSPAPER FIXTURE ORDERING. CONTACT TRIAD MANUFACTURING BY EMAIL (starbuckscs@triadmfg.com) OR BY PHONE (314-381-5280 X1111) TO ARRANGE SHIPMENT OF THE FIXTURE. ALLOW (5) DAY LEAD-TIME.

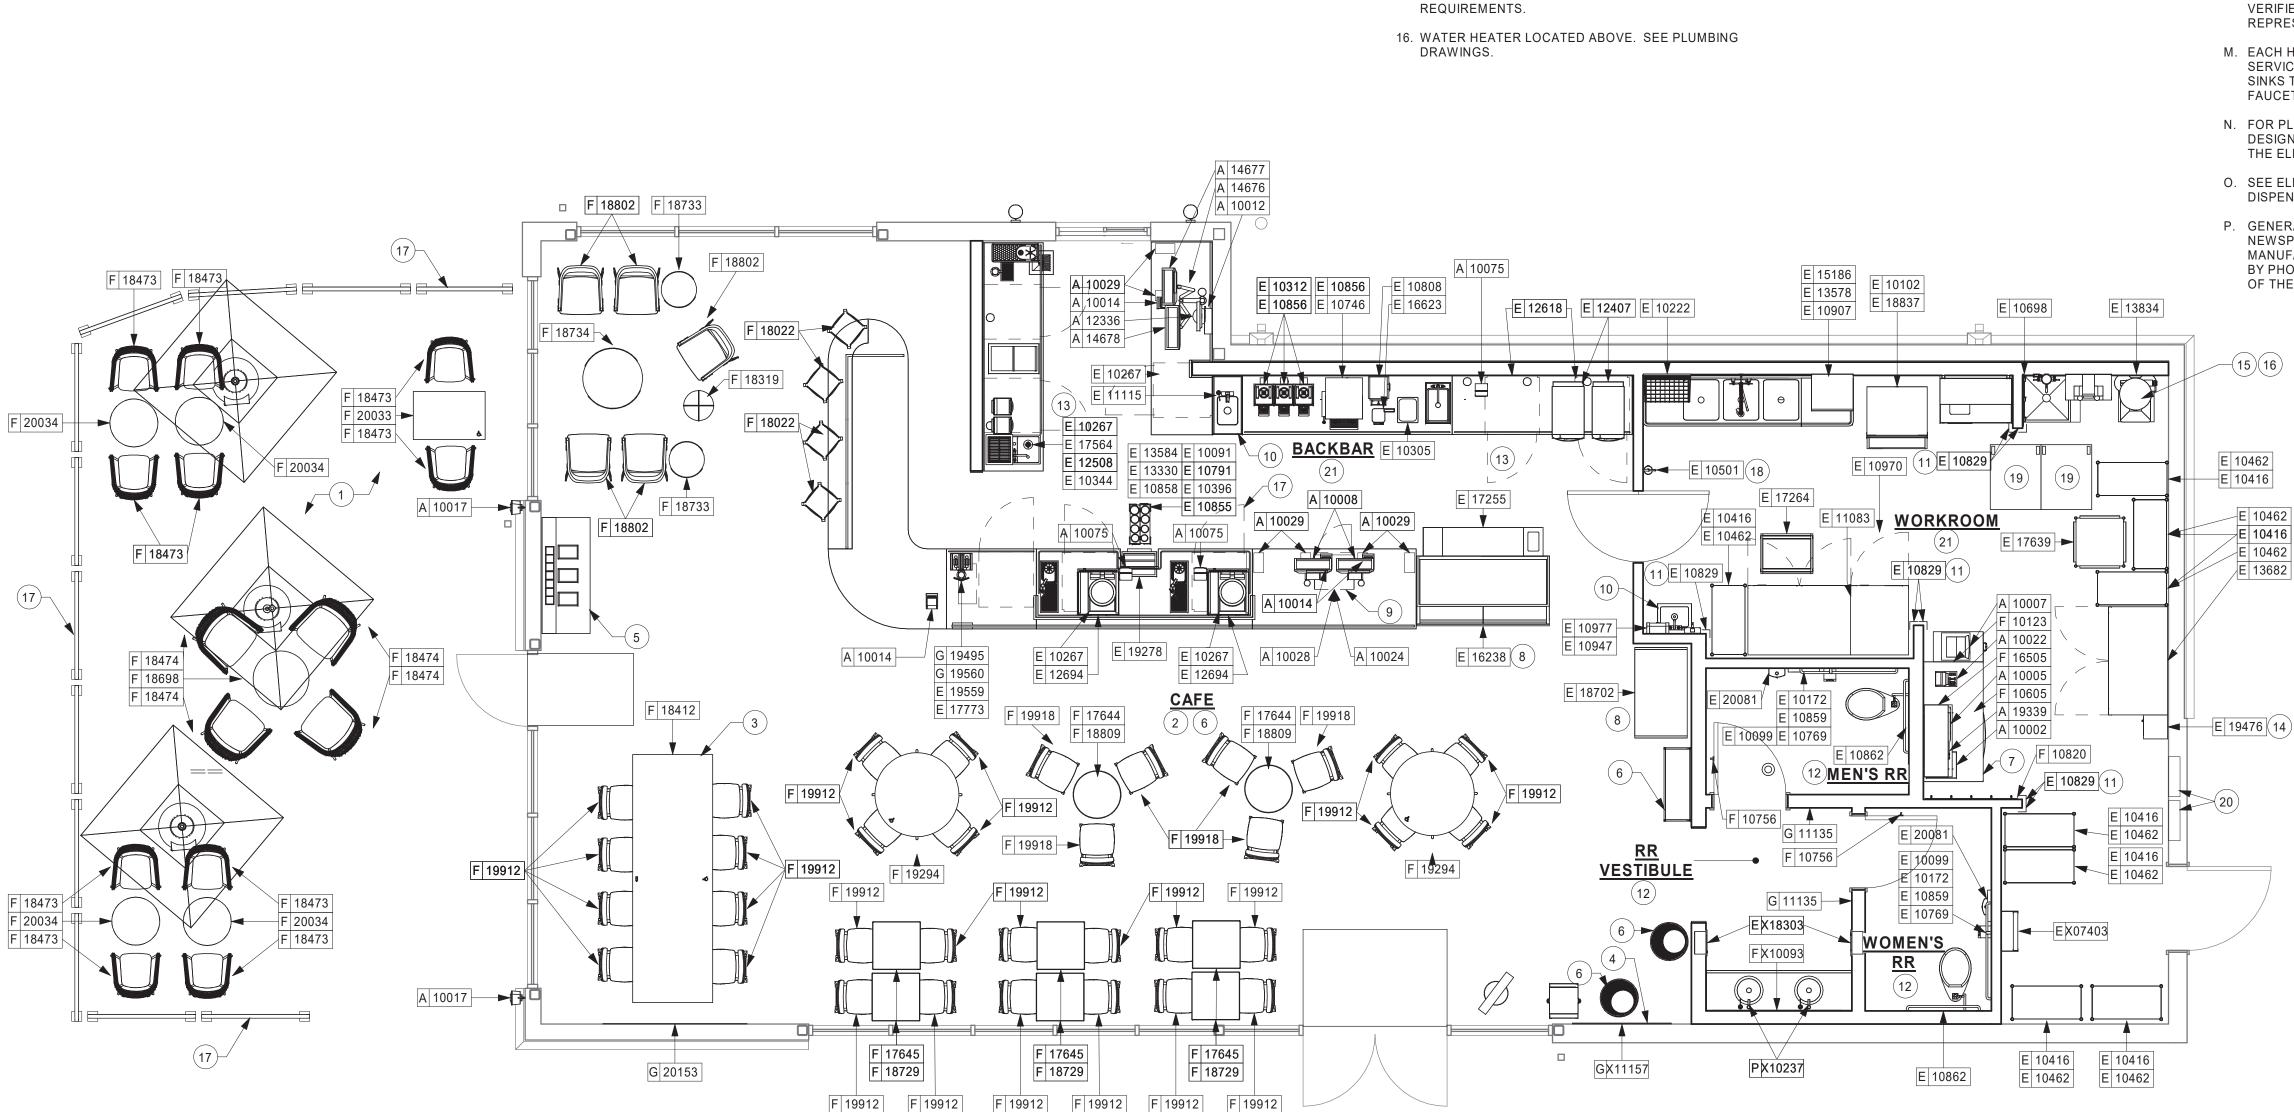

1 FURNITURE, FIXTURES, AND EQUIPMENT PLAN

| Scale: 1/4" = 1'-0"

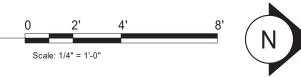



© 2018 STARBUCKS COFFEE COMPANY

STARBUCKS[®] 2401 UTAH AVENUE SOUTH

SEATTLE, WASHINGTON 98134 (206) 318-1575

THESE DRAWINGS AND THE PROJECT MANUAL ARE CONFIDENTIAL AND SHALL REMAIN THE SOLE PROPERTY OF STARBUCKS CORPORATION, WHICH IS THE OWNER OF THE COPYRIGHT IN THIS WORK. THEY SHALL NOT BE REPRODUCED (IN WHOLE OR IN PART), SHARED WITH THIRD PARTIES OR USED IN ANY MANNER ON OTHER PROJECTS OR EXTENSIONS TO THIS PROJECT WITHOUT THE

PRIOR WRITTEN CONSENT OF STARBUCKS CORPORATION. THESE DRAWINGS AND SPECIFICATIONS ARE INTENDED TO EXPRESS DESIGN INTENT FOR A PROTOTYPICAL STARBUCKS STORE (WHICH IS SUBJECT TO CHANGE AT ANYTIME) AND DO NOT REFLECT ACTUAL SITE CONDITIONS. NEITHER PARTY SHALL HAVE ANY OBLIGATION NOR LIABILITY TO THE OTHER (EXCEPT STATED ABOVE) UNTIL A WRITTEN AGREEMENT IS FULLY EXECUTED BY BOTH PARTIES.

STARBUCKS TEMPLATE VERSION i2019.05.31



520 SOUTH MAIN ST, SUITE 2531 AKRON, OH 44311 P: 330-572-2100 F: 330-572-2101

GPD PROJECT NO: 2019355.03



PROJECT ADDRESS:
2418 136TH COURT E
SUMNER, WA 98390

STORE #:

PROJECT #: 83746-001 ISSUE DATE: **DESIGN MANAGER:** NORIKO TANAKA

PRODUCTION DESIGNER: GUY RIPLEY


CHECKED BY: TOM CONNER **Revision Schedule**

Rev	Date	Ву	Description

SHEET TITLE: FF & E PLAN

SCALE: AS SHOWN

SHEET NUMBER:

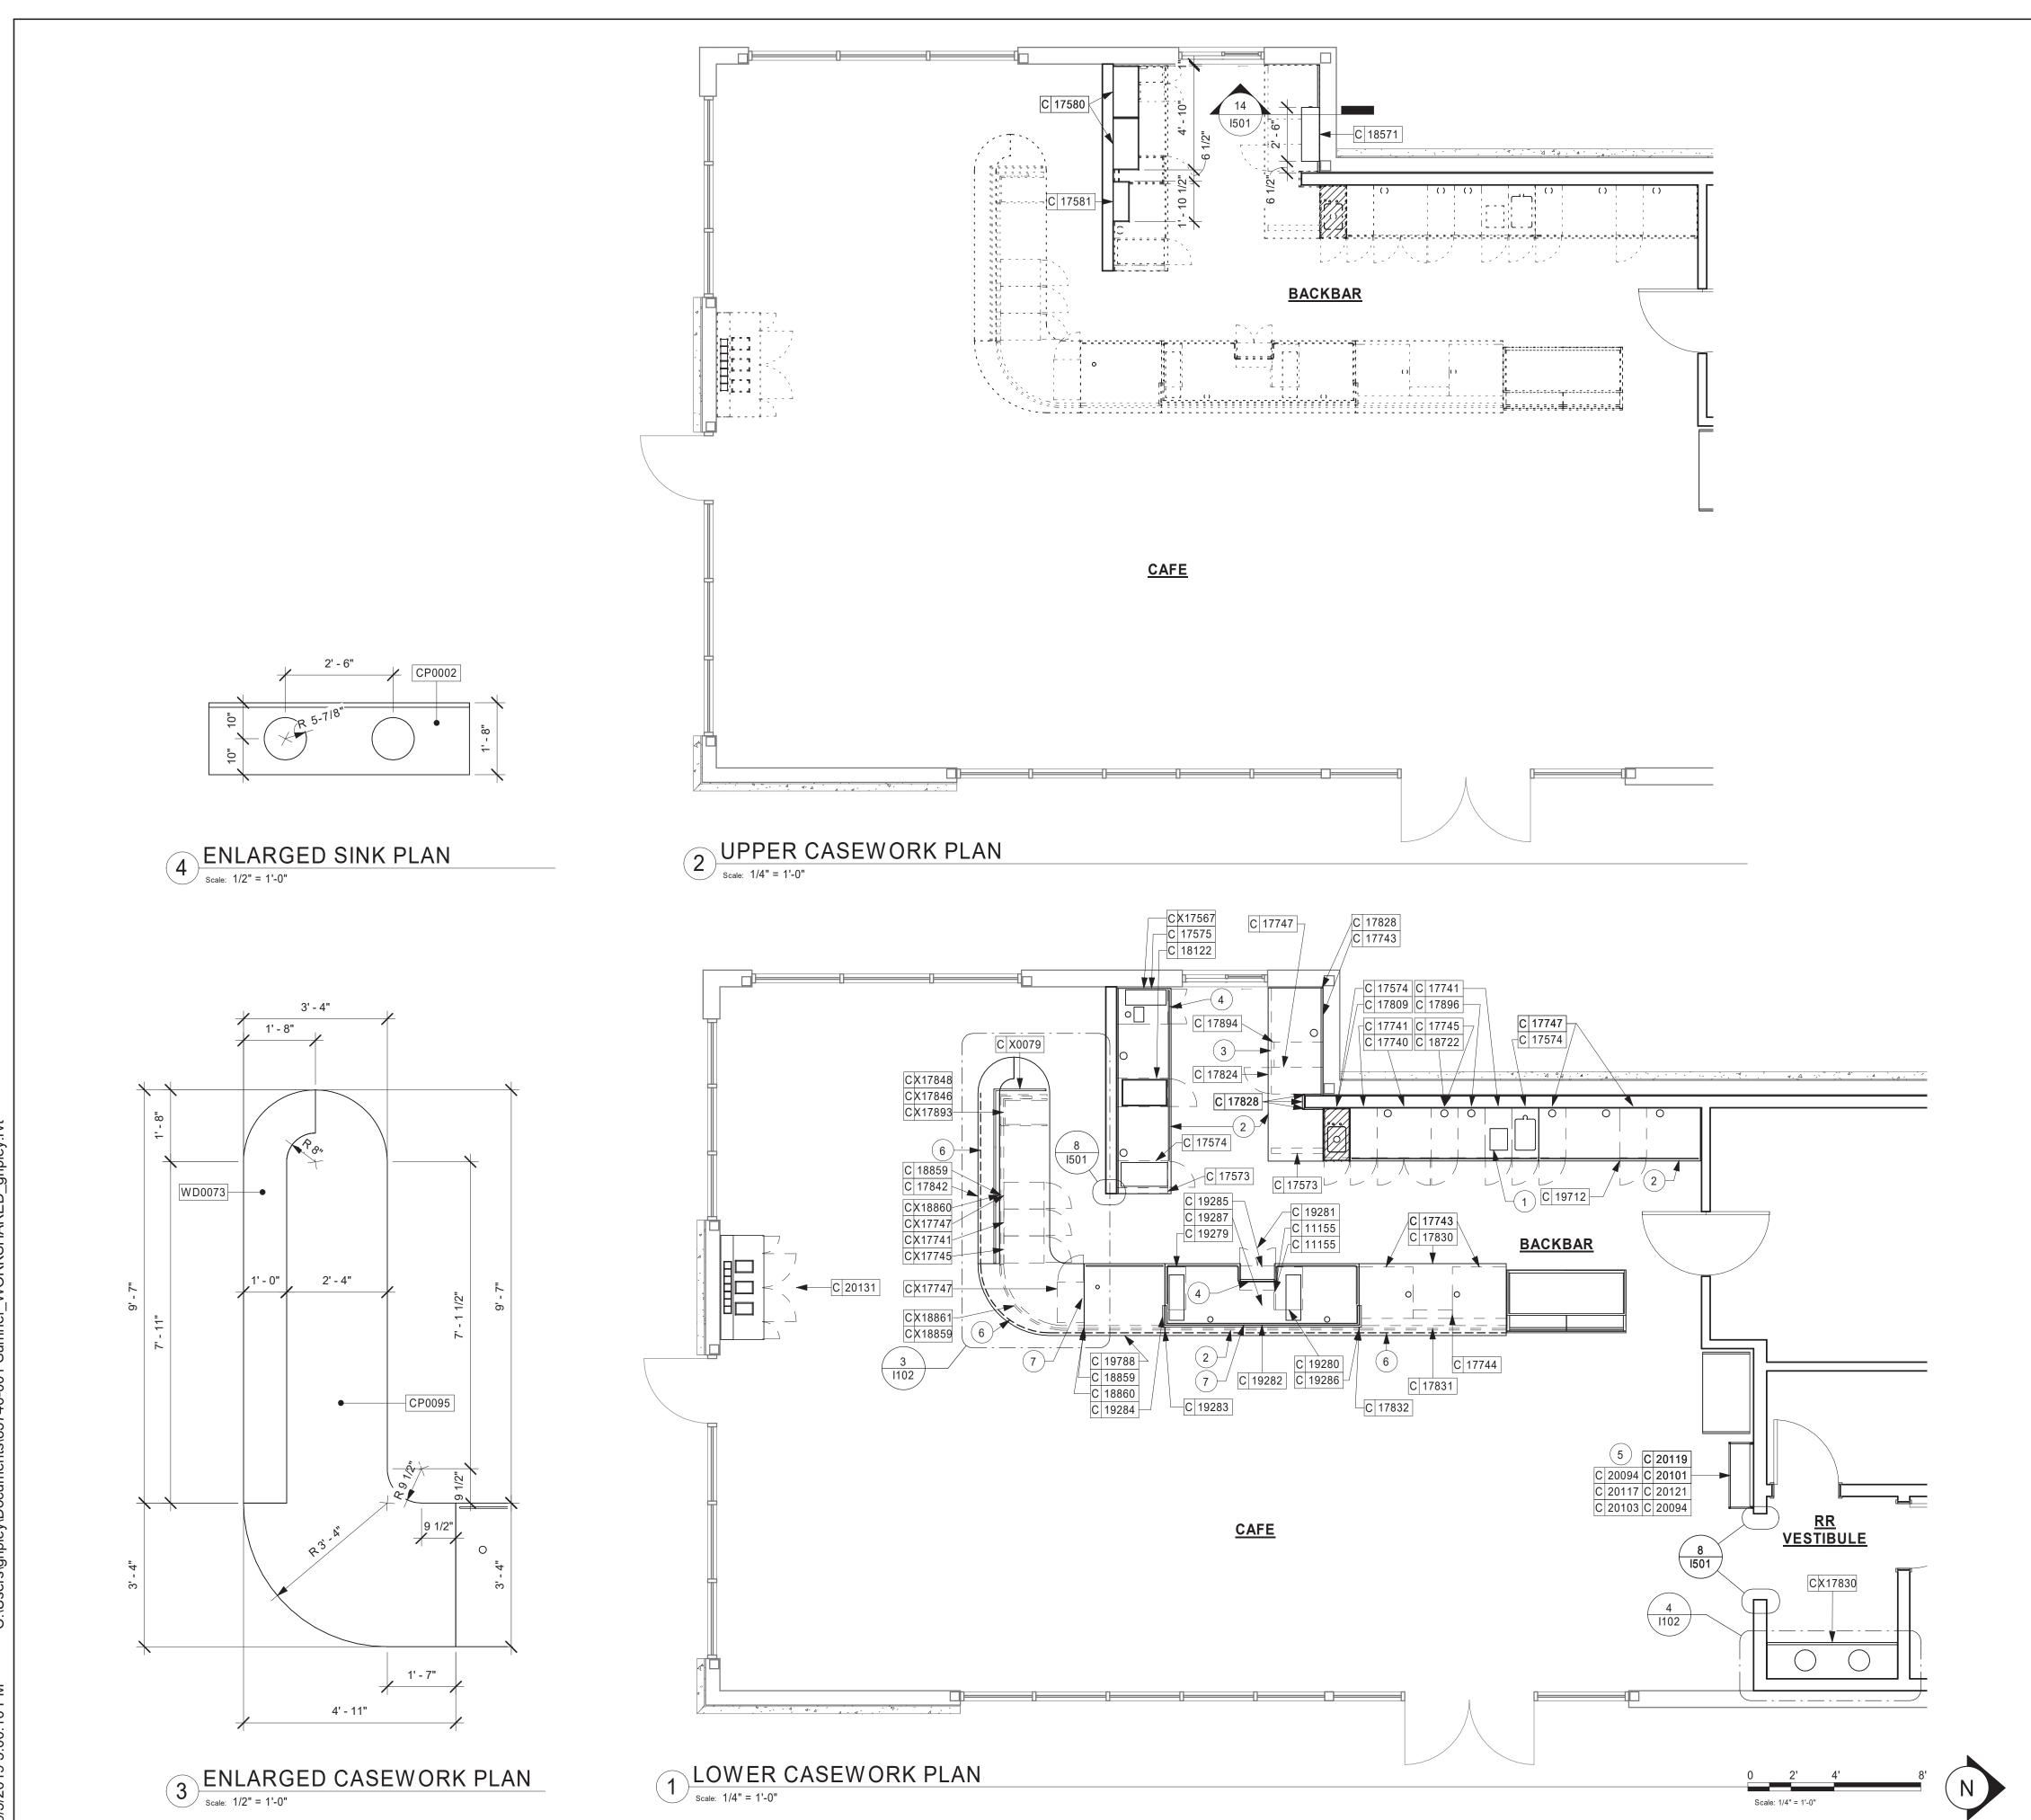

GENERAL NOTES

- A. GENERAL CONTRACTOR TO NOTIFY CONSTRUCTION MANAGER IMMEDIATELY IF A DISCREPANCY EXISTS BETWEEN CASEWORK SHOP DRAWINGS, EXITING SITE CONDITIONS, ARCHITECTURAL DRAWINGS OR BUILT FIXTURES. ALL DIMENSIONS SHALL BE FIELD VERIFIED BY GC PRIOR TO SHOP DRAWINGS PRODUCTION.
- B. STARBUCKS CONSTRUCTION MANAGER TO COORDINATE AND SCHEDULE CASEWORK DELIVERY DATE. GENERAL CONTRACTOR TO CONFIRM CASEWORK DELIVERY DATE WITH CASEWORK MANUFACTURER AT FOUR (4) WEEKS PRIOR AND THEN ONE (1) WEEK PRIOR TO SCHEDULED DATE OF DELIVERY.
- C. STARBUCKS CONTRACTS DIRECTLY WITH CASEWORK VENDOR TO SUPPLY CASEWORK LISTED IN THE CASEWORK SCHEDULE, UNLESS OTHERWISE NOTED.
- D. CASEWORK VENDOR TO PROVIDE COMPLETE SHOP DRAWINGS AND INSTALLATION PACKAGE TO GENERAL CONTRACTOR TO FACILITATE PROPER INSTALLATION.
- E. ALL CASEWORK BOX BASE / TOE KICKS SHALL BE SET AND LEVELED USING 1/4" (6 MM) NON-ABSORBENT PLASTIC SHIMS PROVIDED BY CASEWORK VENDOR.
- F. SEE WALL FINISH PLAN FOR LOCATION, TAGGING, AND FINISH SCHEDULES OF APPLIED WALL TREATMENTS.
- G. SEE REFLECTED CEILING PLAN FOR CASEWORK SOFFIT LOCATIONS.
- H. REFERENCE PLUMBING AND ELECTRICAL PLANS FOR PLACEMENT OF ELECTRICAL, DATA AND PLUMBING ON FRONT AND BACKLINE OF BAR.
- I. INSTALL CASEWORK, COUNTERTOPS, SHELVES, CUBBIES, FINISHES, TRIM AND TABLE TOPS THROUGHOUT. REFERENCE FINISH SCHEDULE AND MANUFACTURER'S SPECIFICATIONS FOR ADDITIONAL INFORMATION.
- J. ALL COUNTERTOPS UTILIZED FOR CUSTOMER TRANSACTIONS, INCLUDING BAR, CONDIMENT AND SALES COUNTERTOPS SHALL BE INSTALLED AT 2'-10" (860 MM) MAXIMUM A.F.F.
- K. WALL FINISH BEHIND EXPOSED CABINETRY AND BELOW UNDERSIDE OF COUNTERTOP SUBSTRATE TO BE FRP.

KEYED NOTES

- 1. DO NOT CAULK TRASH RINGS TO COUNTERTOPS.
- 2. CASEWORK VENDOR TO ENGINEER PROPER COUNTERTOP SUPPORT AT ESPRESSO BAR, SEATING COUNTER AND OTHER WORKSTATIONS PER STARBUCKS MINIMUM PERFORMANCE REQUIREMENTS.
- 3. VARIABLE WIDTH FILLER CABINET / COUNTERTOP REQUIRED TO FILL GAP (FIELD VERIFY DIMENSION). VENDOR TO COORDINATE EXACT DIMENSION WITH GC PRIOR TO INSTALLATION.
- 4. FLOOR DRAIN BELOW. CASEWORK MANUFACTURER TO COORDINATE DESIGN TO INSURE THIS AREA IS READILY ACCESSIBLE FOR CLEANING AND FREE OF COUNTERTOP SUPPORT.
- 5. 20364 WALL BAY 1 UNIT 236IN 915MM WHITE OAK WD0073. SEE DETAIL 9/I502.
- 6. UNDER COUNTER LED STRIP ALONG ENTIRE COUNTER TO ILLUMINATE FRONT BAR FACE PANEL.

INDICATES STAINLESS STEEL (SST) COUNTERTOP

INDICATES SOLID SURFACE (SS) COUNTERTOP

7. SNEEZE GUARD.

LEGEND

DATUM POINT

C 12345 CASEWORK TAG



STARBUCKS[®]

2401 UTAH AVENUE SOUTH SEATTLE, WASHINGTON 98134 (206) 318-1575

THESE DRAWINGS AND THE PROJECT MANUAL ARE CONFIDENTIAL AND SHALL REMAIN THE SOLE PROPERTY OF STARBUCKS CORPORATION, WHICH IS THE OWNER OF THE COPYRIGHT IN THIS WORK. THEY SHALL NOT BE REPRODUCED (IN WHOLE OR IN PART), SHARED WITH THIRD PARTIES OR USED IN ANY MANNER ON OTHER PROJECTS OR

EXTENSIONS TO THIS PROJECT WITHOUT THE PRIOR WRITTEN CONSENT OF STARBUCKS CORPORATION. THESE DRAWINGS AND SPECIFICATIONS ARE INTENDED TO EXPRESS DESIGN INTENT FOR A PROTOTYPICAL STARBUCKS STORE (WHICH IS SUBJECT TO CHANGE AT ANYTIME) AND DO NOT REFLECT ACTUAL SITE CONDITIONS. NEITHER PARTY SHALL HAVE ANY OBLIGATION NOR LIABILITY TO THE OTHER (EXCEPT STATED ABOVE) UNTIL A WRITTEN AGREEMENT IS FULLY EXECUTED BY


STARBUCKS TEMPLATE VERSION i2019.05.31

BOTH PARTIES.



520 SOUTH MAIN ST, SUITE 2531 AKRON, OH 44311 P: 330-572-2100 F: 330-572-2101

GPD PROJECT NO: 2019355.03

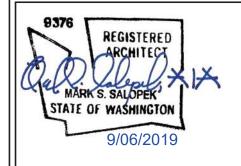

PROJECT ADDRESS:
2418 136TH COURT E
SUMNER, WA 98390

STORE #: 59603 PROJECT #: 83746-001 SUBMITTAL 9.6.19 ISSUE DATE:

DESIGN MANAGER: NORIKO TANAKA PRODUCTION DESIGNER: GUY RIPLEY TOM CONNER CHECKED BY:

Revision Schedule

CASEWORK PLAN

SCALE: AS SHOWN SHEET NUMBER:

I102

TROFFER

15057

C:\Users\gi
019 3:00:18 PM

			LIGHTING	3 FIXTURE	SCHEDULE - "L"	
DESIGN ID	COUNT	DESCRIPTION	FURN. BY	INST. BY	BULB	COMMENTS
ADDITIONAL	LIGHTING	EQUIP.	1	1		
CL2	1	CURRENT LIMITER FOR R SERIES TRACK - MINI END FEED COLOR TO MATCH TRACK	SB	GC		JUNO TCL2 2 AMP CURRENT LIMITER - WHITE
CL4	1	CURRENT LIMITER FOR R SERIES TRACK - MINI END FEED COLOR TO MATCH TRACK	SB	GC		JUNO TCL4 4 AMP CURRENT LIMITER - WHITE
EMS	1	VENSTAR EMS	SB	GC		SEE EMS SHEET FOR MORE INFORMATION
PP	1	100 WATT POWER PACK - VENDOR SPECIFIC	SB	GC		POWER PACK FOR LED STRIP LIGHTS
T/C	1	TIME CLOCK	SB	GC		TORK- T101R TIME CLOCK
CHANDELIE	:R		•	•		
X11280	1	BOWIE CHANDELIER WITH EXTRA LENGTH STEM	SB	GC		BY DOLAN HOSPITALITY - MODEL CH280-CR-BB-LG94. PROVIDE SPECS TO DM FOR PRODUCT CONFIRMATION AND STEM LENGTH PRIOR TO ORDERING.
EXIT						
11190	3	EXIT - EMERGENCY LIGHT - WHITE				LITHONIA #AFN
11483	1	EXIT - SECURITY LIGHT WALL MOUNTED	SB		HID 150W OR EQUAL	
11517	3	EMERGENCY EXIT LIGHT - BLACK	SB	GC	LED 5W LOW ENERGY OR EQUAL	JUNO #NXPC-3-G-BL
19056	6	EMERGENCY LIGHT DOUBLE - WHITE	SB	GC	LED 5W LOW ENERGY OR EQUAL	JUNO #N1WHHO
PENDANT						
X15701	3	EDISON 1-LIGHT PENDANT	SB	GC		BY DOLAN HOSPITALITY. PROVIDE SPECS TO DM FOR PRODUCT CONFIRMATION AND STEM LENGTH PRIOR TO ORDERING.
RECESSED	CAN					
19023	64	CAN - LED MOUNTING FRAME - 2IN 50MM - NEW CEILING	SB	GC		
19112	31	CAN - LED DOWNLIGHT CONE WITH DRIVER - 2IN 50MM - WHITE - 1000LM SPOT	SB	GC		DRIVER: JUNO #2LEDDRIVER-G2-10LM-120-FRPC TRIM: JUNO #2LEDTRIM-G2-ADJ-27K-90CRI-S-WWH
19113	27	CAN - LED DOWNLIGHT CONE WITH DRIVER - 2IN 50MM - WHITE - 1000LM NFL	SB	GC		DRIVER: JUNO #2LEDDRIVER-G2-10LM-120-FRPC TRIM: JUNO #2LEDTRIM-G2-ADJ-27K-90CRI-NFL-WWH
19120	6	CAN - LED DOWNLIGHT CONE WITH DRIVER - SQUARE - WHITE - 1000LM FLOOD	SB	GC		DRIVER: JUNO #2LEDDRIVER-G2-10LM-120-FRPC TRIM: JUNO #2LEDTRIM-G2-SQ-27K-90CRI-FL-WWH
SCONCE		1	1	1	ı	1
14354	8	SCONCE - MESH CYLINDER LARGE - BRONZE	SB		(1) LED 5W 2700K (INCLUDED) OR EQUAL	
STRIP			1	1	1	1
14409	1	STRIP - UNDER COUNTER LED TAPE IN HOUSING - VARIABLE LENGTH	SB	GC		UNDERCOUNTER LIGHTING AT CUSTOMER SIDE OF FRONTBAR DESIGN TO SPECIFY HOUSING COLOR; FIELD TRIMMABLE TO 6IN LENGTHS
TRACK			1	•		•
12934	5	TRACK - WITH CONNECTORS - 4FT 122CM - WHITE - 1 CIRCUIT	SB	GC		JUNO#R4WH
12945	2	TRACK - WITH CONNECTORS - 12FT 365CM - WHITE - 1	SB	GC		JUNO#R12WH

GE: LTCID A 1 10 FL 90 27 P Q J1 WHITE

JUNO #S2X4BL-39-35-U-WH-3

CEILING TREATMENT SCHEDULE - "U"								
DESIGN ID	AREA	DESCRIPTION	FURN. BY	INST. BY	COMMENTS			
OTHER			•					
11302	321 SF	ACT - WORKROOM - 2X4FT 61X122 CM	GC		WASHABLE VINYL FACED 2X4 GRID/ACT FOR BOH			
PAINT								
X06193	14 SF	SW6193 PRIVILEGE GREEN, OR EQUIVALENT	GC	GC				
X07042	992 SF	SW7042 SHOJI WHITE, OR EQUIVALENT	GC	GC				
PLASTIC								
11469	29 SF	FRP - WHITE	GC	GC				
		·	•	•				


LEGEND **ELEVATION DATUM** TRACK LIGHTING STRIP LIGHTING PENDANT LIGHT RECESSED CAN LIGHT

ADJUSTABLE RECESSED CAN LIGHT

TROFFER WALL SCONCE

EXIT SECURITY LIGHT

MUSIC SYSTEM SPEAKER

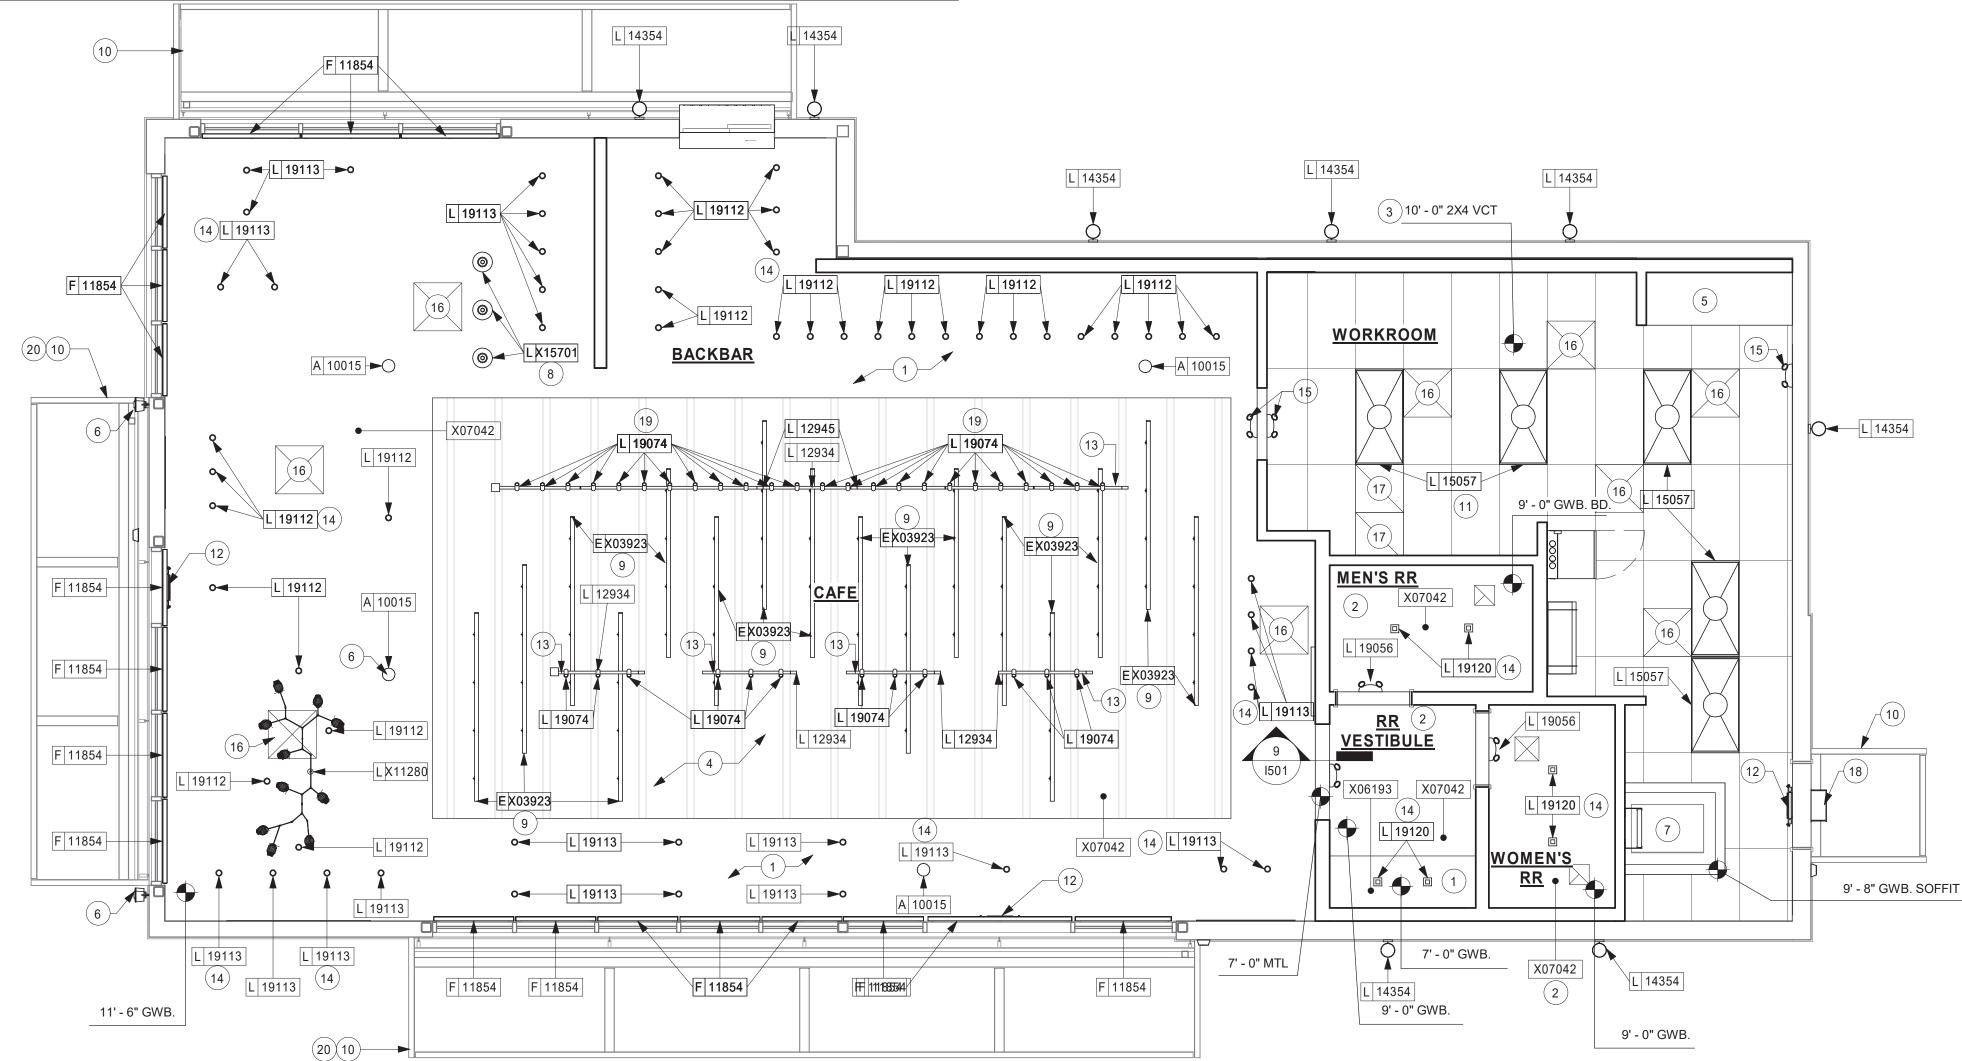

GENERAL NOTES

- A. IF REQUIRED BY LOCAL CODE, GENERAL CONTRACTOR TO PROVIDE SEMI-RECESSED SPRINKLER HEADS WITH POLISHED CHROME ESCUTCHEONS CENTERED IN ACOUSTICAL CEILING TILE. IF PENDANT HEADS ARE REQUIRED IN GWB SOFFIT OVER FRONTBAR, CONCEAL SUPPLY PIPING WITHIN SOFFIT. GENERAL CONTRACTOR TO SUBMIT SPRINKLER LAYOUT TO STARBUCKS' CONSTRUCTION MANAGER FOR APPROVAL PRIOR TO INSTALLATION.
- B. LEAVE TEN (10) ADDITIONAL RETAIL CEILING TILES TO MATCH RETAIL CEILING PAINT COLOR ABOVE THE WORKROOM CEILING AT MANAGER'S DESK FOR FUTURE
- C. PROVIDE GROMMET AT ACOUSTIC CEILING PENETRATIONS FOR FIXTURES OF SUPPORTS.
- D. HEATING, VENTILATING AND AIR CONDITIONING SHOWN ON THIS PLAN PROVIDED FOR REFERENCE ONLY. SEE MECHANICAL DRAWINGS FOR ADDITIONAL INFORMATION.
- E. DIFFUSERS AND RETURNS IN ACOUSTICAL CEILING TILE TO BE CENTERED IN TILE AND PAINTED TO MATCH ADJACENT FINISHES (TYP.).
- F. PAINT ALL EXPOSED HVAC DUCTS, HVAC DIFFUSERS, LIGHT TRIM RINGS, PIPING, CONDUIT AND JUNCTION BOXES THE SAME COLOR AS SPECIFIED ON SURROUNDING CEILING OR SOFFIT UNLESS OTHERWISE NOTED. TYPICAL THROUGHOUT RETAIL AREA OF STORE.
- G. PAINT SUBSTITUTIONS ARE NOT ALLOWED. USE STARBUCKS' NATIONAL ACCOUNT "COLOR CODE" WHEN ORDERING PAINTS.

KEYED NOTES

- 1. GWB SOFFIT WITH SMOOTH FINISH (PAINT AS SCHEDULED).
- 2. GWB CEILING. PAINT CEILING DIFFUSERS AS INDICATED.
- 3. WASHABLE CEILING TILE LOCATED IN BACK OF HOUSE AND ABOVE CAFE BAR (IF APPLICABLE).
- 4. OPEN TO STRUCTURE ABOVE. PAINT BOTTOM OF DECK
- 5. PLATFORM FOR HEATER AND WATER FILTRATION. PROVIDE SOFFIT AND LIFT CEILING THIS AREA ONLY TO
- INSURE ADEQUATE CLEARANCE FOR SERVICING. 6. MUSIC SPEAKER. INSTALL AT 9'-6" (3350MM) A.F.F. MIN.
- 7. ROOF LADDER AND ACCESS HATCH.


AND TRUSSES AS SCHEDULED.

- 8. PENDANT LIGHTING.
- 9. SOUND ABATEMENT BAFFLES. FINISH AS INDICATED.
- 10. EXTERIOR AWNINGS WITH METAL TIE-BACKS. SEE BUILDING EXTERIOR ELEVATIONS AND SCHEDULES FOR ADDITIONAL INFORMATION.
- 11. 2X4 LIGHT TROFFER, SEE ELECTRICAL, TYP.
- 12. EXIT LIGHTING, SEE ELECTRICAL.
- 13. TRACK LIGHTING FIXTURE, SEE INTERIOR ELEVATIONS FOR HEIGHTS. SEE ELECTRICAL FOR MORE INFORMATION, TYP.
- 14. RECESSED CAN LIGHT, SEE ELECTRICAL, TYP.
- 15. EMERGENCY LIGHT, SEE ELECTRICAL
- 16. SUPPLY DIFFUSER, SEE MECHANICAL, TYP
- 17. RETURN GRILLE, SEE MECHANICAL, TYP
- 18. EXTERIOR EMERGENCY LIGHT BY LL.
- 19. BOTTOM OF TRACK HEADS TO BE 11'-0"
- 20. LL TO PROVIDE CANOPY MOUNTED LIGHTING.

RESPONSIBILITY LEGEND

GC GENERAL CONTRACTOR

LL LANDLORD SB STARBUCKS

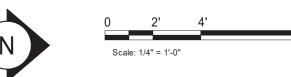



© 2018 STARBUCKS COFFEE COMPANY

STARBUCKS[®] 2401 UTAH AVENUE SOUTH

SEATTLE, WASHINGTON 98134 (206) 318-1575

THESE DRAWINGS AND THE PROJECT MANUAL ARE CONFIDENTIAL AND SHALL REMAIN THE SOLE PROPERTY OF STARBUCKS CORPORATION, WHICH IS THE OWNER OF THE

COPYRIGHT IN THIS WORK. THEY SHALL NOT BE REPRODUCED (IN WHOLE OR IN PART), SHARED WITH THIRD PARTIES OR USED IN ANY MANNER ON OTHER PROJECTS OR EXTENSIONS TO THIS PROJECT WITHOUT THE PRIOR WRITTEN CONSENT OF STARBUCKS CORPORATION. THESE DRAWINGS AND

SPECIFICATIONS ARE INTENDED TO EXPRESS DESIGN INTENT FOR A PROTOTYPICAL STARBUCKS STORE (WHICH IS SUBJECT TO CHANGE AT ANYTIME) AND DO NOT REFLECT ACTUAL SITE CONDITIONS. NEITHER PARTY SHALL HAVE ANY OBLIGATION NOR LIABILITY TO THE OTHER (EXCEPT STATED ABOVE) UNTIL A WRITTEN AGREEMENT IS FULLY EXECUTED BY BOTH PARTIES.

STARBUCKS TEMPLATE VERSION i2019.05.31



520 SOUTH MAIN ST, SUITE 2531 AKRON, OH 44311 P: 330-572-2100 F: 330-572-2101

GPD PROJECT NO: 2019355.03

REGISTERED MARK S. SALOPEK

STATE OF WASHINGTON

OURT | SS ADDRES 6TH (R, W PROJECT A 2418 136 SUMNER

STORE #: 59603 PROJECT #: 83746-001

SUBMITTAL 9.6.19 ISSUE DATE: DESIGN MANAGER: NORIKO TANAKA PRODUCTION DESIGNER: GUY RIPLEY

00

CHECKED BY:

Revision Schedule

TOM CONNER

Rev Date Description

REFLECTED CEILING PLAN

SCALE: AS SHOWN SHEET NUMBER:


I103

REFLECTED CEILING PLAN Scale: 1/4" = 1'-0"

36 TRACK - LED FIXTURE - 2IN 50MM - WHITE - 900LM

WHITE - 3900LM

TROFFER - LED RECESSED - 24X48IN 600X1200MM - SB

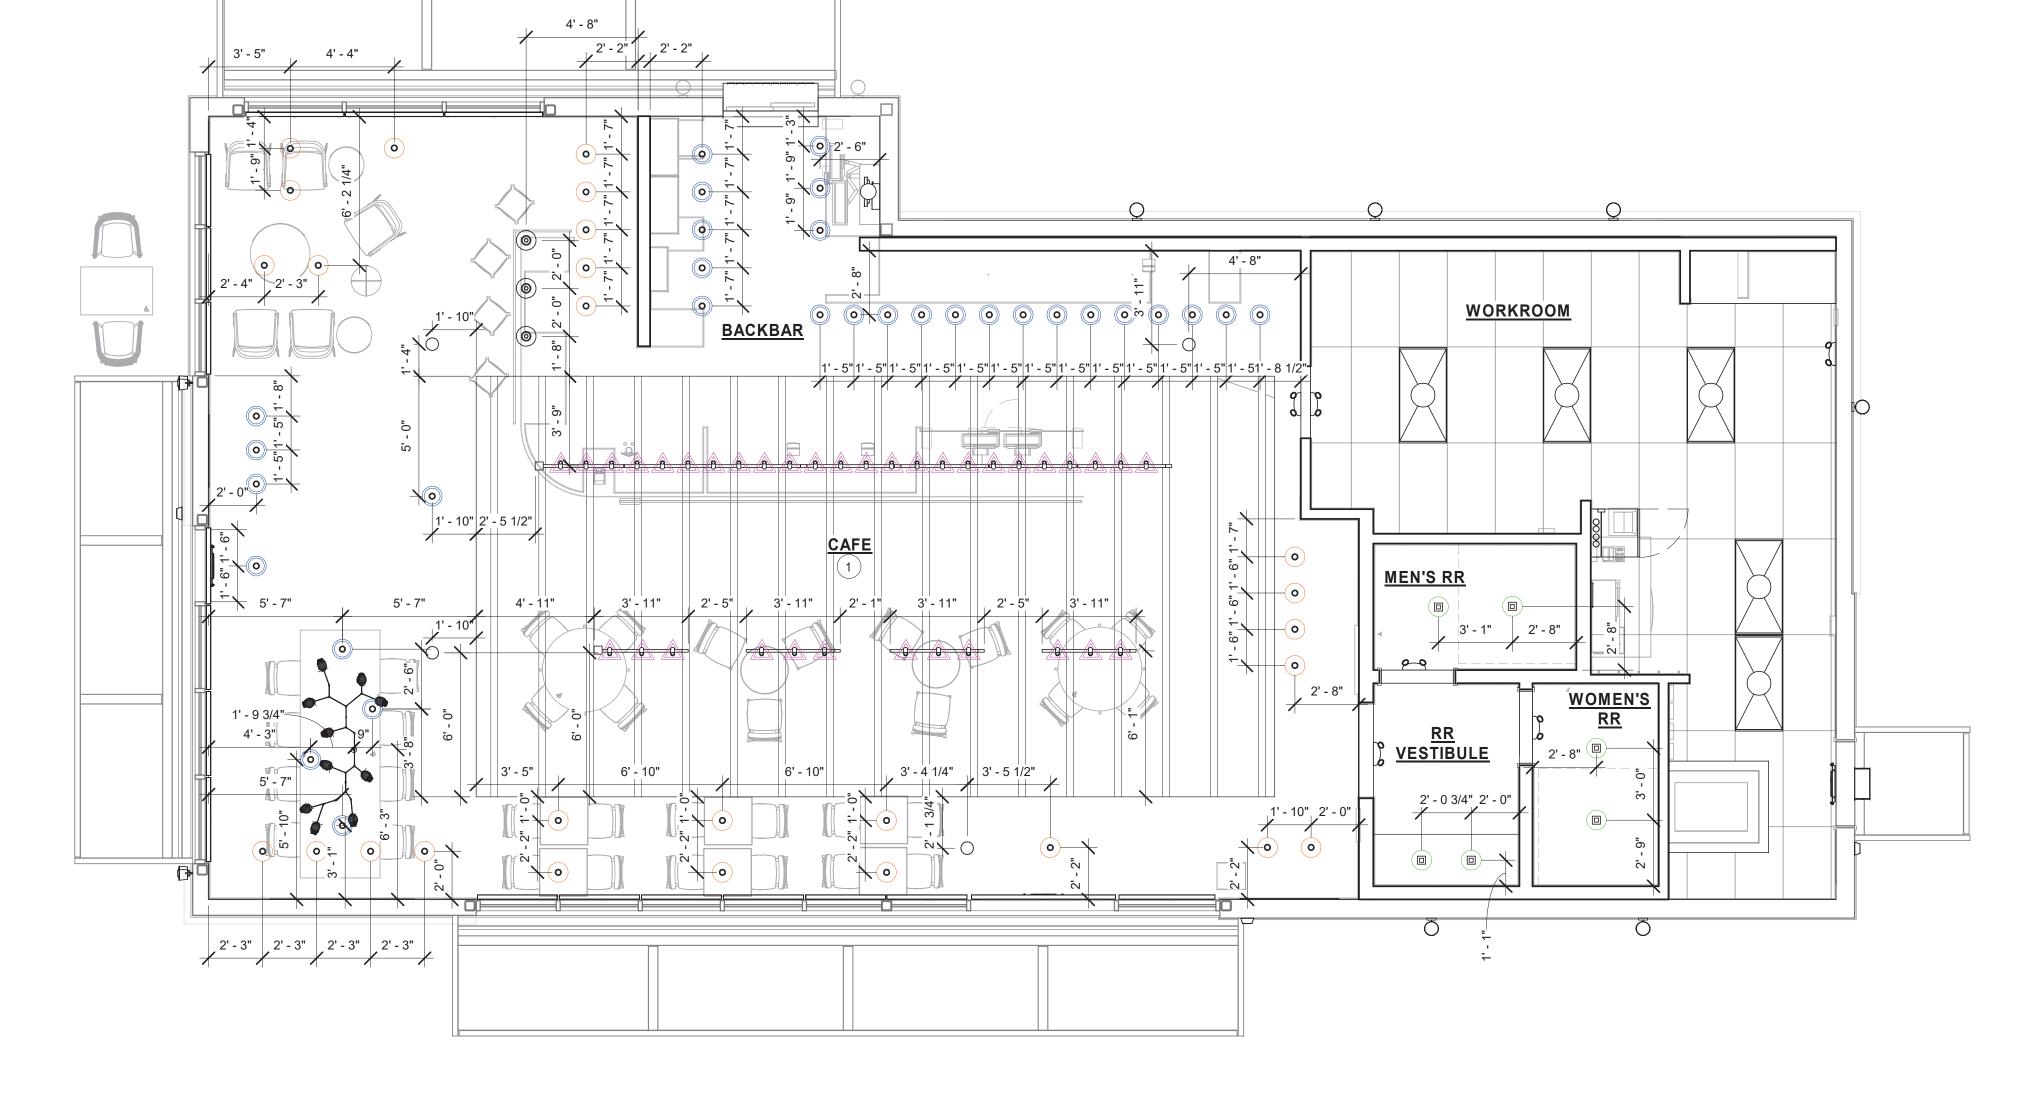

LIGHTING PLAN NOTES

- A. IF REQUIRED BY LOCAL CODE, GENERAL CONTRACTOR TO PROVIDE SEMI-RECESSED SPRINKLER HEADS WITH POLISHED CHROME ESCUTCHEONS CENTERED IN ACOUSTICAL CEILING TILE. IF PENDANT HEADS ARE REQUIRED IN GYPSUM SOFFIT OVER FRONTBAR, CONCEAL SUPPLY PIPING WITHIN SOFFIT. GENERAL CONTRACTOR TO SUBMIT SPRINKLER LAYOUT TO STARBUCKS' CONSTRUCTION MANAGER FOR APPROVAL PRIOR TO INSTALLATION.
- B. GENERAL CONTRACTOR TO PROVIDE AND LOCATE SPRINKLERS PER LOCAL CODES. CONTACT STARBUCKS CONSTRUCTION MANAGER IF DESIGN INTENT IS AFFECTED.
- C. WHERE ACOUSTICAL CEILING MEETS WALL, PROVIDE ANGLE WALL MOLDING FOR REVEAL. MATCH CEILING GRID COLOR WHEN APPLICABLE.
- D. LEAVE (10) ADDITIONAL RETAIL CEILING TILES, TO MATCH RETAIL CEILING PAINT COLOR, ABOVE THE WORKROOM CEILING AT MANAGER'S DESK FOR FUTURE USE.
- E. PROVIDE GROMMET AT ALL CEILING PENETRATIONS FOR FIXTURES OR SUPPORTS.
- F. HEATING, VENTILATING, AND AIR CONDITIONING (HVAC) SHOWN FOR DESIGN INTENT ONLY. CONTACT PROJECT MANAGER IF CHANGED.
- G. DIFFUSERS AND RETURNS AT BACKBAR IN ACOUSTICAL CEILING TILE TO BE CENTERED IN TILE, PAINTED TO MATCH ADJACENT FINISHES, TYPICAL.
- H. PAINT ALL EXPOSED HVAC DUCTS, HVAC DIFFUSERS, RECESSED SPEAKERS, LIGHT TRIM RINGS, PIPING. CONDUIT AND JUNCTION BOXES THE SAME COLOR AS SPECIFIED ON SURROUNDING CEILING OR SOFFIT UNLESS NOTED OTHERWISE. TYPICAL THROUGHOUT RETAIL AREA OF STORE.
- J. PAINT SUBSTITUTIONS ARE NOT ALLOWED. USE STARBUCKS' NATIONAL ACCOUNT "COLOR CODE" WHEN ORDERING PAINTS.
- K. SEE LIGHTING DESIGN PLAN FOR LIGHTING SCHEDULE, FIXTURE TYPES AND DIMENSIONED LOCATIONS.
- L. ADJUST EACH TRACK HEAD AT MENU BOARD LIGHTING SO LIGHT BEAMS ARE POINTING CONSISTENTLY, JUST BELOW THE CENTER OF EACH MENU BOARD PANEL.. ADJUST FOCUS OF ALL TRACK AND RECESSED DIRECTIONAL LIGHTING TO FULLY ILLUMINATE ALL ARTWORK, MENU BOARDS, AND MERCHANDISE BAYS.
- M. ALL FIXTURES IN FOOD PREPARATION AREA SHALL HAVE SHATTERPROOF LAMPS IF THE FIXTURE IS NOT LENSED.
- N. CENTER EMERGENCY/EXIT LIGHTS ABOVE DOORS, UON.

SHEET NOTES

1. EXPOSED STRUCTURE BEYOND. PAINT PER SHEET I103.

LIGHTING LEGEND

TRACK HEAD:
FLOOD (2" HOUSING DID 19074)

NARROW FLOOD (2" DID 19113)

CAN FIXTURE: SPOT (2", DID 19112)

CAN FIXTURE:

CAN FIXTURE: FLOOD (2" DID 19120)



© 2018 STARBUCKS COFFEE COMPANY

STARBUCKS[®] 2401 UTAH AVENUE SOUTH SEATTLE, WASHINGTON 98134

(206) 318-1575

THESE DRAWINGS AND THE PROJECT MANUAL ARE CONFIDENTIAL AND SHALL REMAIN THE SOLE PROPERTY OF STARBUCKS CORPORATION, WHICH IS THE OWNER OF THE COPYRIGHT IN THIS WORK. THEY SHALL NOT BE REPRODUCED (IN WHOLE OR IN PART), SHARED WITH THIRD PARTIES OR USED IN ANY MANNER ON OTHER PROJECTS OR

EXTENSIONS TO THIS PROJECT WITHOUT THE PRIOR WRITTEN CONSENT OF STARBUCKS CORPORATION. THESE DRAWINGS AND SPECIFICATIONS ARE INTENDED TO EXPRESS DESIGN INTENT FOR A PROTOTYPICAL STARBUCKS STORE (WHICH IS SUBJECT TO CHANGE AT ANYTIME) AND DO NOT REFLECT ACTUAL SITE CONDITIONS. NEITHER PARTY SHALL HAVE ANY OBLIGATION NOR LIABILITY TO THE OTHER (EXCEPT STATED ABOVE) UNTIL A WRITTEN AGREEMENT IS FULLY EXECUTED BY BOTH PARTIES.

STARBUCKS TEMPLATE VERSION i2019.05.31



520 SOUTH MAIN ST, SUITE 2531 AKRON, OH 44311 P: 330-572-2100 F: 330-572-2101

GPD PROJECT NO: 2019355.03



STORE #: 59603 PROJECT #: 83746-001 SUBMITTAL 9.6.19 ISSUE DATE:

DESIGN MANAGER: NORIKO TANAKA PRODUCTION DESIGNER: GUY RIPLEY CHECKED BY: TOM CONNER

Rev	Date	Ву	Description

LIGHTING PLAN

SCALE: AS SHOWN

SHEET NUMBER:

I103b

1 LIGHTING PLAN

scale: 1/4" = 1'-0"

WALL BASE SCHEDULE - "B"					
DESIGN ID	LENGTH	DESCRIPTION	FURN. BY	INST. BY	COMMENTS
STEEL BASE					
X1448	35' - 3"	FLAT BAR STEEL BASE, MT0028	SB	GC	PROVIDED BY PREMIER
TILE BASE					
19795	223' - 10 3/4"	POLYVINYL FLOOR TILE - ECOGRIP - PEWTER	SB	GC	
20229	125' - 10"	TILE BASE - I COCCI - GRAPHITE - 6X12IN 150X300MM	SB	GC	GROUT: MAPEI - 10 BLACK, OR EQUAL

CONCRETE FINISH NOTES

FINISHING PROCESS FOR CONCRETE SLAB

- INTEGRAL GRINDING WILL BEGIN AT A MINIMUM OF 36 HYBRID BOND DIAMOND GRIT. AFTER A UNIFORM SCRATCH PATTERN HAS BEEN DEVELOPED IN THE SURFACE OF THE CONCRETE: BEGIN GRINDING THE FLOOR UP TO A DIAMOND GRIT ACCEPTABLE FOR DENSIFING. LEVEL OF FINISH TO BE JOPEN AGGREGATE, SALT & PEPPER, LIGHT SAND]. GC TO HAND GRIND OR USE A STAND-UP EDGER FOR GRINDING/POLISHING EDGE AND INSIDE CORNER CONDITIONS. - CLEAN FLOOR WITH VEXCON CERTI-SHINE CLEAR DENSIFIER APPLIED IN MULTIPLE COATS.
- AFTER THE DENSIFIER HAS CURED, RINSE THE FLOOR WITH VEXCON CERTI-SHINE FIXATIVE, REMOVING UN-REACTED SILICATES FROM THE SURFACE OF THE CONCRETE AND IMPROVING THE CHEMICAL AND STAIN RESISTANCE OF THE POLISHED CONCRETE SYSTEM.
- ONCE THE RINSE HAS BEEN COMPLETED CONTINUE POLISHING THE FLOOR UP TO A 400 GRIT POLISH. - CLEAN FLOOR AGAIN AND APPLY A VEXCON CERTISHINE FINISH COAT ULTRA WB IN MULTIPLE COATS. ALLOWING FOR
- AFTER THE STAIN PROTECTANT HAS CURED, BURNISH THE FLOOR WITH A HIGH SPEED BUFFER.

POLISHING PROCEDURE

- ADHERE TO INDUSTRY STANDARD POLISHING PROCEDURES FOR DRY AND WET GRINDING/POLISHING IS ACCEPTABLE WHEN INDUSTRY STANDARD POLISHING PROCEDURES ARE ADHERED TO.
- SCRUB AND RINSE SLAB SURFACE WITH CLEAN WATER AND VACUUM WITH AUTO-SCRUBBER BETWEEN AND AFTER FINAL POLISHING PASSES.
- SEQUENTIAL PROGRESSION OF DIAMOND POLISHING STEPS SHALL BE REQUIRED AND LIMITED TO NO MORE THAN DOUBLE THE GRIT VALUE OF THE PREVIOUS DIAMONDS USED.
- PERFORM EACH PASS PERPENDICULAR TO THE OTHER PASS NORTH/SOUTH THEN EAST/WEST; MULTIPLE PASSES - PROGRESSIVELY GRIND AND POLISH THE SLAB SURFACE UTILIZING APPROVED DIAMOND SEGMENTS AS NECESSARY

TO PRODUCE FINISHING REQUIREMENTS. PREPARATION:

- OVERLAP ADJACENT POLISHING PASSES BY 25 PERCENT

- Clean dirt, dust, oil, grease and other contaminants that interfere with penetration or performance of specified product from
- surfaces. Use appropriate concrete cleaners approved by the concrete surface treatment manufacturer where necessary. Rinse thoroughly using pressure water spray to remove cleaner residues. Allow surfaces to dry completely before application of product.
- Repair, patch and fill cracks, voids, defects and damaged areas in surface as approved by the Architect. Allow repair materials to cure completely before application of product.
- Variations in substrate texture and color will affect final appearance and should be corrected prior to application of sealer/hardener system and the polishing steps.
- Protect surrounding areas prior to application of densifiers and stains. If products are accidentally misapplied to adjacent surfaces, flush with water immediately before material dries.
- Avoid contact in areas not to be treated. Avoid contact with metal, glass and painted surfaces.
- Apply specified sealants and caulking and allow complete curing before application of penetrating concrete hardener/densifier.
- Test surfaces with droplets of water. If water beads and does not penetrate surface, or penetrates only in some areas, profile surfaces by grinding, sanding, or abrasive blasting. Retest and continue profiling surface until water droplets immediately darken and uniformly penetrate concrete surfaces.

KEYED NOTES

- METAL BASE
- 2. FLOOR SINK LOCATION. SEE BUILDING FLOOR PENETRATION PLAN ON SHEET A102 AND PLUMBING FOR ADDITIONAL INFORMATION.
- 3. RECESSED ELECTRICAL. SEE BUILDING FLOOR PENETRATION PLAN ON SHEET A102 AND ELECTRICAL
- FOR ADDITIONAL INFORMATION. 4. RECESSED WALK-OFF MAT AT ENTRY. ALIGN EDGE OF
- WALKOFF MAT WITH EDGE OF JAMB. 5. MOP SINK WHERE INDICATED. SEE PLUMBING PLANS
- FOR MORE INFORMATION. 6. FRP BENEATH BACK BAR AT EXPOSED WALLS EXCEPT AT WARMING STATION. EXTEND FROM TOP OF WALL BASE
- 7. WALL TILE TO EXTEND BEHIND WARMING STATION TO TOP OF WALL BASE.
- 8. CONTINUE COVE BASE AROUND ALL LOWER CABINET BOX BASES WHERE APPLICABLE.

TO UNDERSIDE OF COUNTERTOP.

- 9. PLUMBING PENETRATION. SEE BUILDING FLOOR PENETRATION PLAN ON SHEET A102 AND PLUMBING SHEETS FOR ADDITIONAL INFORMATION.
- 10. ARTWORK THROUGHOUT, SEE INTERIOR ELEVATIONS. REFER TO MANUFACTURER'S INSTRUCTIONS SHOPPED
- 11. FULL HEIGHT FRP PANELING TO 6" ABOVE CEILING IN WORKROOM UNLESS NOTED OTHERWISE.
- 12. METAL FOOT REST SECURED TO FLOOR. SEE DETAILS 17/I501 AND 18/I501.



GENERAL NOTES

- A. WORKROOM TO BE FINISHED PER LOCAL CODE REQUIREMENTS.
- B. FLOORS, WALLS AND CEILING FINISHES IN FOOD PREPARATION AREAS SHALL BE SMOOTH, NON-TOXIC, NON-ABSORBENT, DURABLE AND EASILY CLEANABLE. PAINT SHALL BE WASHABLE; SEMI-GLOSS OR HIGH-GLOSS FINISH.
- C. STARBUCKS TO SUPPLY RETAIL FLOOR TILE AND TILE BASE. GENERAL CONTRACTOR TO INSTALL. GENERAL CONTRACTOR TO SUPPLY WORKROOM TILE AND BASE AND INSTALL. GENERAL CONTRACTOR TO SUPPLY AND INSTALL MORTAR, ADHESIVE, AND GROUT. GENERAL CONTRACTOR TO INSPECT ALL TILES AND REJECT DAMAGED OR SUBSTANDARD TILES PRIOR TO INSTALLATION.
- D. ALL FLOOR AND WALL JUNCTIONS IN STORAGE AND FOOD PREPARATION AREAS SHALL HAVE A 6" COVED



(C) 2018 STARBUCKS COFFEE COMPANY

STARBUCKS[®] 2401 UTAH AVENUE SOUTH SEATTLE. WASHINGTON 98134

(206) 318-1575

THESE DRAWINGS AND THE PROJECT MANUAL

ARE CONFIDENTIAL AND SHALL REMAIN THE SOLE PROPERTY OF STARBUCKS CORPORATION, WHICH IS THE OWNER OF THE COPYRIGHT IN THIS WORK. THEY SHALL NOT BE REPRODUCED (IN WHOLE OR IN PART), SHARED WITH THIRD PARTIES OR USED IN ANY MANNER ON OTHER PROJECTS OR EXTENSIONS TO THIS PROJECT WITHOUT THE PRIOR WRITTEN CONSENT OF STARBUCKS CORPORATION. THESE DRAWINGS AND SPECIFICATIONS ARE INTENDED TO EXPRESS DESIGN INTENT FOR A PROTOTYPICAL STARBUCKS STORE (WHICH IS SUBJECT TO CHANGE AT ANYTIME) AND DO NOT REFLECT ACTUAL SITE CONDITIONS. NEITHER PARTY SHALL HAVE ANY OBLIGATION NOR LIABILITY TO THE OTHER (EXCEPT STATED ABOVE) UNTIL A WRITTEN AGREEMENT IS FULLY EXECUTED BY

STARBUCKS TEMPLATE VERSION i2019.05.31


BOTH PARTIES.



520 SOUTH MAIN ST, SUITE 2531

AKRON, OH 44311 P: 330-572-2100 F: 330-572-2101

GPD PROJECT NO: 2019355.03

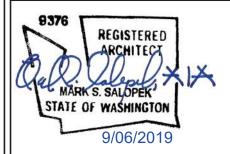

PROJECT ADDRESS 2418 136TH CSUMNER, WA

* SEE INTERIOR WALL FINISH ELEVATIONS FOR TAGGED

INDICATES BACKBAR WALL TILE AND

INDICATES STAINLESS STEEL CORNER GUARDS. INSTALL 6" TO 42"

INDICATES FULL HEIGHT METAL WALL

UNLESS OTHERWISE NOTED

END CAP (MT0011)

LOCATIONS OF WALL FINISH MATERIALS

LOCATIONS OF WALL FINISH MATERIAL

GC GENERAL CONTRACTOR

LL LANDLORD SB STARBUCKS

STORE #: PROJECT #: ISSUE DATE: DESIGN MANAGER:

0 0

PRODUCTION DESIGNER: GUY RIPLEY TOM CONNER CHECKED BY:

59603

83746-001

SUBMITTAL 9.6.19


NORIKO TANAKA

Revision Schedule

FINISH PLAN

SCALE: AS SHOWN


SHEET NUMBER:

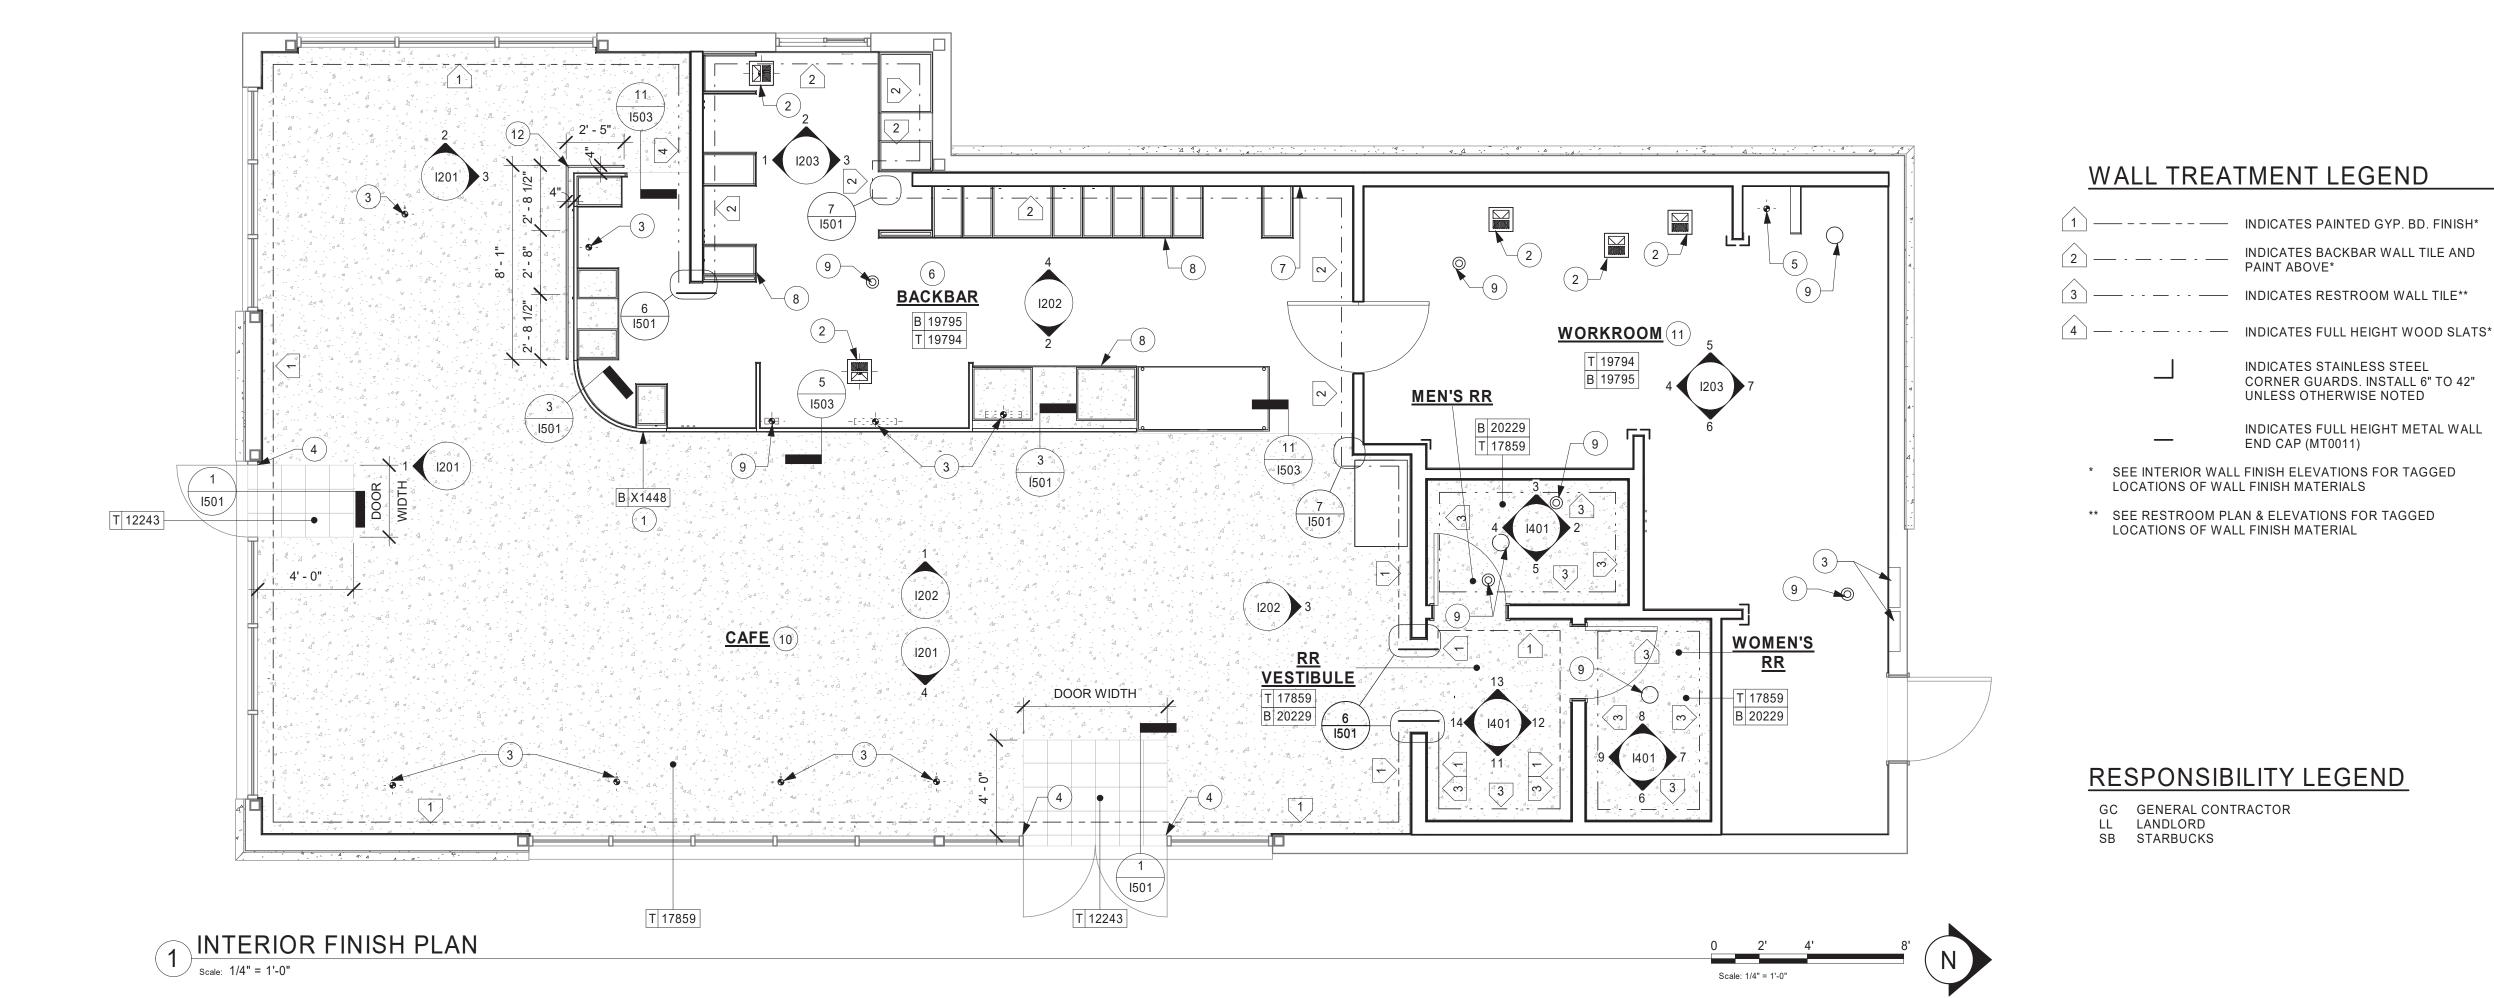



4 CAFE

scale: 3/8" = 1'-0"

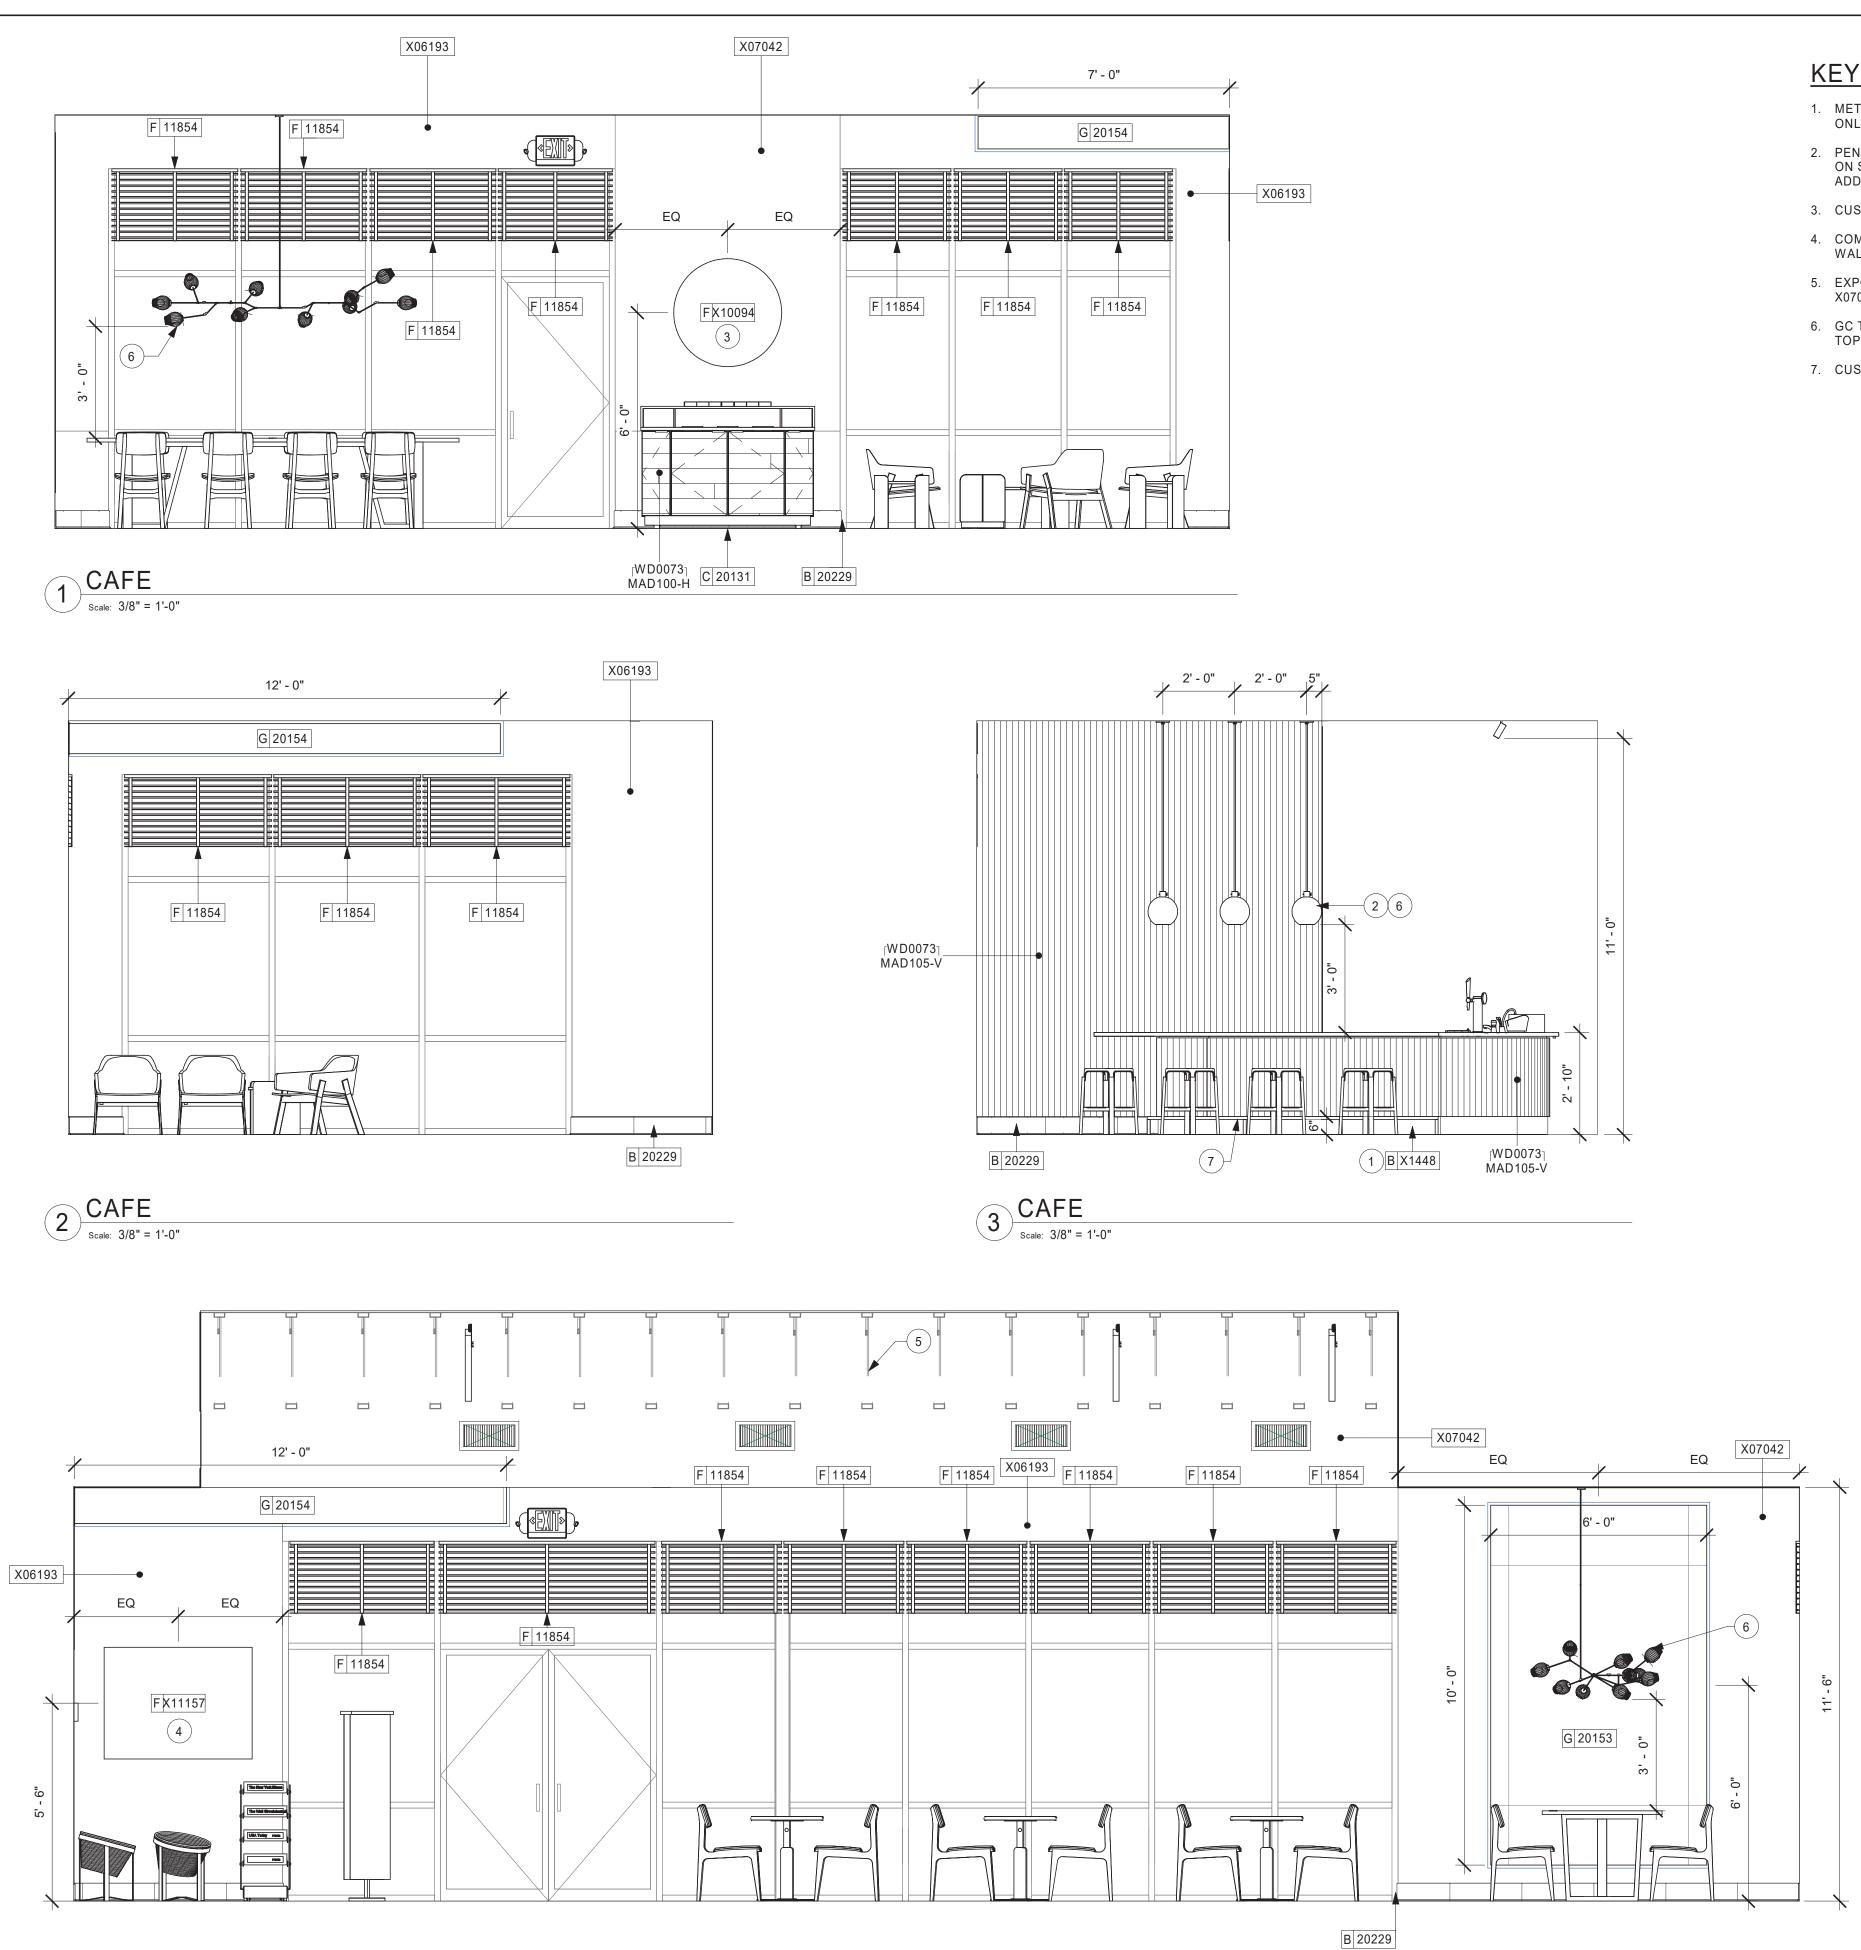

KEYED NOTES

- 1. METAL TILE BASE LOCATED AT FRONTBAR ON CAFE SIDE ONLY.
- PENDANT LIGHT FIXTURE (SEE REFLECTED CEILING PLAN ON SHEET I103 AND LIGHTING PLAN ON SHEET E103b FOR ADDITIONAL INFORMATION).
- 3. CUSTOM MIRROR TO BE CENTERED ON WALL.
- 4. COMMUNITY BOARD TO BE MOUNTED ON CENTER WITH
- 5. EXPOSED DUCTWORK, AND STRUCTURE TO BE PAINTED X07042.
- 6. GC TO ENSURE PENDANT LIGHTING MOUNTED 3'-0" FROM TOP OF TABLE SURFACE.
- CUSTOM FOOT RAIL.

Scale: 3/8" = 1'-0"

GENERAL NOTES

- A. FOR GRAPHICS SCHEDULE, REFER TO THE FURNITURE, FIXTURES, AND EQUIPMENT (FF & E) SCHEDULES ON SHEET 1601.
- B. REFER TO MANUFACTURER'S INSTRUCTIONS INCLUDED WITH ARTWORK/GRAPHICS FOR PROPER INSTALLATION.
- C. CHANGE PAINT COLOR ONLY AT INSIDE CORNERS UNLESS OTHERWISE INDICATED.
- D. PAINT FINISHES SHALL BE APPLIED AS FOLLOWS, UNLESS NOTED OTHERWISE:
- WOODS AND METAL SURFACES SHALL BE SEMI-GLOSS OR EQUAL.
 ACCENT AND TRIM PAINTS TO BE SEMI-GLOSS OR
- EQUAL.

 a. WALL AND CEILING PAINTS TO BE EGGSHELL OR
- 3) PAINTS IN BOH, RESTROOM(S) OR CAFE BAR SHALL BE SEMI-GLOSS OR EQUAL.
- E. PAINT SUBSTITUTIONS ARE NOT ALLOWED. USE STARBUCKS NATIONAL ACCOUNT COLOR CODE WHEN ORDERING PAINTS.
- F. FLOORS, WALLS AND CEILING FINISHES IN FOOD PREPARATION AREAS SHALL BE SMOOTH, NON-TOXIC, NON-ABSORBENT, DURABLE AND EASILY CLEANABLE. PAINT SHALL BE WASHABLE; SEMI-GLOSS OR HIGH GLOSS FINISH.
- G. ALL WOOD SURFACES (DOORS, TRIM, SHELVES, CABINETRY) SHALL BE SEALED.
- H. REFER TO CASEWORK FINISH SCHEDULE ON THE CASEWORK FINISH PLAN ON SHEET I102 FOR CASEWORK FINISH MATERIAL INFORMATION.
- I. ALIGN TILE TRANSITIONS ON WHOLE TILES AS SHOWN.
- J. ALL FLOOR AND WALL JUNCTIONS IN STORAGE AND FOOD PREPARATION AREAS SHALL HAVE A 6" COVED BASE
- K. ALL FOOD STORAGE SHALL BE 6" (150MM) A.F.F.
- L. INSTALL BLOCKING AND HANGERS FOR WALL SHELVING BEFORE INSTALLING BACK BAR TILE.
- M. GENERAL CONTRACTOR TO PROVIDE AND INSTALL WORKROOM WALL FINISHES.



© 2018 STARBUCKS COFFEE COMPANY

STARBUCKS®
2401 UTAH AVENUE SOUTH

SEATTLE, WASHINGTON 98134
(206) 318-1575

THESE DRAWINGS AND THE PROJECT MANUAL

ARE CONFIDENTIAL AND SHALL REMAIN THE
SOLE PROPERTY OF STARBUCKS
CORPORATION, WHICH IS THE OWNER OF THE
COPYRIGHT IN THIS WORK. THEY SHALL NOT
BE REPRODUCED (IN WHOLE OR IN PART),
SHARED WITH THIRD PARTIES OR USED IN ANY
MANNER ON OTHER PROJECTS OR
EXTENSIONS TO THIS PROJECT WITHOUT THE

PRIOR WRITTEN CONSENT OF STARBUCKS
CORPORATION. THESE DRAWINGS AND
SPECIFICATIONS ARE INTENDED TO EXPRESS
DESIGN INTENT FOR A PROTOTYPICAL
STARBUCKS STORE (WHICH IS SUBJECT TO
CHANGE AT ANYTIME) AND DO NOT REFLECT
ACTUAL SITE CONDITIONS. NEITHER PARTY
SHALL HAVE ANY OBLIGATION NOR LIABILITY TO
THE OTHER (EXCEPT STATED ABOVE) UNTIL A

BOTH PARTIES.

STARBUCKS TEMPLATE VERSION i2019.05.31


WRITTEN AGREEMENT IS FULLY EXECUTED BY



Professional Corporation

520 SOUTH MAIN ST, SUITE 2531
AKRON, OH 44311
P: 330-572-2100 F: 330-572-2101

GPD PROJECT NO: 2019355.03

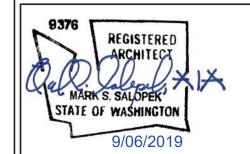

PROJECT NAME:

167/24TH - SUMNEF
PROJECT ADDRESS:
2418 136TH COURT EAST
SUMNER, WA 98390

STORE #: 59603 PROJECT #: 83746-001

DESIGN MANAGER: NORIKO TANAKA
PRODUCTION DESIGNER: GUY RIPLEY
CHECKED BY: TOM CONNER

Revision Schedule


By Descripti


SHEET TITLE:

INTERIOR FINISH ELEVATIONS SCALE: AS SHOWN

SHEET NUMBER:


1201

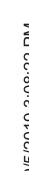

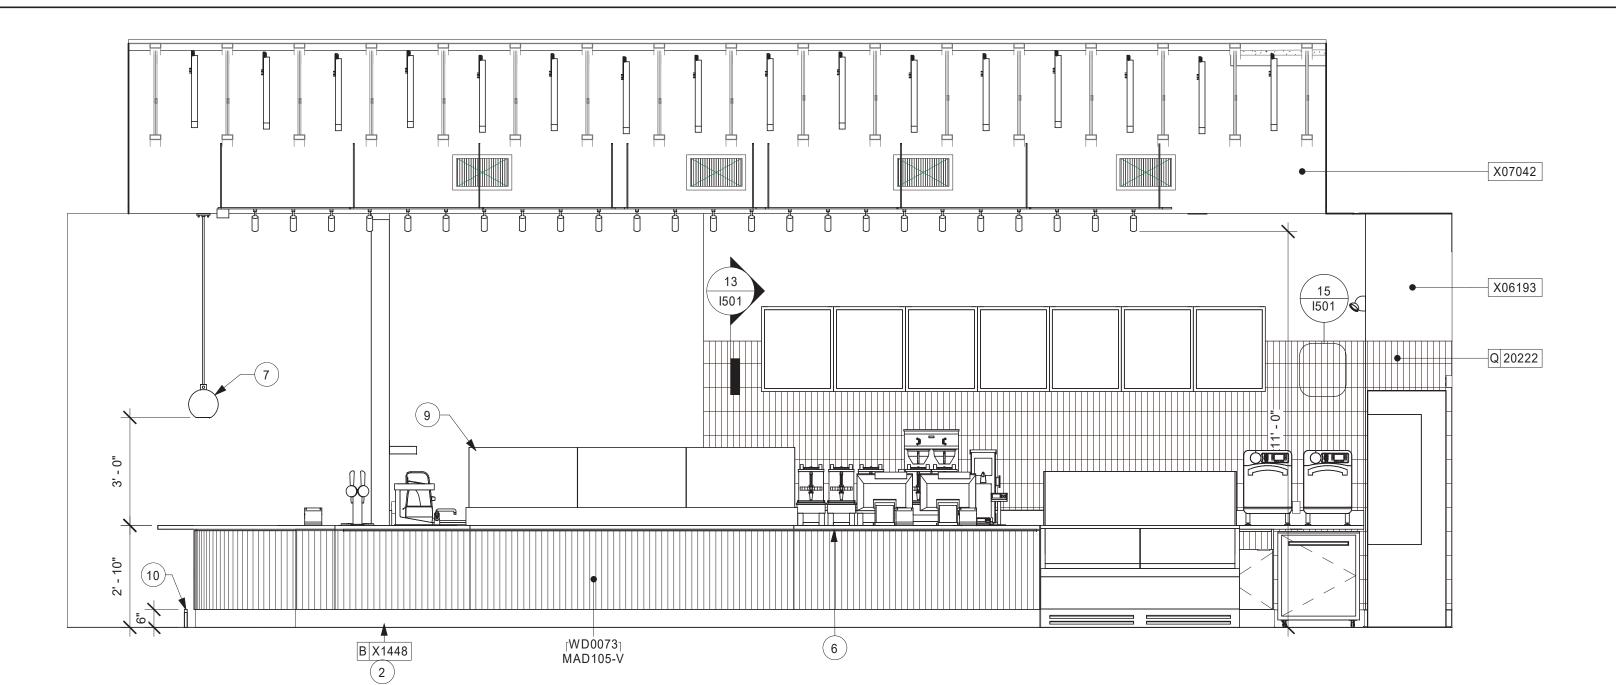



FRONTBAR - CAFE SIDE

Scale: 3/8" = 1'-0"

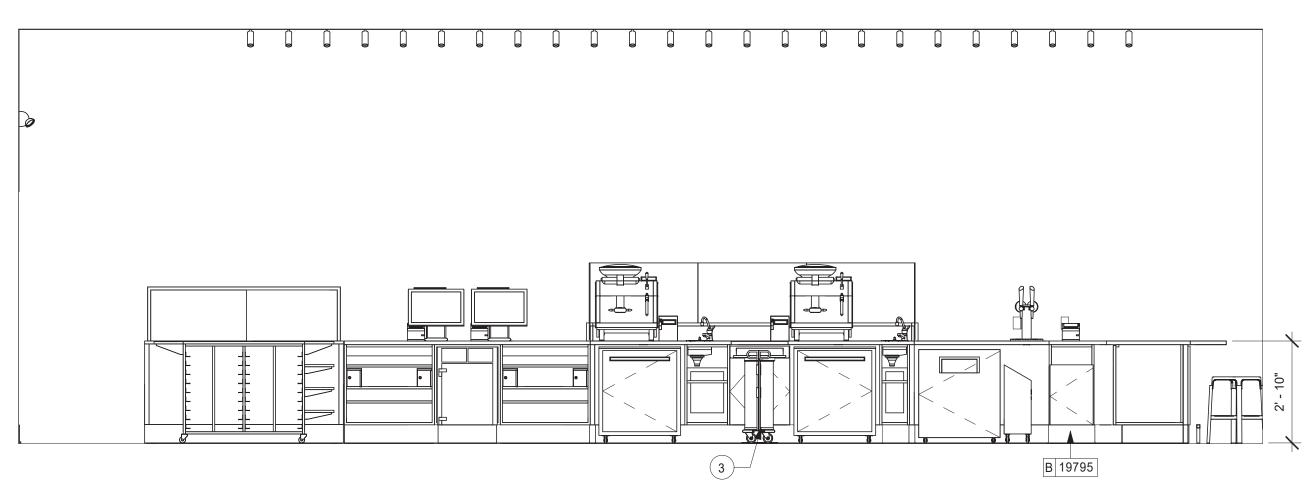

PRONTBAR - PARTNER SIDE | Scale: 3/8" = 1'-0"

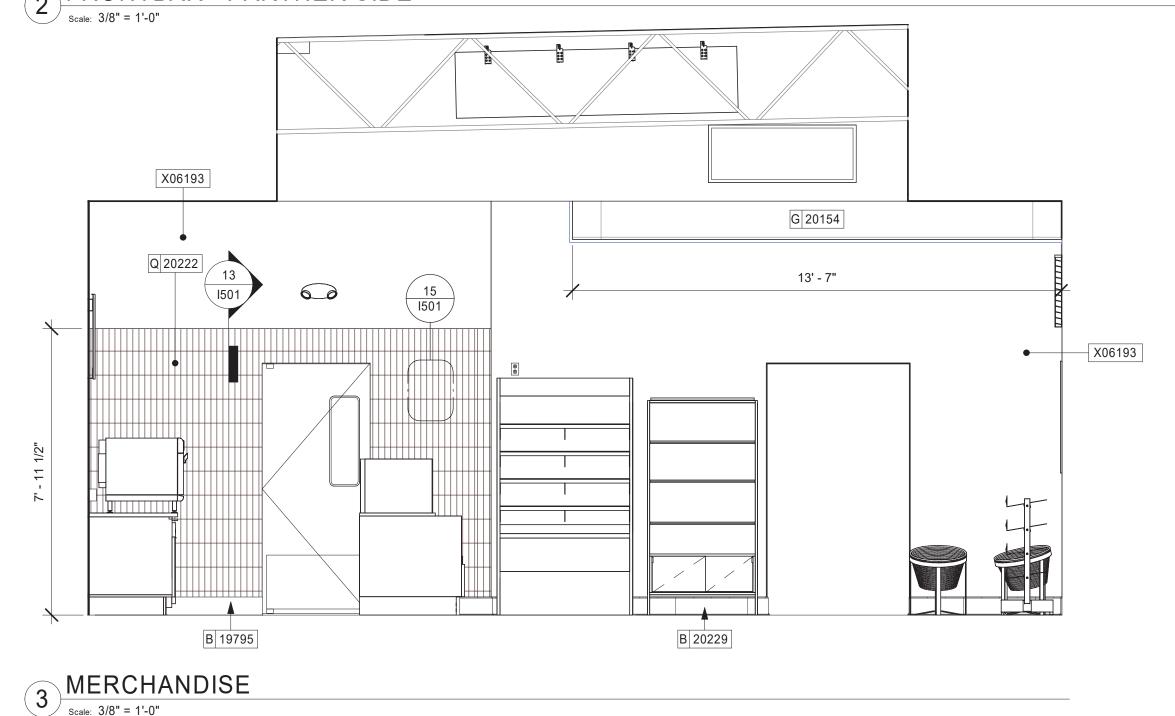

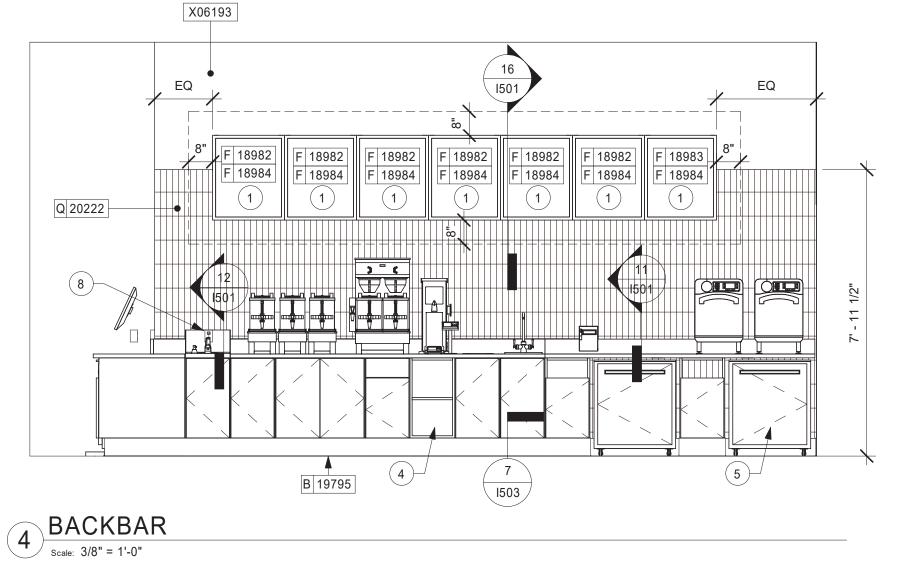

KEYED NOTES

- 1. ATTACH MENU BOARDS PER INSTALLATION DETAILS. 3/4" PLYWOOD BACKER TO BE ADDED BEHIND WALL FINISHES FOR FUTURE DIGITAL MENU BOARDS. PLYWOOD TO EXTEND 8" AROUND ALL SIDES OF THE MENU BOARDS. SEE ELECTRICAL FOR ADDITIONAL INFORMATION
- 2. METAL TILE BASE LOCATED AT FRONTBAR ON CAFE SIDE
- 3. CUP DISPENSERS. SEE FF & E PLAN ON SHEET I101 FOR ADDITIONAL INFORMATION.
- 4. FRP BENEATH BACK BAR AT EXPOSED WALLS EXCEPT AT WARMING STATION. EXTEND FROM TOP OF WALL BASE TO UNDERSIDE OF COUNTERTOP.
- 5. WALL TILE TO EXTEND BELOW WARMING STATION TO TOP OF WALL BASE.
- 6. LED LIGHT STRIP UNDER COUNTER.
- 7. PENDANT LIGHT FIXTURE (SEE REFLECTED CEILING PLAN ON SHEET I103 AND LIGHTING PLAN ON SHEET E102 FOR ADDITIONAL INFORMATION).
- 8. PROVIDE 6" (150MM) MIN. INTEGRAL SPLASHGUARD AT HAND SINK PER JURISDICTIONAL REQUIREMENTS.
- 9. SNEEZE GUARD.
- 10. CUSTOM FOOT RAIL.

GENERAL NOTES

- A. FOR PAINT AND WALL TREATMENT SCHEDULES, REFER TO THE INTERIOR FINISH PLAN ON SHEET I104. FOR GRAPHICS SCHEDULE, REFER TO THE FURNITURE, FIXTURES, AND EQUIPMENT (FF & E) SCHEDULES ON SHEET I101.
- B. REFER TO MANUFACTURER'S INSTRUCTIONS INCLUDED WITH ARTWORK/GRAPHICS FOR PROPER INSTALLATION.
- C. PAINT FINISHES SHALL BE APPLIED AS FOLLOWS, UNLESS NOTED OTHERWISE:
- 1) WOODS AND METAL SURFACES SHALL BE
- SEMI-GLOSS OR EQUAL. 2) ACCENT AND TRIM PAINTS TO BE SEMI-GLOSS OR
- a. WALL AND CEILING PAINTS TO BE EGGSHELL OR
- EQUAL. 3) PAINTS IN BOH, RESTROOM(S) OR CAFE BAR SHALL BE SEMI-GLOSS OR EQUAL.
- D. FLOORS, WALLS AND CEILING FINISHES IN FOOD PREPARATION AREAS SHALL BE SMOOTH, NON-TOXIC, NON-ABSORBENT, DURABLE AND EASILY CLEANABLE. PAINT SHALL BE WASHABLE; SEMI-GLOSS OR HIGH GLOSS FINISH.
- E. ALL WOOD SURFACES (DOORS, TRIM, SHELVES, CABINETRY) SHALL BE SEALED.
- F. ALIGN TILE TRANSITIONS ON WHOLE TILES AS SHOWN.
- G. ALL FLOOR AND WALL JUNCTIONS IN STORAGE AND FOOD PREPARATION AREAS SHALL HAVE A 6" COVED
- H. ALL FOOD STORAGE SHALL BE 6" (150MM) A.F.F.
- I. INSTALL BLOCKING AND HANGERS FOR WALL SHELVING BEFORE INSTALLING BACK BAR TILE.



© 2018 STARBUCKS COFFEE COMPANY

STARBUCKS® 2401 UTAH AVENUE SOUTH

SEATTLE, WASHINGTON 98134 (206) 318-1575

THESE DRAWINGS AND THE PROJECT MANUAL ARE CONFIDENTIAL AND SHALL REMAIN THE SOLE PROPERTY OF STARBUCKS CORPORATION, WHICH IS THE OWNER OF THE COPYRIGHT IN THIS WORK. THEY SHALL NOT BE REPRODUCED (IN WHOLE OR IN PART), SHARED WITH THIRD PARTIES OR USED IN ANY MANNER ON OTHER PROJECTS OR

EXTENSIONS TO THIS PROJECT WITHOUT THE PRIOR WRITTEN CONSENT OF STARBUCKS CORPORATION. THESE DRAWINGS AND SPECIFICATIONS ARE INTENDED TO EXPRESS DESIGN INTENT FOR A PROTOTYPICAL STARBUCKS STORE (WHICH IS SUBJECT TO CHANGE AT ANYTIME) AND DO NOT REFLECT

ACTUAL SITE CONDITIONS. NEITHER PARTY SHALL HAVE ANY OBLIGATION NOR LIABILITY TO THE OTHER (EXCEPT STATED ABOVE) UNTIL A WRITTEN AGREEMENT IS FULLY EXECUTED BY BOTH PARTIES.


STARBUCKS TEMPLATE VERSION i2019.05.31



Professional Corporation

520 SOUTH MAIN ST, SUITE 2531 AKRON, OH 44311 P: 330-572-2100 F: 330-572-2101

GPD PROJECT NO: 2019355.03

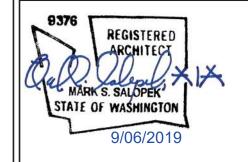


PROJECT ADDRESS:
2418 136TH COURT E
SUMNER, WA 98390

59603 STORE #: PROJECT #: 83746-001 ISSUE DATE:

DESIGN MANAGER: NORIKO TANAKA PRODUCTION DESIGNER: GUY RIPLEY CHECKED BY: TOM CONNER

INTERIOR FINISH ELEVATIONS SCALE: AS SHOWN

SHEET NUMBER:

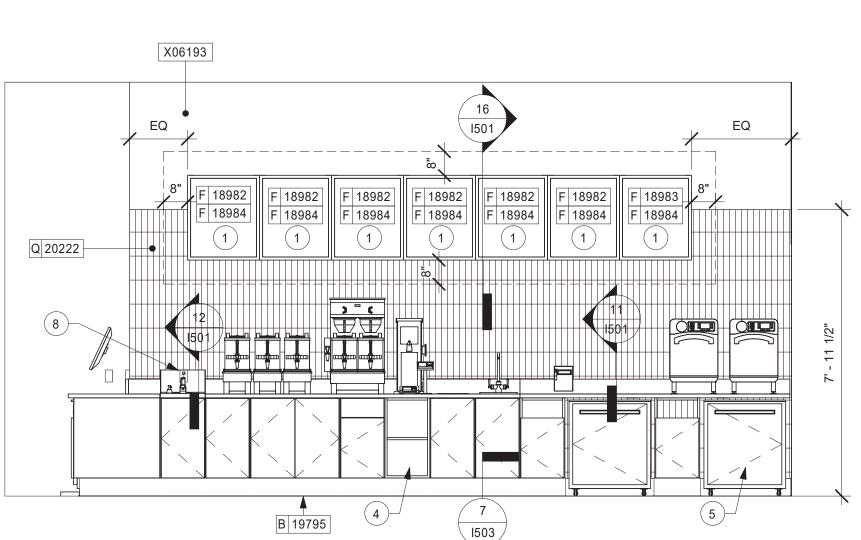


1503

WORKROOM

| Scale: 3/8" = 1'-0"






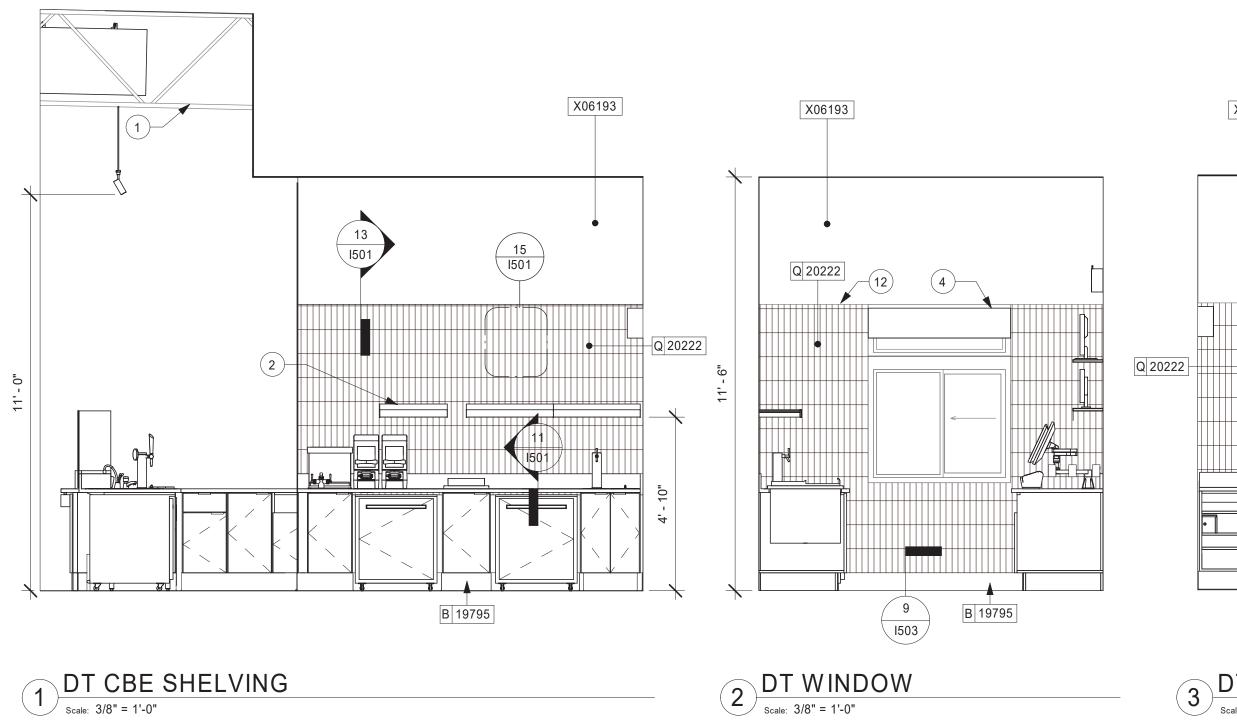

Q 11469

E501 /

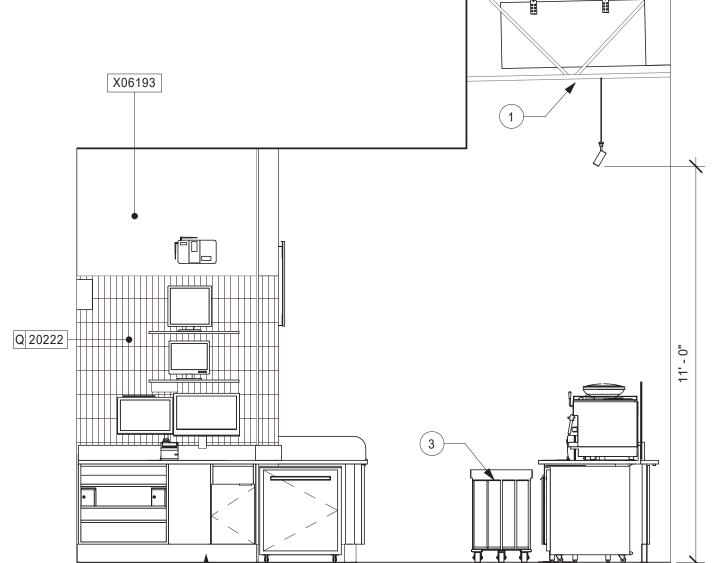

B 19795

KEYED NOTES

- 1. EXPOSED STRUCTURE AND DUCTWORK TO BE PAINTED
- 2. SHELVING FOR CBE STATION AS SHOWN. G.C. TO PROVIDE WALL BLOCKING FOR FASTENERS.
- 3. CUP DISPENSERS. SEE FF & E PLAN ON SHEET I101 FOR ADDITIONAL INFORMATION.
- 4. INSTALL DT AIR CURTAIN AS REQUIRED
- 5. WALL MOUNT HAND SINK WITH SOAP AND PAPER TOWEL DISPENSER. G.C. TO PROVIDE BLOCKING FOR FASTENERS.
- 6. ICE MACHINE (SEE PLUMBING AND ELECTRICAL DRAWINGS FOR ADDITIONAL INFORMATION).
- 7. WATER HEATER ABOVE (SEE PLUMBING DRAWINGS).
- 8. MANAGER'S DESK (SEE ENLARGED DETAILS).
- 9. ELECTRICAL PANELS (SEE ELECTRICAL DRAWINGS FOR ADDITIONAL INFORMATION).
- 10. WATER FILTRATION EQUIPMENT (SEE PLUMBING DRAWINGS).
- 11. PLACE FOR FIRE EXTINGUISHER PER FIRE INSPECTOR'S REQUIREMENTS
- 12. ALIGN TOP OF TILE WITH TOP OF DT WINDOW, TILE HEIGHT TO BE CONSISTENT THROUGH ENGINE

GENERAL NOTES

- A. FOR PAINT AND WALL TREATMENT SCHEDULES, REFER TO THE INTERIOR FINISH PLAN ON SHEET I104. FOR GRAPHICS SCHEDULE, REFER TO THE FURNITURE, FIXTURES, AND EQUIPMENT (FF & E) SCHEDULES ON SHEET I101.
- B. REFER TO MANUFACTURER'S INSTRUCTIONS INCLUDED WITH ARTWORK/GRAPHICS FOR PROPER INSTALLATION.
- C. PAINT FINISHES SHALL BE APPLIED AS FOLLOWS,
- UNLESS NOTED OTHERWISE: 1) WOODS AND METAL SURFACES SHALL BE
- SEMI-GLOSS OR EQUAL. 2) ACCENT AND TRIM PAINTS TO BE SEMI-GLOSS OR
- a. WALL AND CEILING PAINTS TO BE EGGSHELL OR
- EQUAL.
- 3) PAINTS IN BOH, RESTROOM(S) OR CAFE BAR SHALL BE SEMI-GLOSS OR EQUAL.
- D. FLOORS, WALLS AND CEILING FINISHES IN FOOD PREPARATION AREAS SHALL BE SMOOTH, NON-TOXIC, NON-ABSORBENT, DURABLE AND EASILY CLEANABLE. PAINT SHALL BE WASHABLE; SEMI-GLOSS OR HIGH GLOSS FINISH.
- E. ALL WOOD SURFACES (DOORS, TRIM, SHELVES, CABINETRY) SHALL BE SEALED.
- F. ALIGN TILE TRANSITIONS ON WHOLE TILES AS SHOWN.
- G. ALL FLOOR AND WALL JUNCTIONS IN STORAGE AND FOOD PREPARATION AREAS SHALL HAVE A 6" COVED
- H. ALL FOOD STORAGE SHALL BE 6" (150MM) A.F.F.
- I. INSTALL BLOCKING AND HANGERS FOR WALL SHELVING BEFORE INSTALLING BACK BAR TILE.



STARBUCKS[®]

2401 UTAH AVENUE SOUTH SEATTLE, WASHINGTON 98134

(206) 318-1575 THESE DRAWINGS AND THE PROJECT MANUAL

ARE CONFIDENTIAL AND SHALL REMAIN THE SOLE PROPERTY OF STARBUCKS CORPORATION, WHICH IS THE OWNER OF THE COPYRIGHT IN THIS WORK. THEY SHALL NOT BE REPRODUCED (IN WHOLE OR IN PART), SHARED WITH THIRD PARTIES OR USED IN ANY MANNER ON OTHER PROJECTS OR EXTENSIONS TO THIS PROJECT WITHOUT THE

PRIOR WRITTEN CONSENT OF STARBUCKS CORPORATION. THESE DRAWINGS AND SPECIFICATIONS ARE INTENDED TO EXPRESS DESIGN INTENT FOR A PROTOTYPICAL STARBUCKS STORE (WHICH IS SUBJECT TO CHANGE AT ANYTIME) AND DO NOT REFLECT ACTUAL SITE CONDITIONS. NEITHER PARTY

SHALL HAVE ANY OBLIGATION NOR LIABILITY TO THE OTHER (EXCEPT STATED ABOVE) UNTIL A WRITTEN AGREEMENT IS FULLY EXECUTED BY BOTH PARTIES.


STARBUCKS TEMPLATE VERSION i2019.05.31



Professional Corporation

520 SOUTH MAIN ST, SUITE 2531 AKRON, OH 44311 P: 330-572-2100 F: 330-572-2101

GPD PROJECT NO: 2019355.03

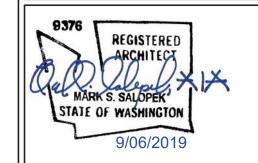

PROJECT ADDRESS:
2418 136TH COURT E
SUMNER, WA 98390

59603 STORE #: PROJECT #: 83746-001


ISSUE DATE: **DESIGN MANAGER:** NORIKO TANAKA PRODUCTION DESIGNER: GUY RIPLEY CHECKED BY: TOM CONNER


Revision Schedule

INTERIOR FINISH ELEVATIONS SCALE: AS SHOWN

SHEET NUMBER:


1203

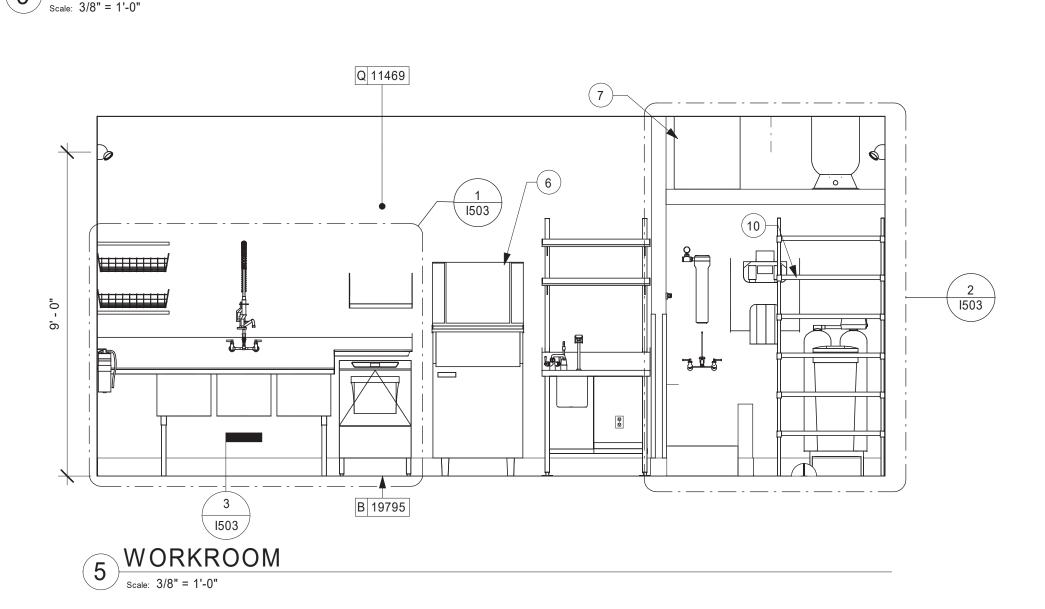

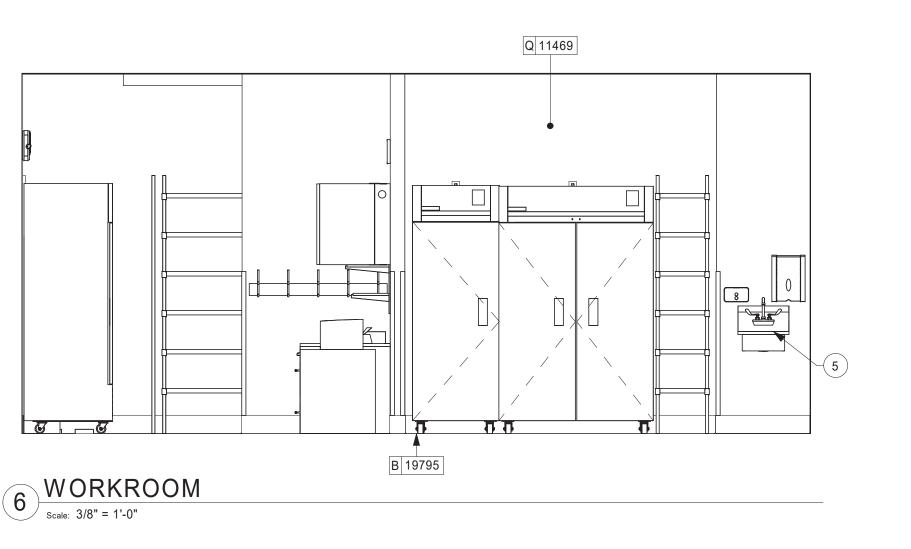


Q 11469

B 19795

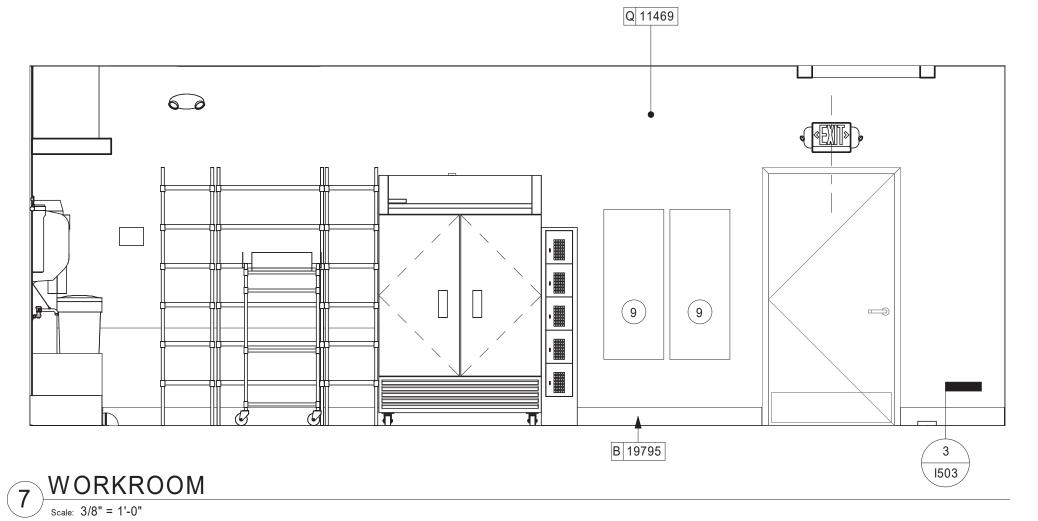

3 1503 Scale: 3/8" = 1'-0"

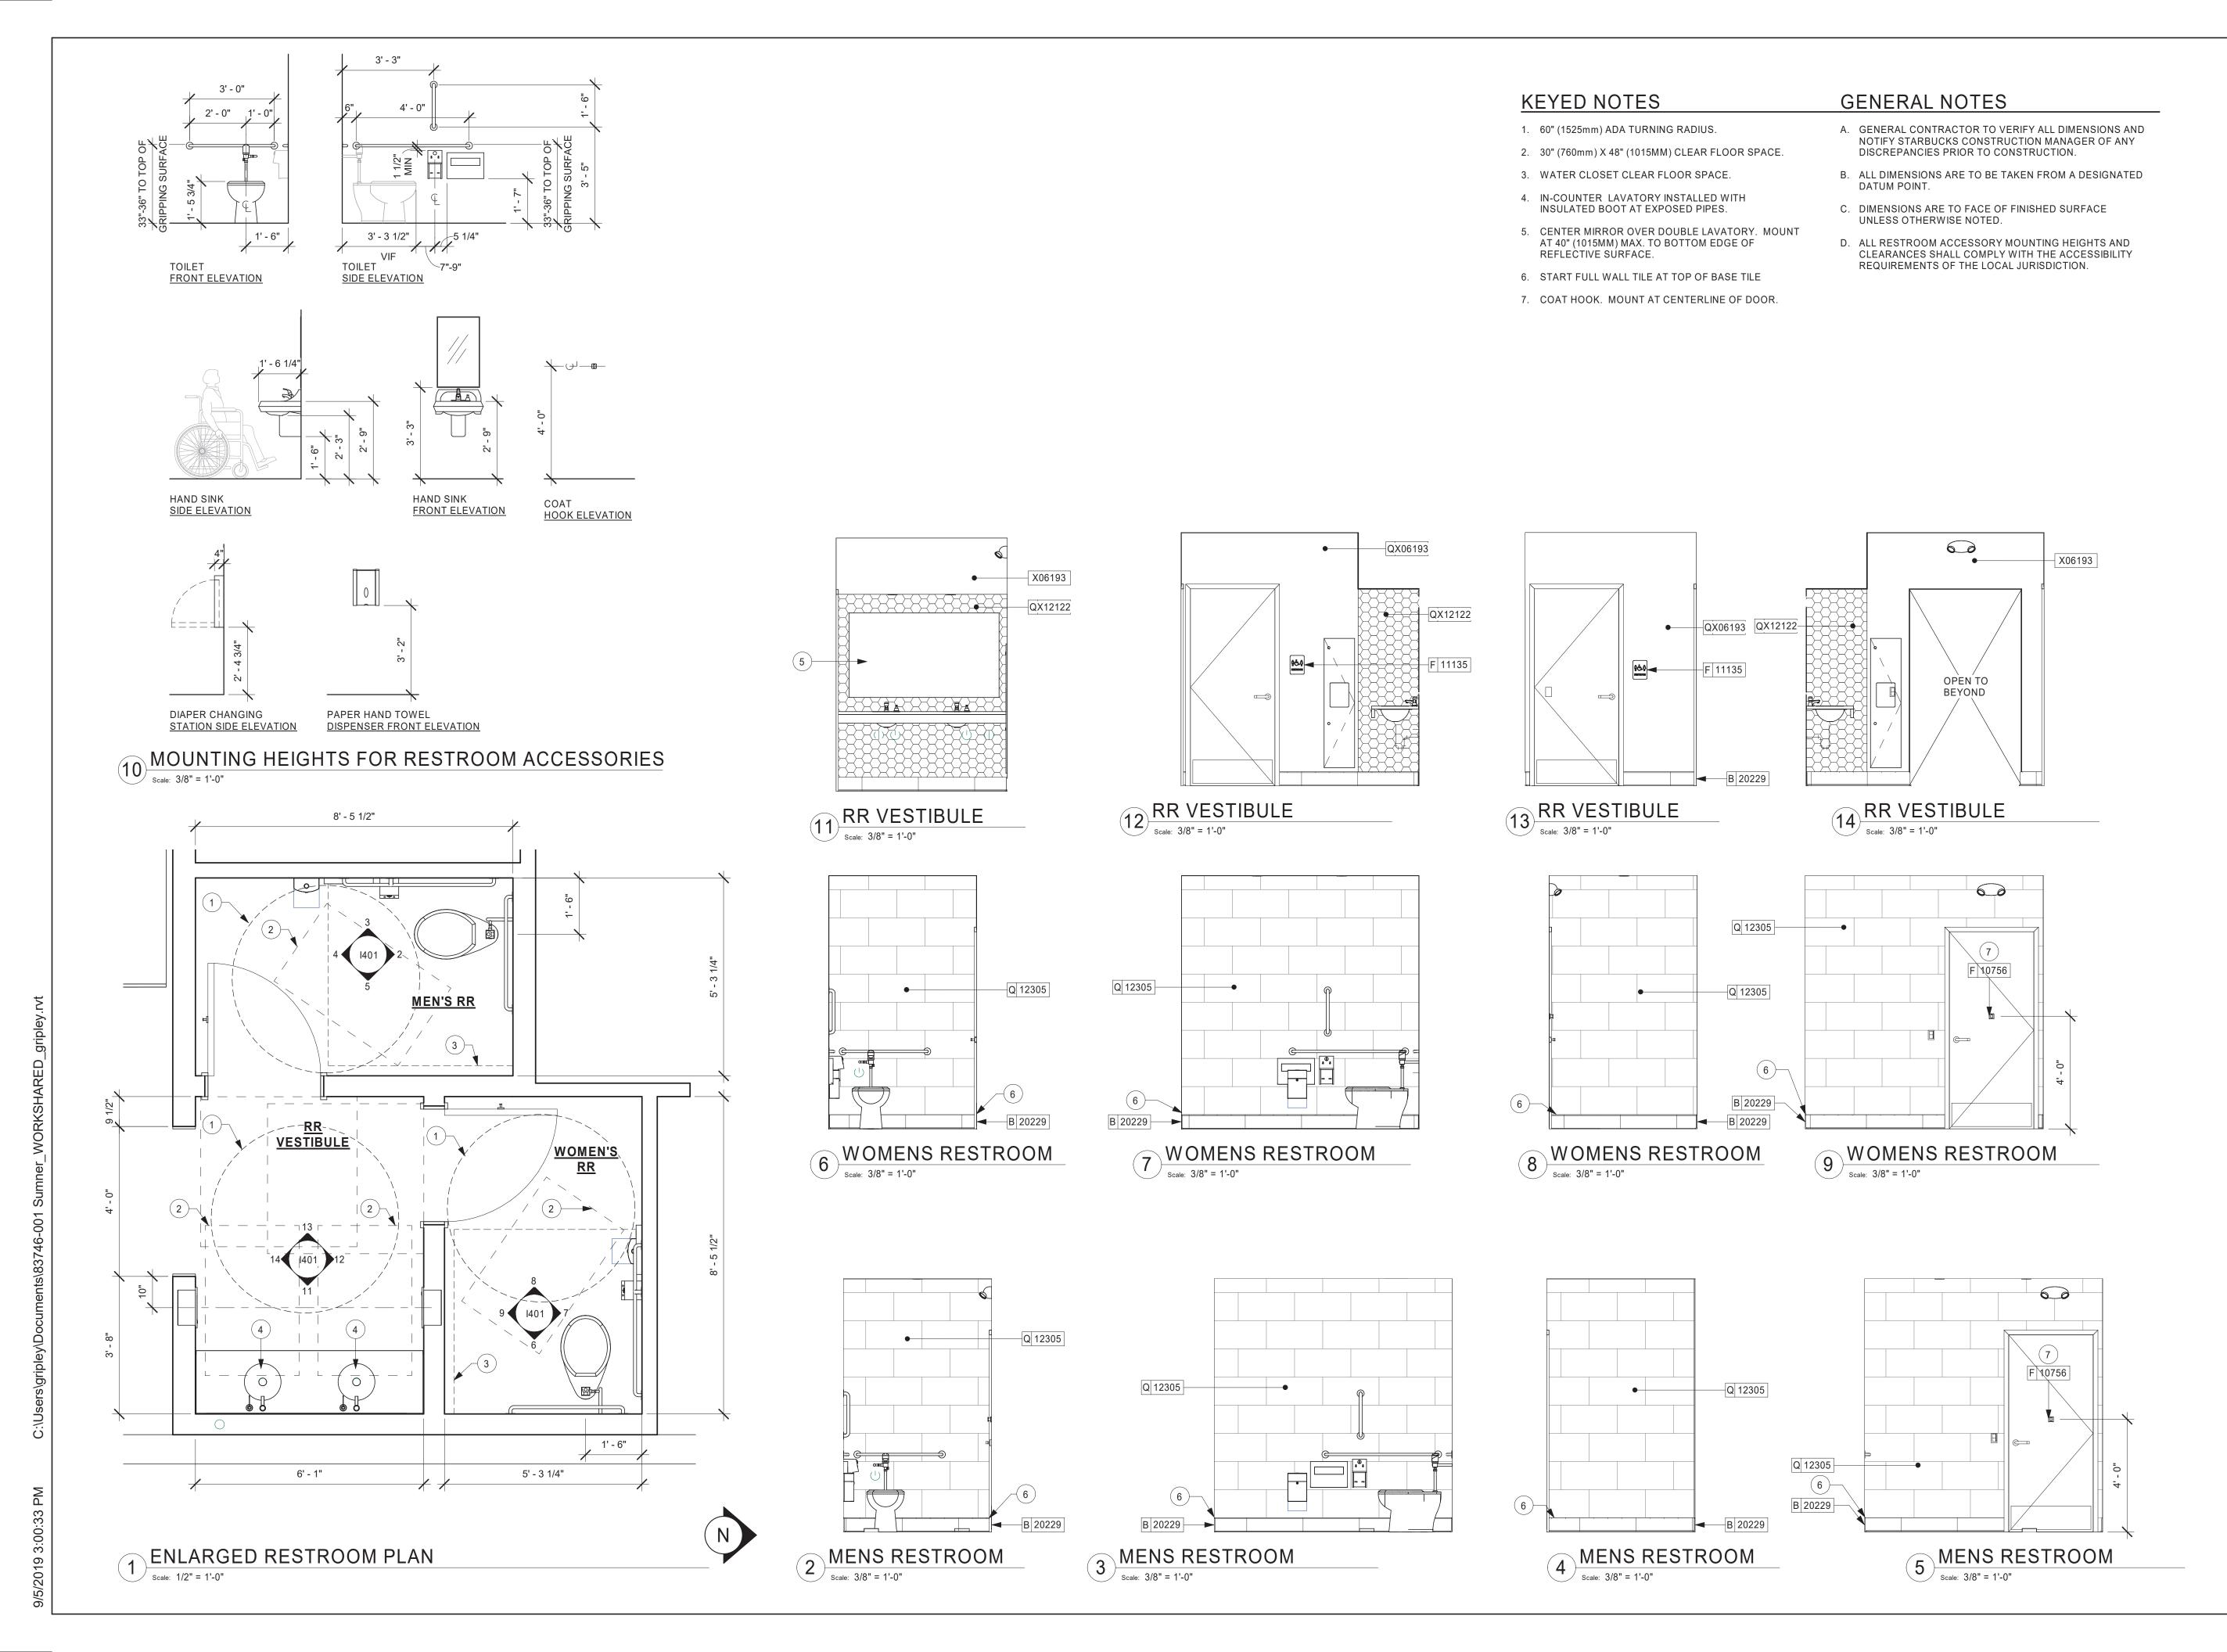



STARBUCKS®

2401 UTAH AVENUE SOUTH SEATTLE, WASHINGTON 98134 (206) 318-1575

THESE DRAWINGS AND THE PROJECT MANUAL ARE CONFIDENTIAL AND SHALL REMAIN THE SOLE PROPERTY OF STARBUCKS CORPORATION, WHICH IS THE OWNER OF THE COPYRIGHT IN THIS WORK. THEY SHALL NOT BE REPRODUCED (IN WHOLE OR IN PART), SHARED WITH THIRD PARTIES OR USED IN ANY MANNER ON OTHER PROJECTS OR EXTENSIONS TO THIS PROJECT WITHOUT THE

PRIOR WRITTEN CONSENT OF STARBUCKS CORPORATION. THESE DRAWINGS AND SPECIFICATIONS ARE INTENDED TO EXPRESS DESIGN INTENT FOR A PROTOTYPICAL STARBUCKS STORE (WHICH IS SUBJECT TO CHANGE AT ANYTIME) AND DO NOT REFLECT ACTUAL SITE CONDITIONS. NEITHER PARTY SHALL HAVE ANY OBLIGATION NOR LIABILITY TO THE OTHER (EXCEPT STATED ABOVE) UNTIL A WRITTEN AGREEMENT IS FULLY EXECUTED BY BOTH PARTIES.

STARBUCKS TEMPLATE VERSION i2019.05.31



Professional Corporation

520 SOUTH MAIN ST, SUITE 2531 AKRON, OH 44311 P: 330-572-2100 F: 330-572-2101

GPD PROJECT NO: 2019355.03



PROJECT ADDRESS:
2418 136TH COURT E
SUMNER, WA 98390

59603

STORE #: PROJECT #:

167/24

83746-001 SUBMITTAL 9.6.19 ISSUE DATE: DESIGN MANAGER: NORIKO TANAKA

PRODUCTION DESIGNER: GUY RIPLEY CHECKED BY: TOM CONNER



RESTROOM PLAN & ELEVATIONS SCALE: AS SHOWN

SHEET NUMBER: